General Notes.

All construction shall be carried out in accordance with NZBC, and NZS 3604:2011 + Amendments. Aswell to comply with any local authority bylaws.

Corrosion Zone 1,2,3,4: Durability of fixings to comply with NZS 3604:2011 Section 4 and NZBC B2/AS1

ALL FIXINGS SUBJECT TO WEATHERING TO BE STAINLESS STEEL

Building Notes.

INTERIOR WALLS. NZS3604-2011 Table 8.2 -90x45mm H1.2 SG8 interior non loadbearing walls, 2740mm high. Studs @ 600crs

EXTERIOR WALLS. NZS3604-2011 Table 8.2 -90x45mm H1.2 SG8 Exterior walls, 2740mm high. Studs @ 400crs

-Double Glazing to living areas. Safety glass to comply with NZS4223.

-0.40mm BMT Diamond BB900 COLORSTEEL ENDURA Vertical Cladding Direct Fixed. NOGS @ 800 CRS (Alt. Solution)

10,000

-Selected Vertical Shiplap Cedar on 20mm Drained Cavity NOGS @ 480 CRS


-0.40mm BMT Diamond BB900 COLORSTEEL ENDURA roofing

-Wind Zone - HIGH

BUILDING ENVELOPE RISK MATRIX				
North Elevation				
Risk Severity	Risk Score			
High risk	1			
Low risk	0			
High risk	3			
Very high risk	5			
Medium risk	1			
Low risk	0			
	10			
	vation Risk Severity High risk Low risk High risk Very high risk Medium risk			

Floor Plan

Scale 1:100

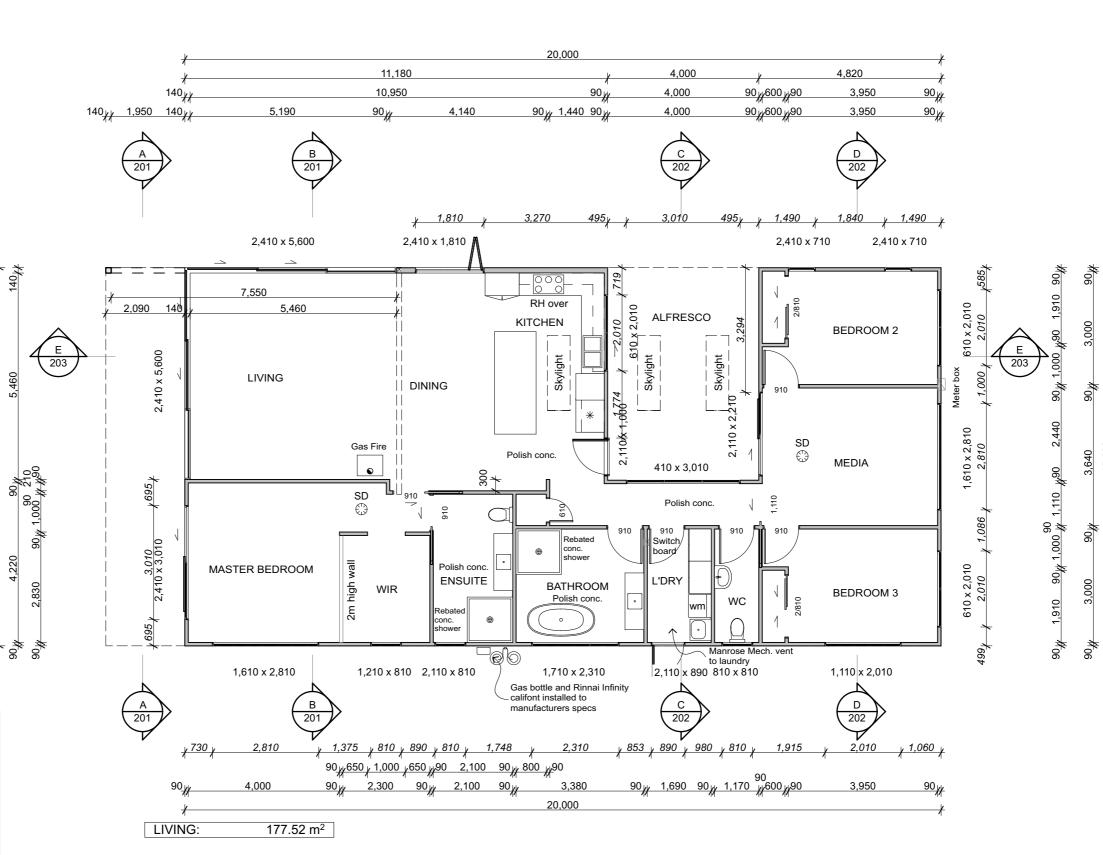




10,000

Plumbing and Drainage Notes.

All work to comply with NZBC, NZS3604 and all relevant local authority by laws and council regulations.

All drainage to comply with AS/NZS 3500 & NZBC G13

All drainage is Diagramatical, Drainlayer to determine on site drainage layout and provide asbuilt plan when complete.

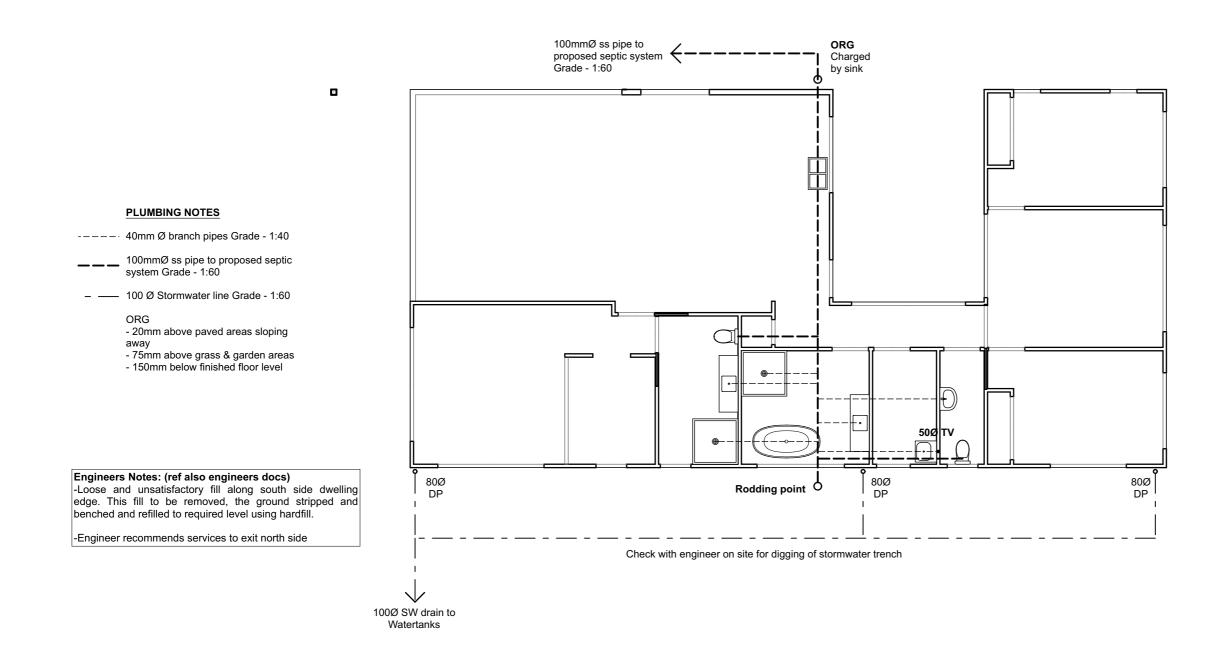



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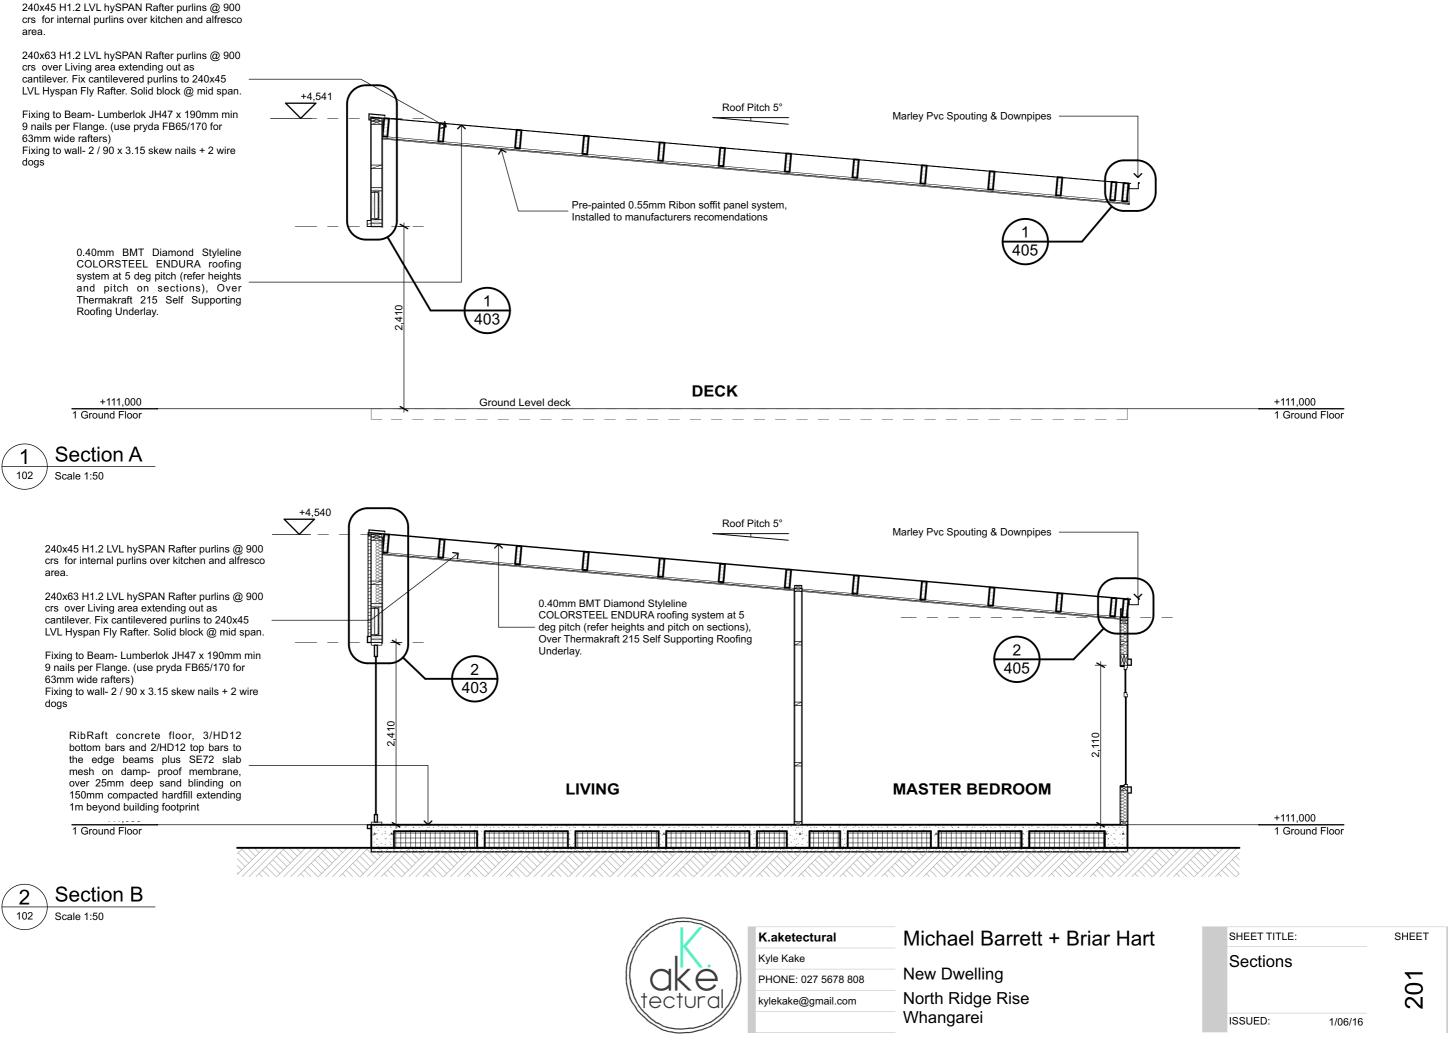
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90


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Plumbing Plan

ISSUED:







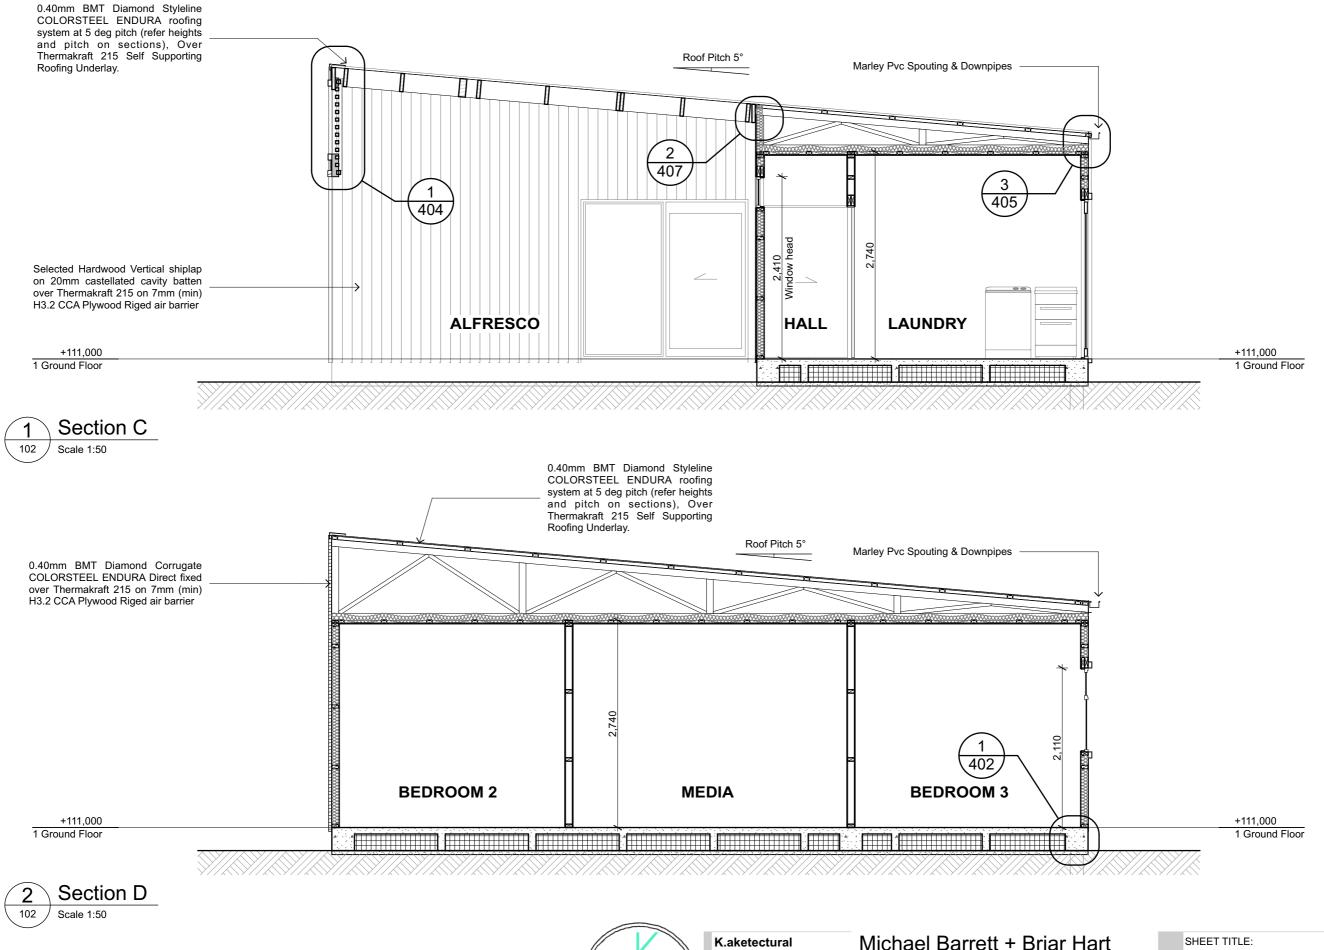

New Dwelling


North Ridge Rise Whangarei


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Sections 2

ISSUED:



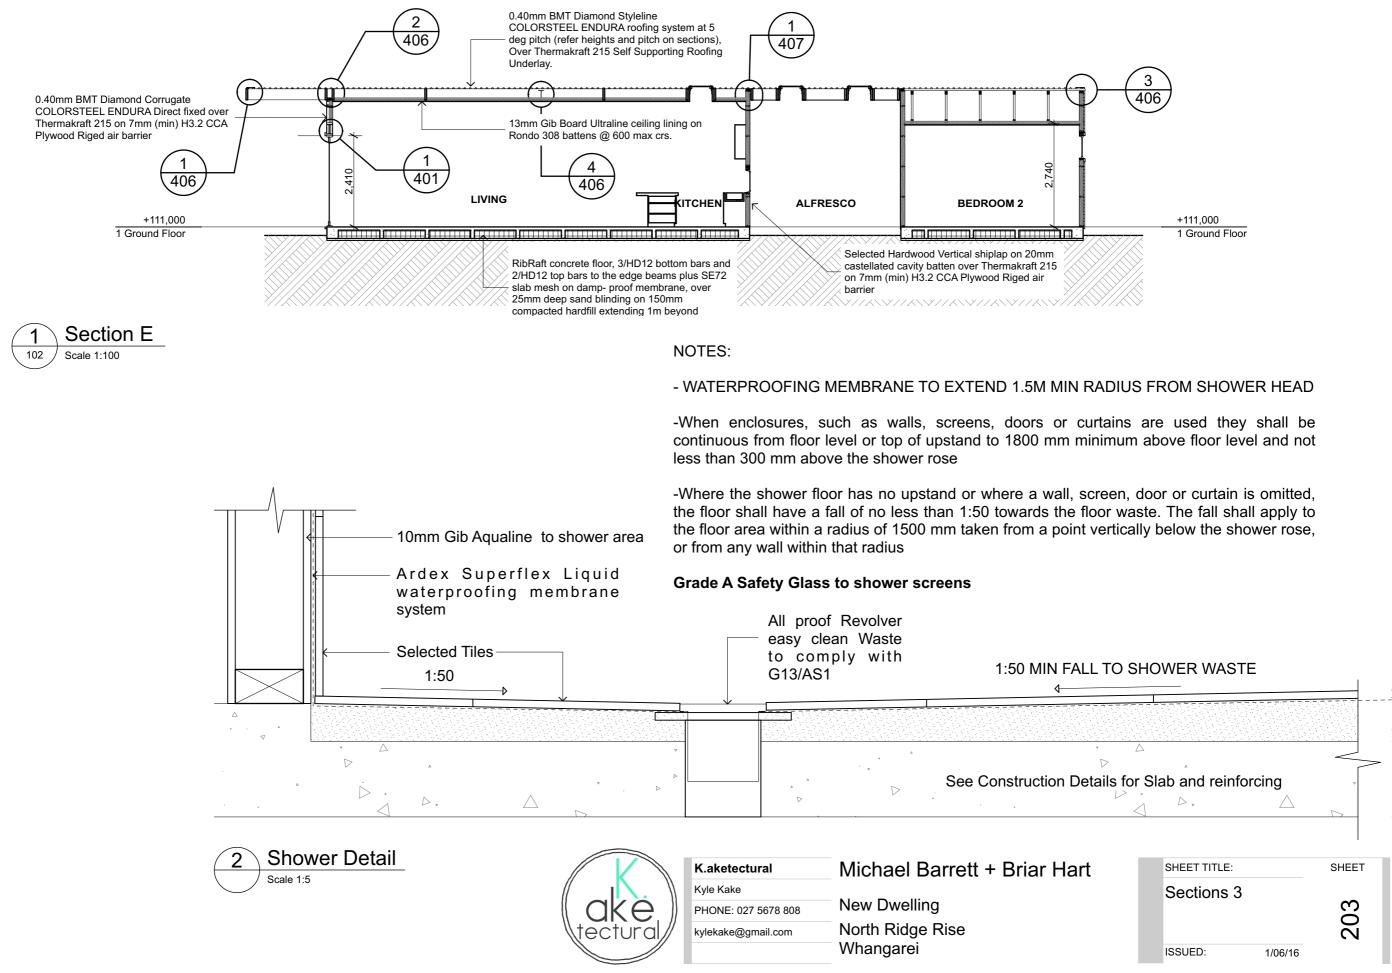


Finished Floor to Ground levels:

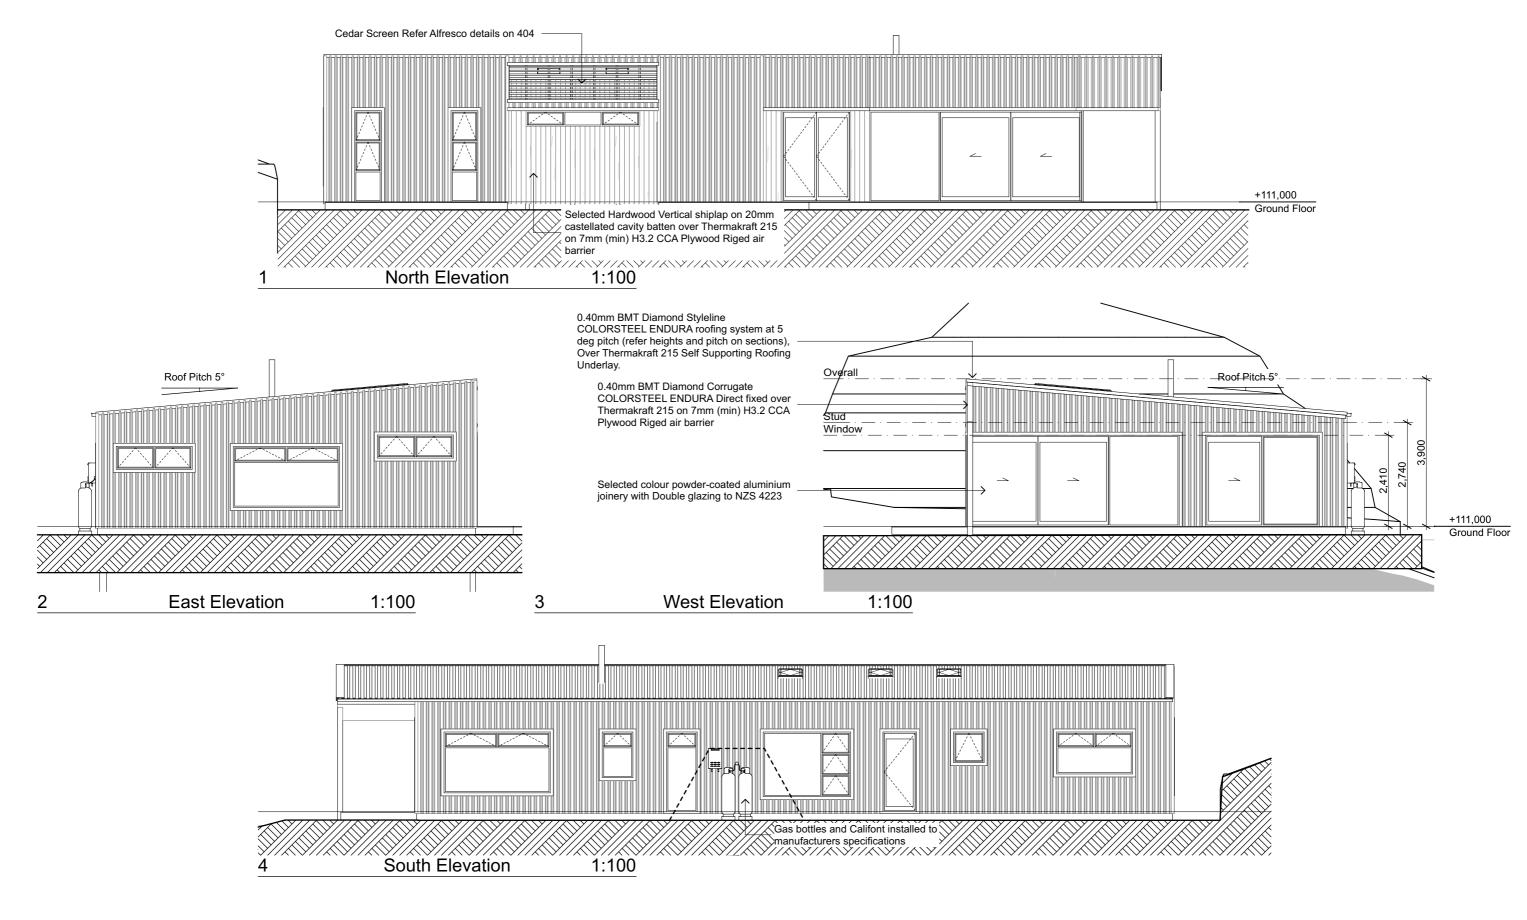
To unprotected ground 225mm min. To Permanent paving 150mm min.





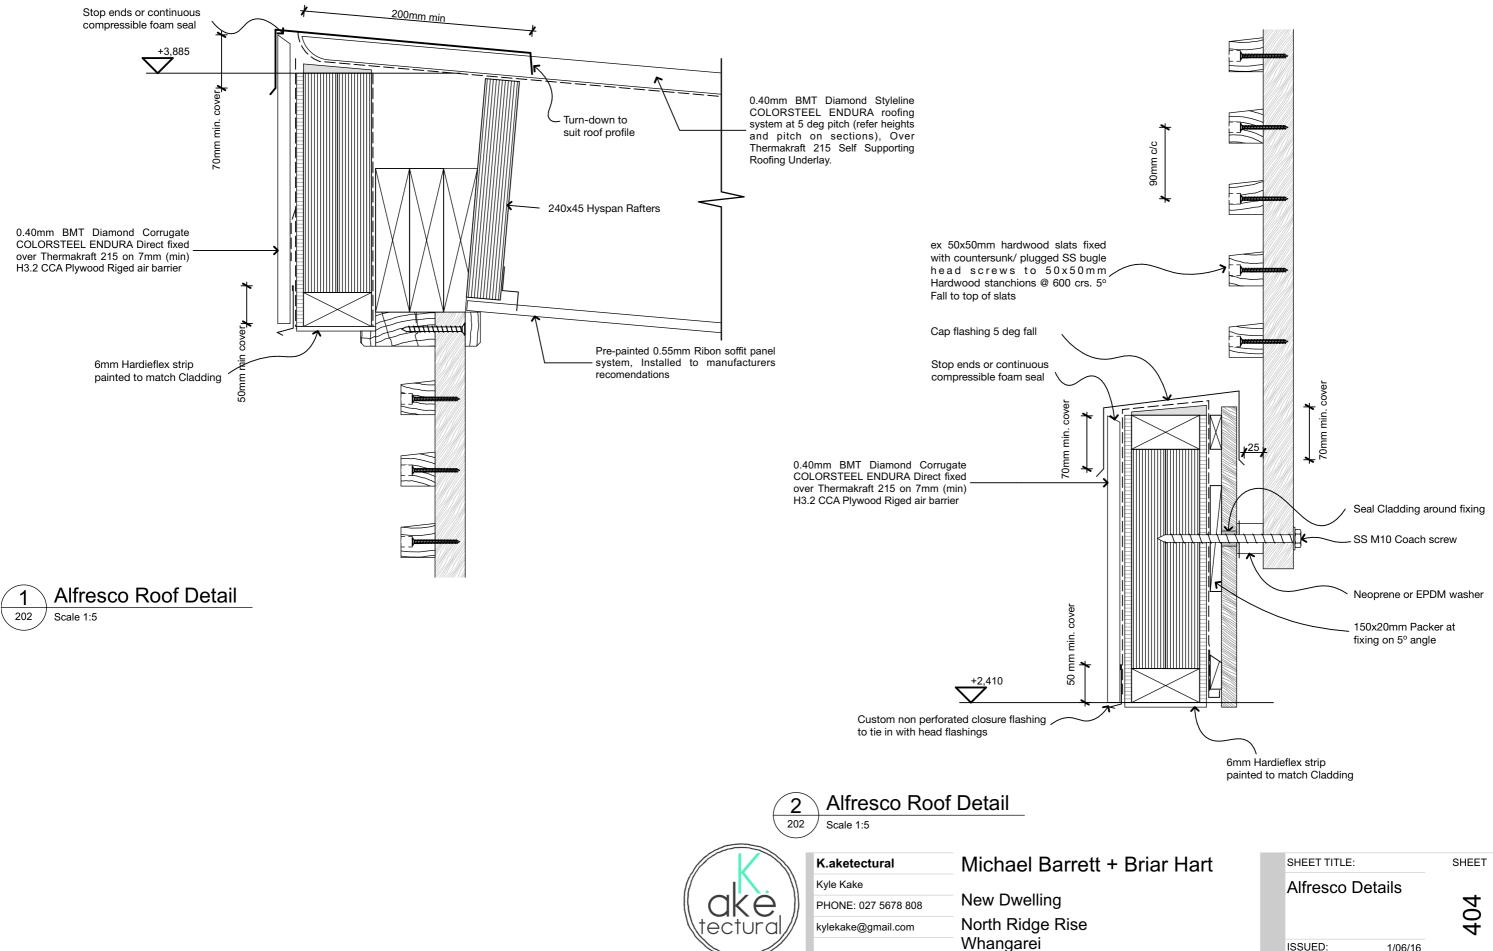

ISSUED:

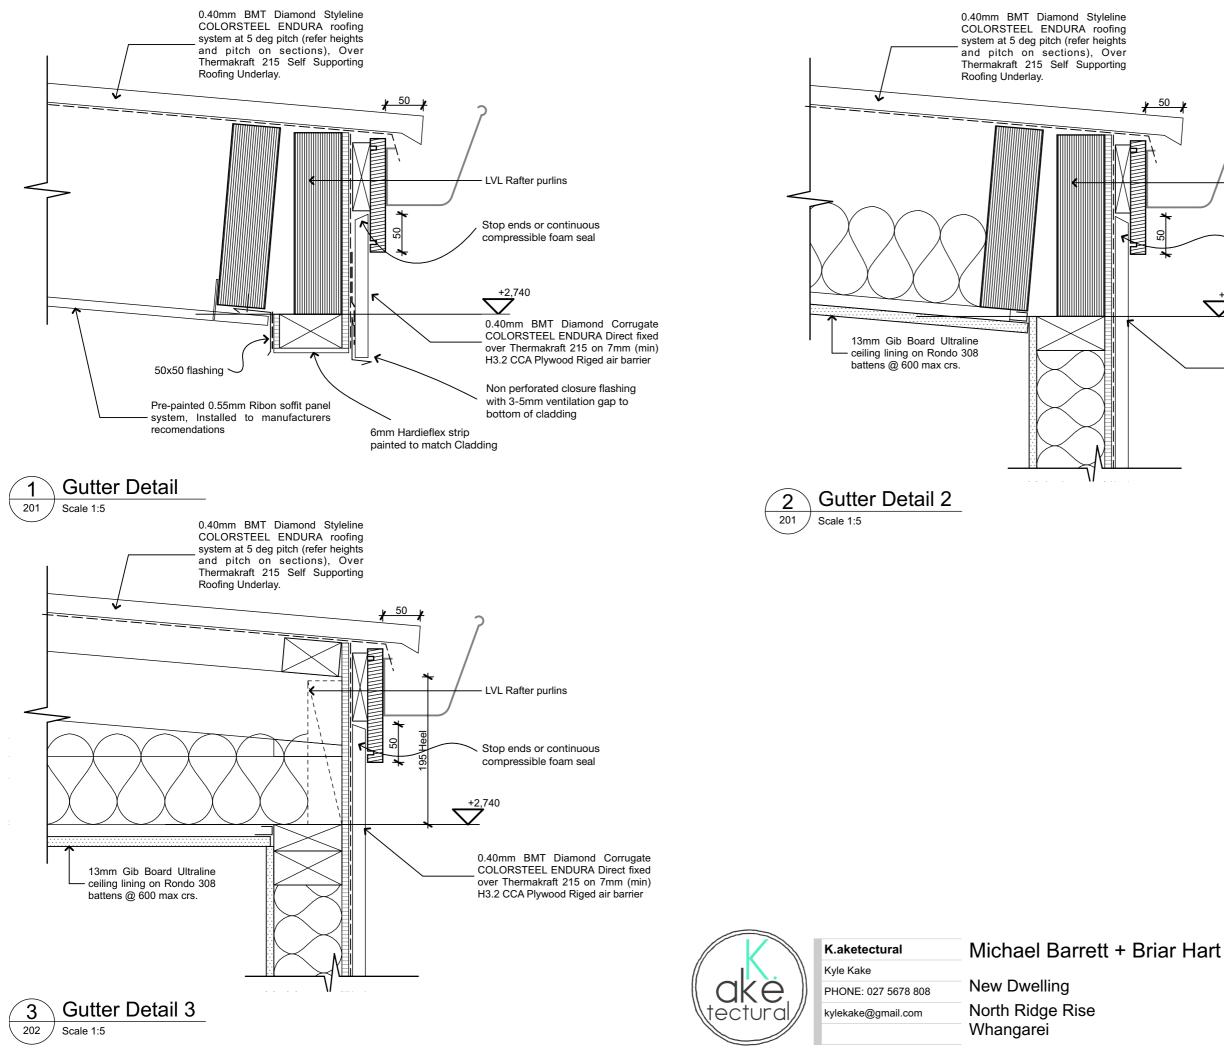

- LVL Rafter purlins Stop ends or continuous compressible foam seal

+2,740

0.40mm BMT Diamond Corrugate COLORSTEEL ENDURA Direct fixed over Thermakraft 215 on 7mm (min) H3.2 CCA Plywood Riged air barrier


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Gutter Details

405

ISSUED:



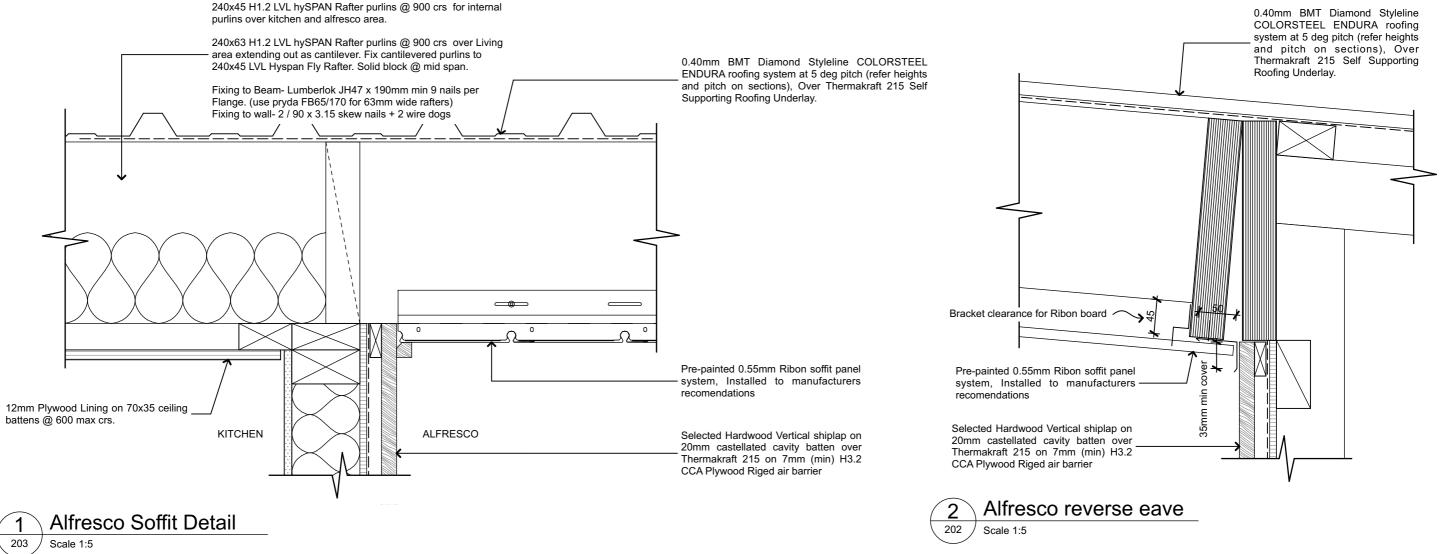



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CORRUGATE/ SHIPLAP VERTICAL JUNCTION - 1:5



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SHEET TITLE:

Cladding Junctions

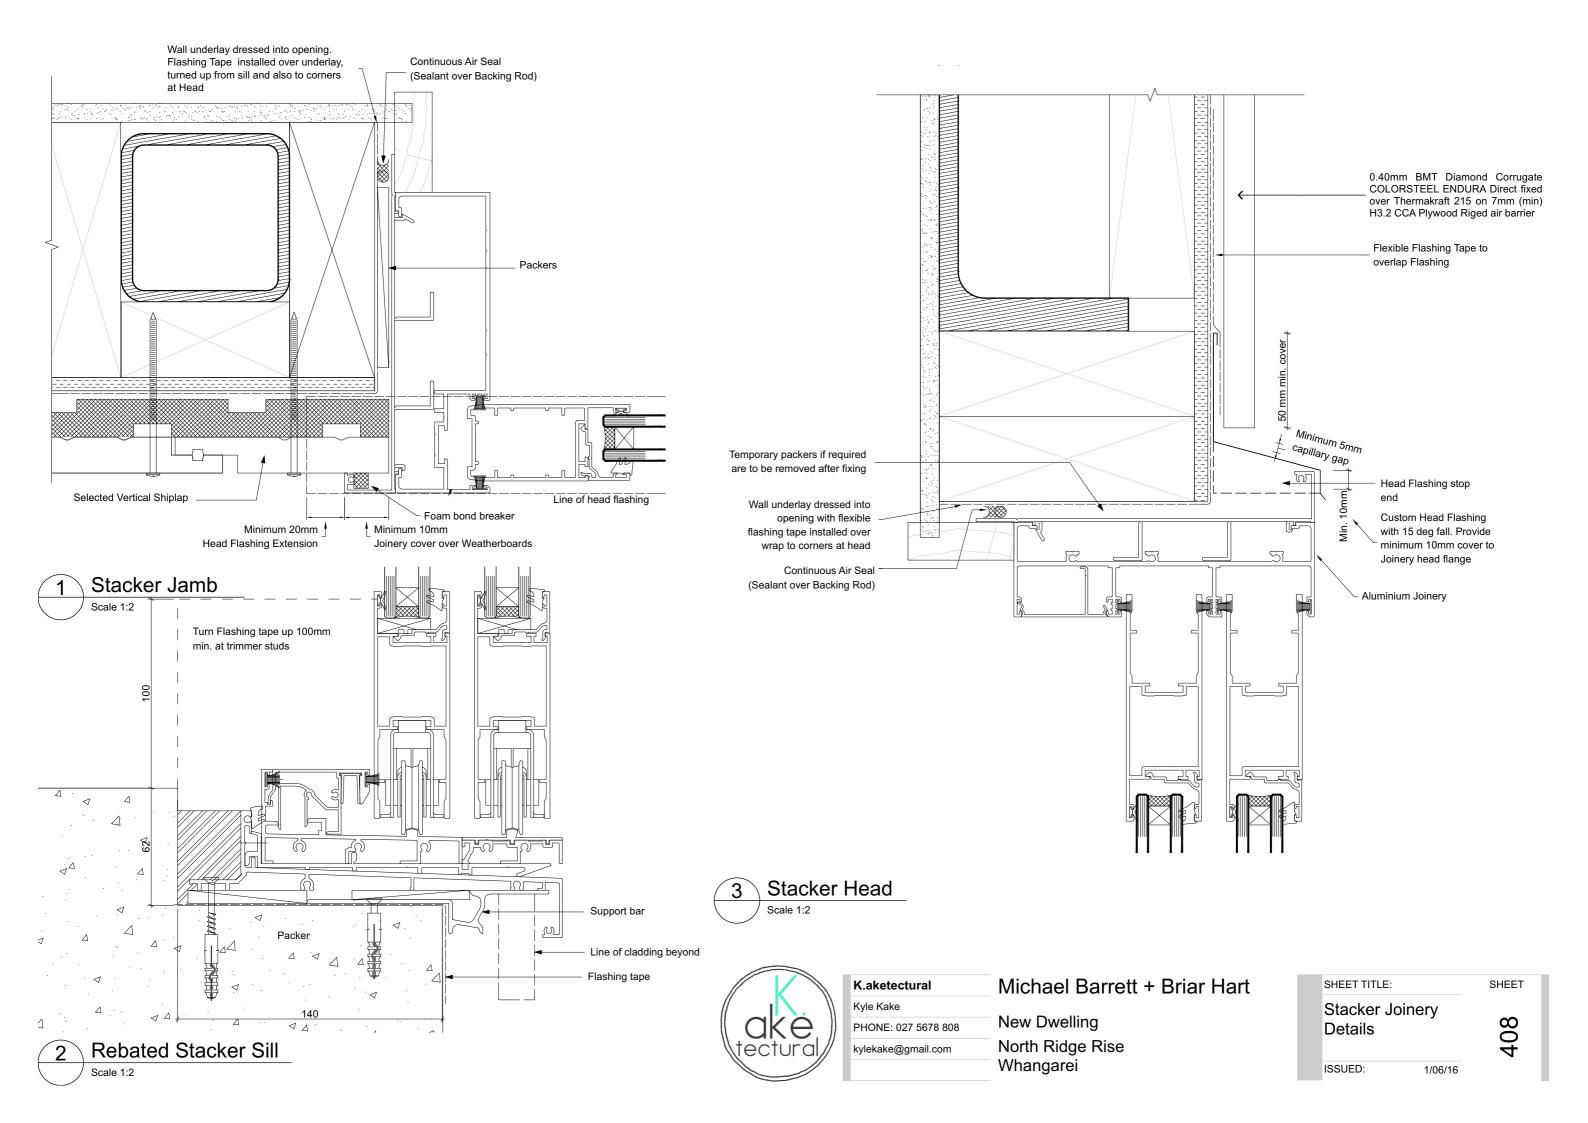SHEET

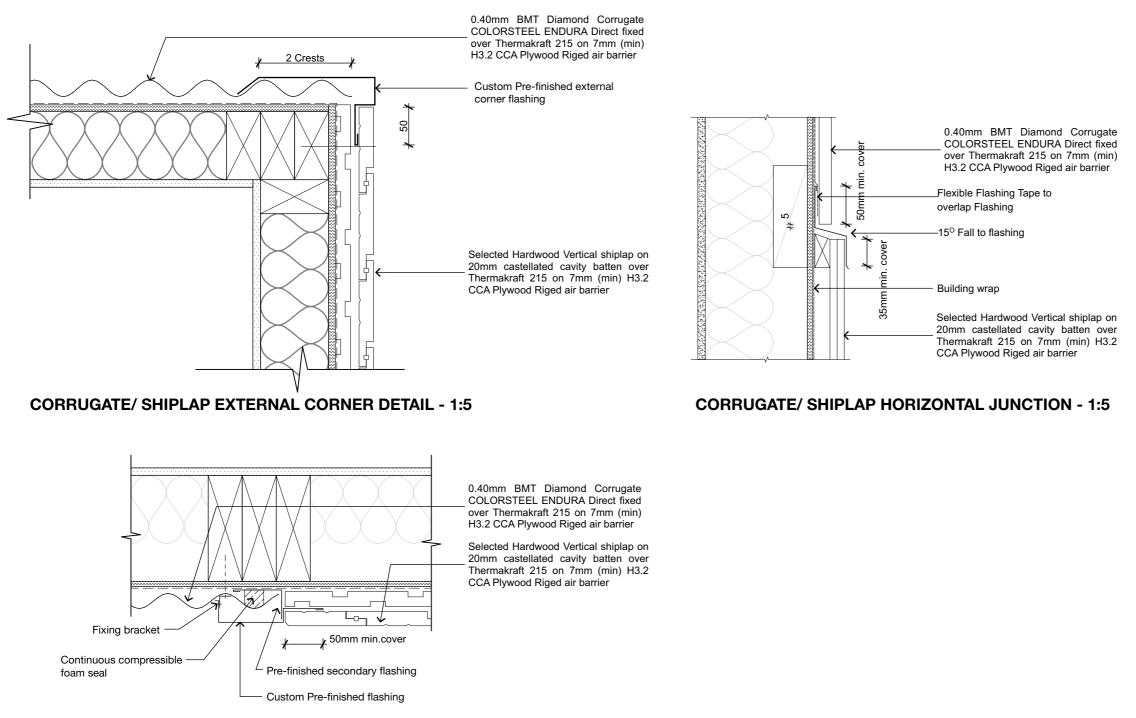
409

ISSUED:

CERTCLAD Vertical Shiplap with Rigid Air Barrier Weatherboards Cavity System

Fixing Stained Weatherboards with Packer Cavity Battens




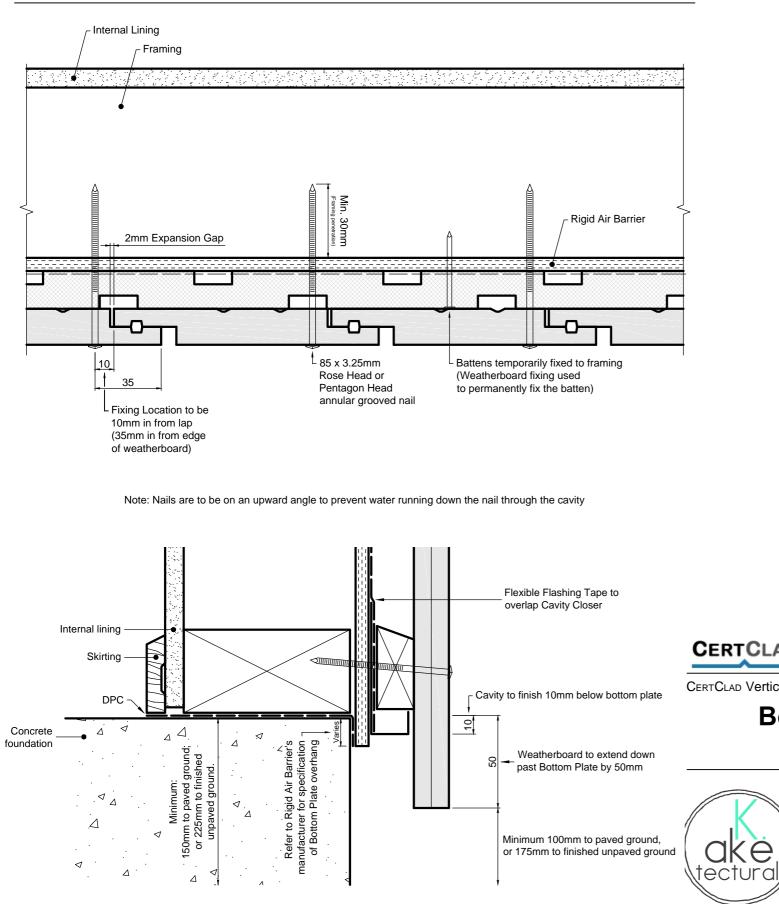

CERTCLAD

CERTCLAD Vertical Shiplap with Rigid Air Barrier Weatherboards Cavity System

Internal 90° Corner Details Butted

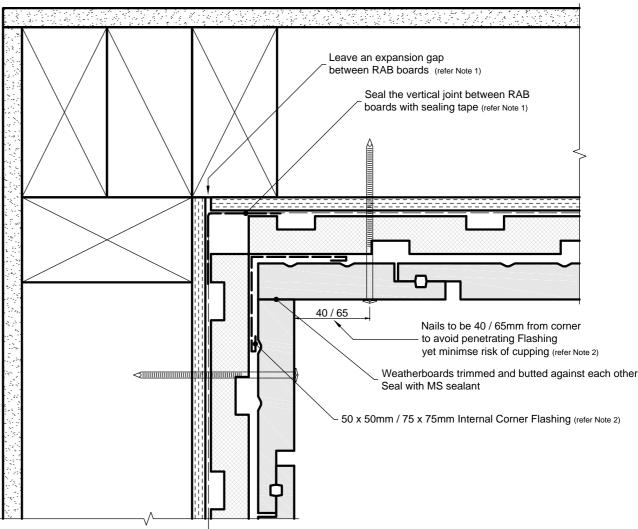

CERTCLAD

CERTCLAD Vertical Shiplap with Rigid Air Barrier Weatherboards Cavity System

Bottom Plate (Base of Wall) Details Concrete Floor

		K.aketectural	Michael Barrett + Briar H
		Kyle Kake	
o paved ground, ed unpaved ground	l ake	PHONE: 027 5678 808	New Dwelling
	<pre>\tectural//</pre>	kylekake@gmail.com	North Ridge Rise
			Whangarei









Hart


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Standard Certclad Details

SHEET

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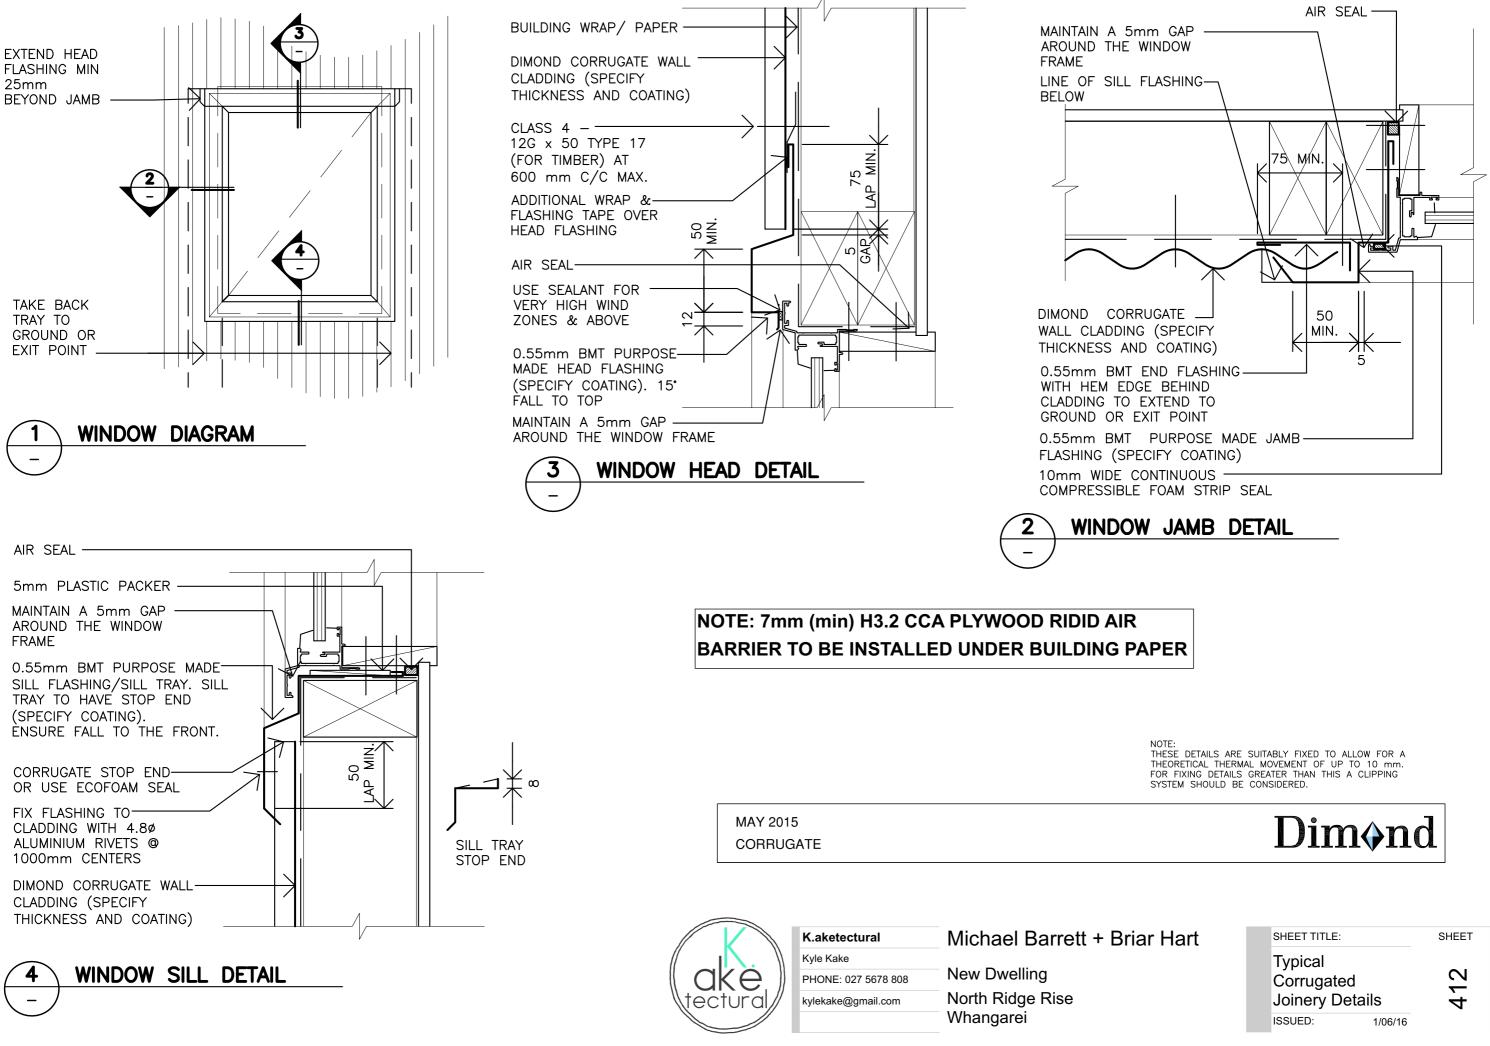



tectura

kylekake@gmail.com

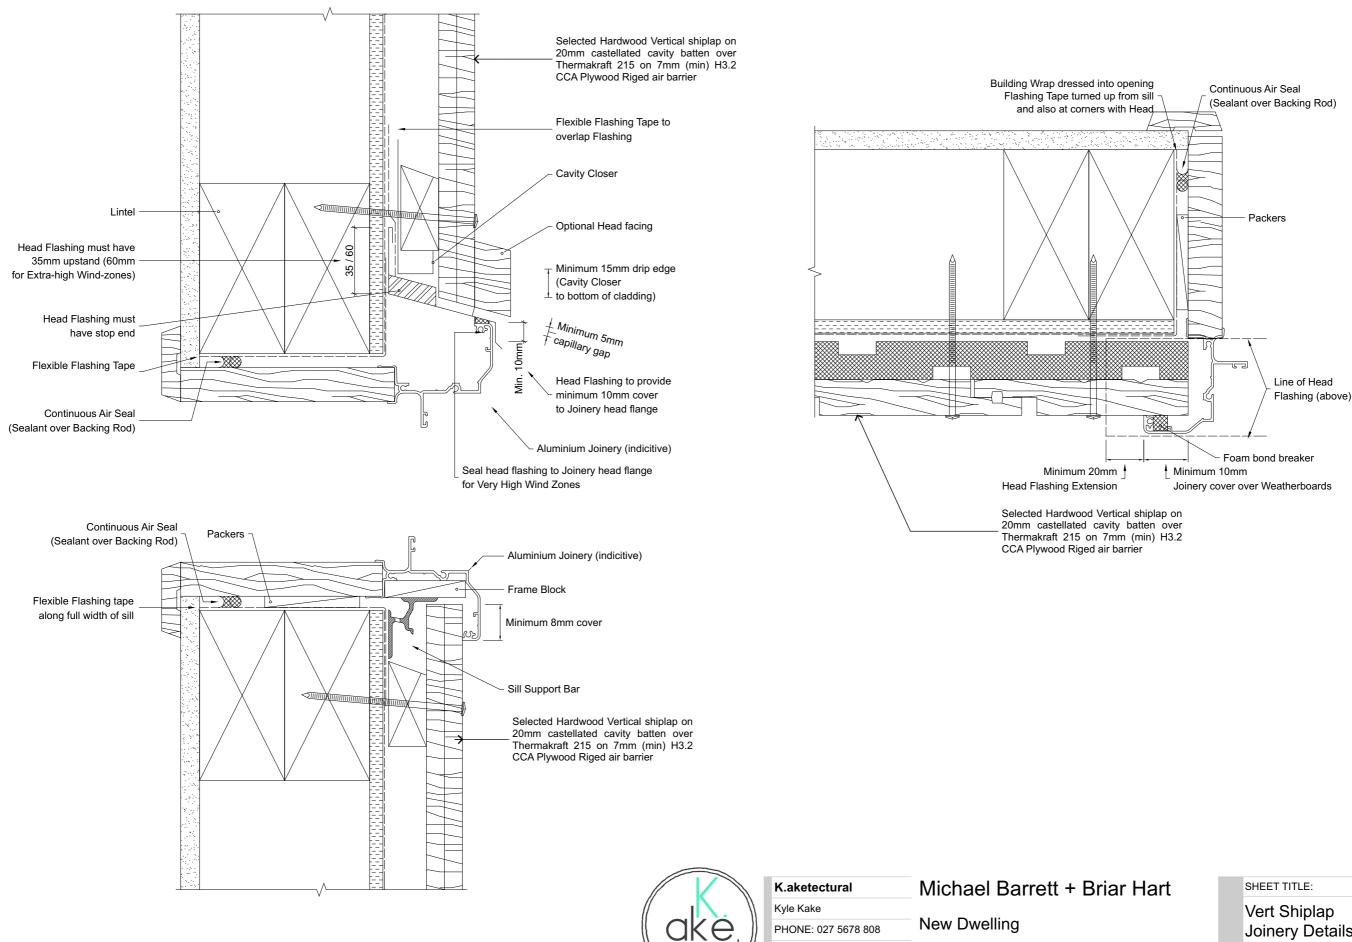
North Ridge Rise Whangarei

SHEET 411 Joinery Details ISSUED: 1/06/16



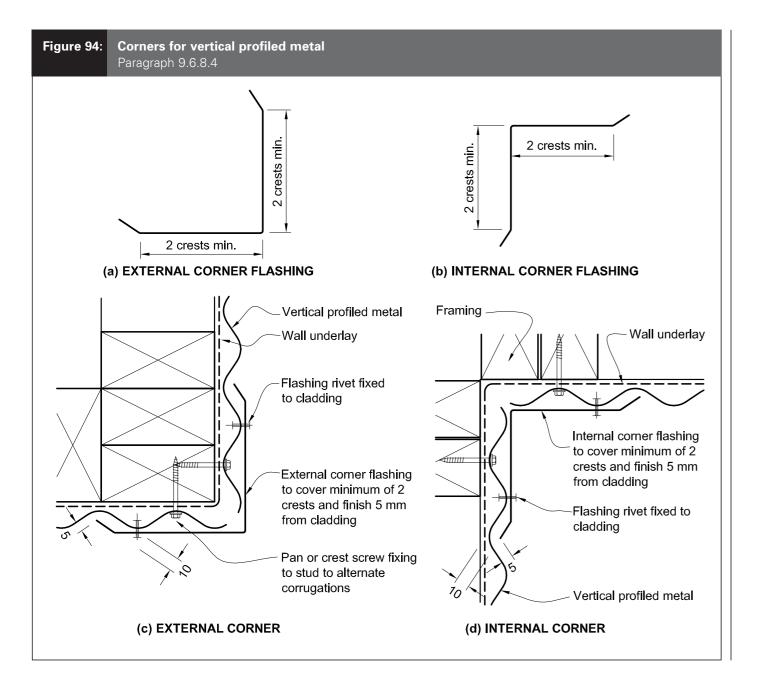



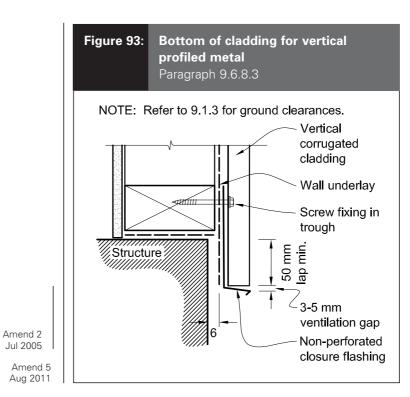



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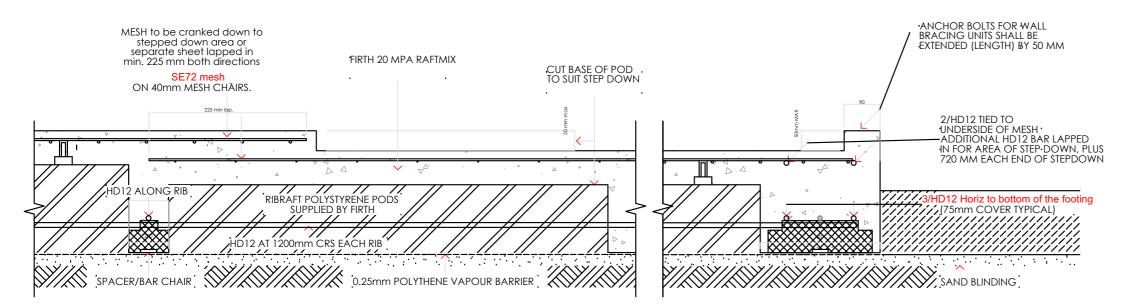
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NZBC E2 Cladding Details

SHEET

413

ISSUED:



RIB RAFT FLOOR - SET-DOWN DETAIL FOR MAX. 50mm REBATED SHOWER

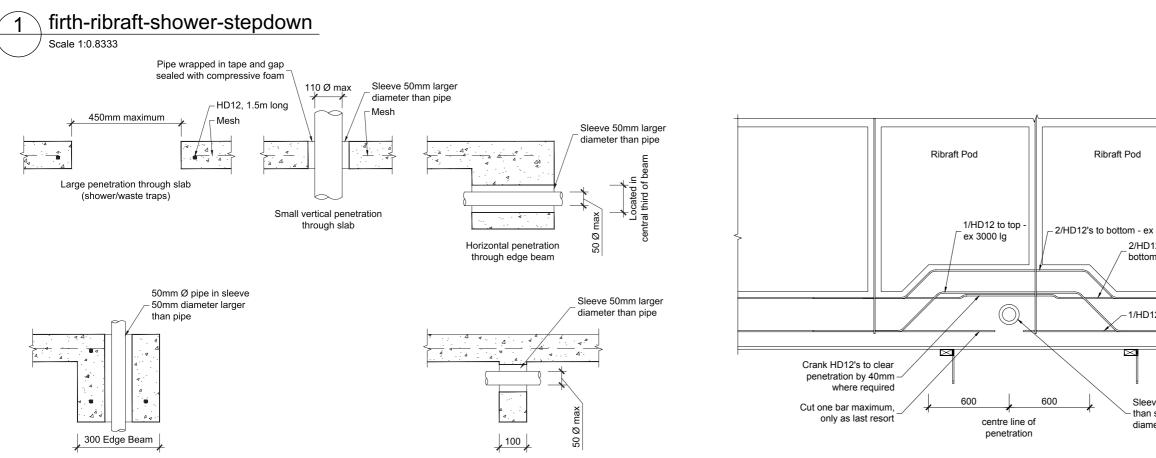


Figure 12 Example of detailing requirements for services

Figure 13 Localised increase in width at edge beam where vertical services up to 100mm diameter are required



3000 lg 12's to 1007		
2 to top		
Edae	formwork	

Sleeve 50mm larger diameter than service pipe - maximum diameter of sleeve 150mm

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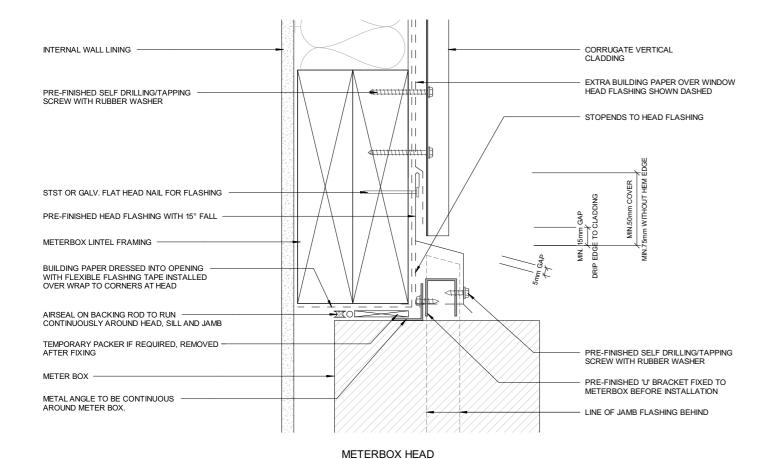
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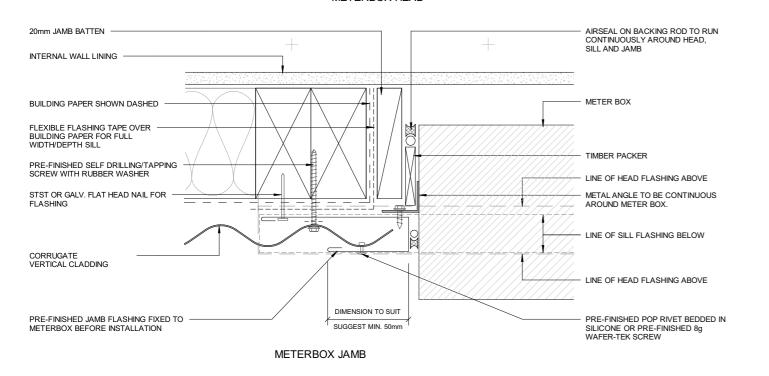
Standard Ribraft Details

ISSUED:



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	13		/////
METAL ANGLE TO BE CONTINUOUS			//////
AROUND METER BOX.		$- \langle X / / \rangle$	////\
	22	- $(/X//)$	////٪
	1	$-\sqrt{/X//}$	////X
FLEXIBLE FLASHING TAPE OVER BUILDING	0.55		/////
FAFERTORTOLE WIDTINDEFTTI SILE	23	$-\mathbb{K}//\mathbb{X}$	/////
	22	-X//	
METER BOX		- † /X///	$\chi///$
		$-V/\chi//$	X/A
MIN. 8mm PACKER	- 54	-K/X/	//X//ż
	2,5	-X/X/	$//\chi/\chi$
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		-VX/X	///\\
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PRE-FINISHED SECONDARY FLASHING	17 - 1 1. 1 - 1		
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PRE-FINISHED SELF DRILLING/TAPPING			uuu uuu
SCREW WITH RUBBER WASHER			l i
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STST OR GALV. FLAT HEAD NAIL FOR FLASHING	5 4 C	~~~~~~~~~~~~~~~~~~~~~~~~~~~~~~~~~~~~~~~	
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INTERNAL WALL LINING			
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METERBOX SILL



Kyle Kake аке tectura


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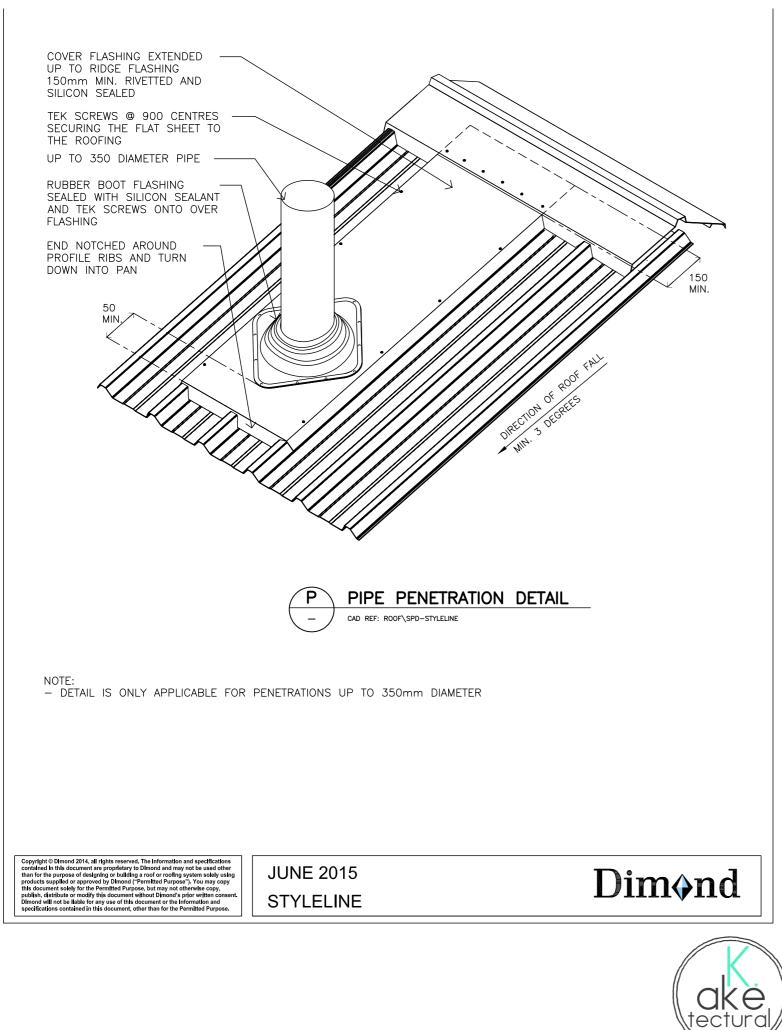
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Meterbox Details

S $\overline{}$ 4

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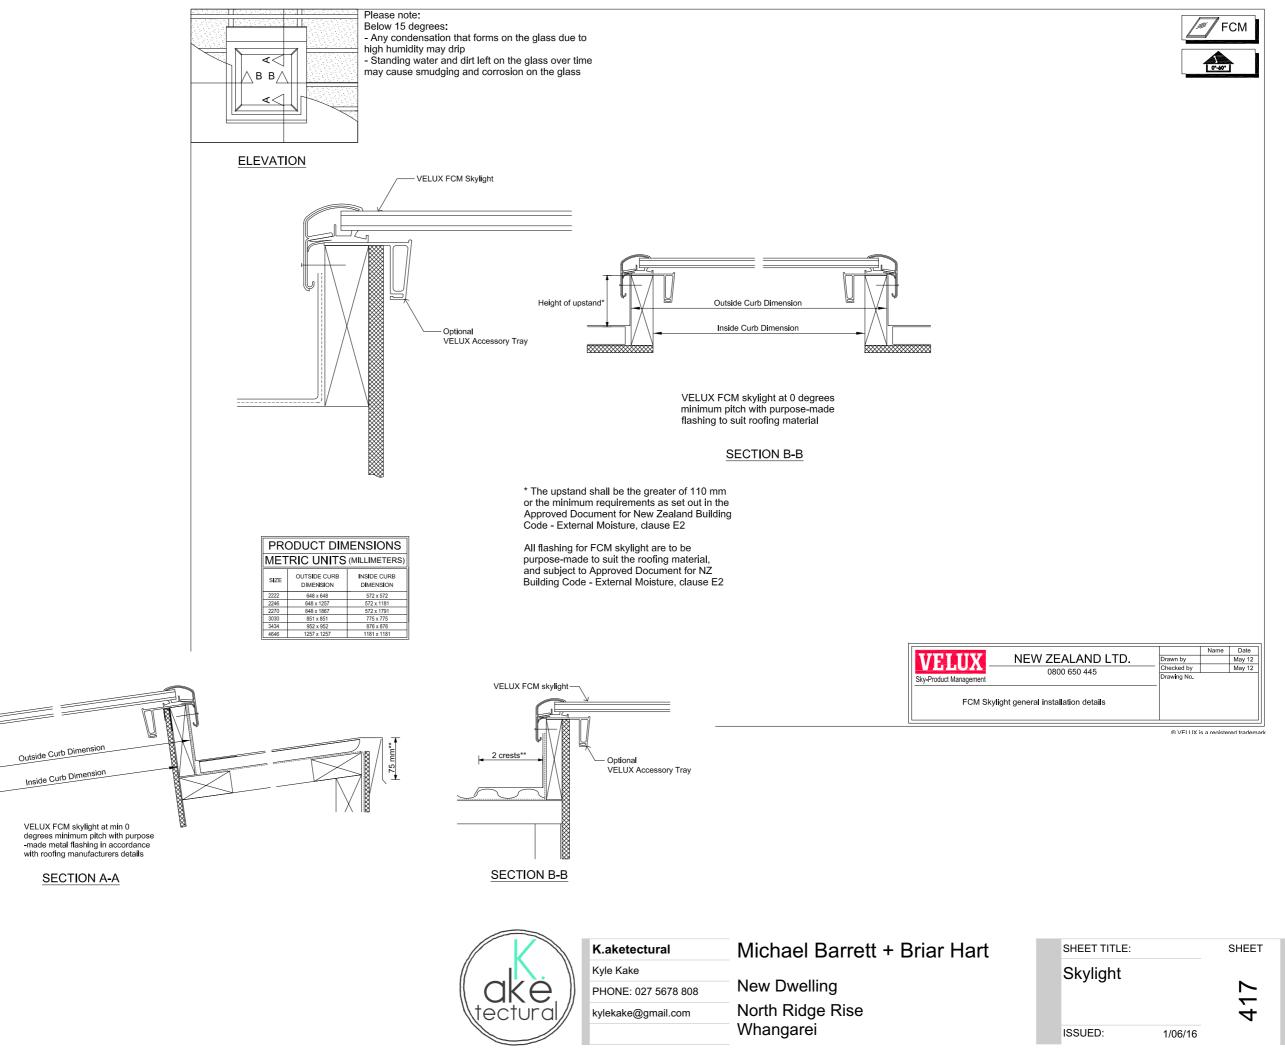
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Roof Penetration

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ISSUED:



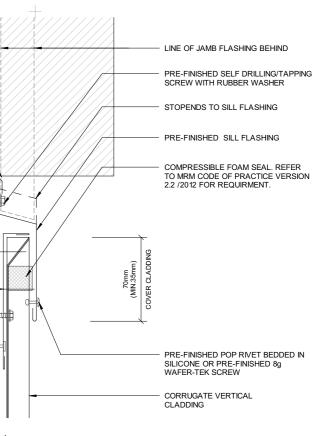

			Name	Date
<u>LUX</u> -	NEW ZEALAND LTD. 0800 650 445	Drawn by		May 12
		 Checked by 		May 12
uct Management				
FCM Skylight general installation details				