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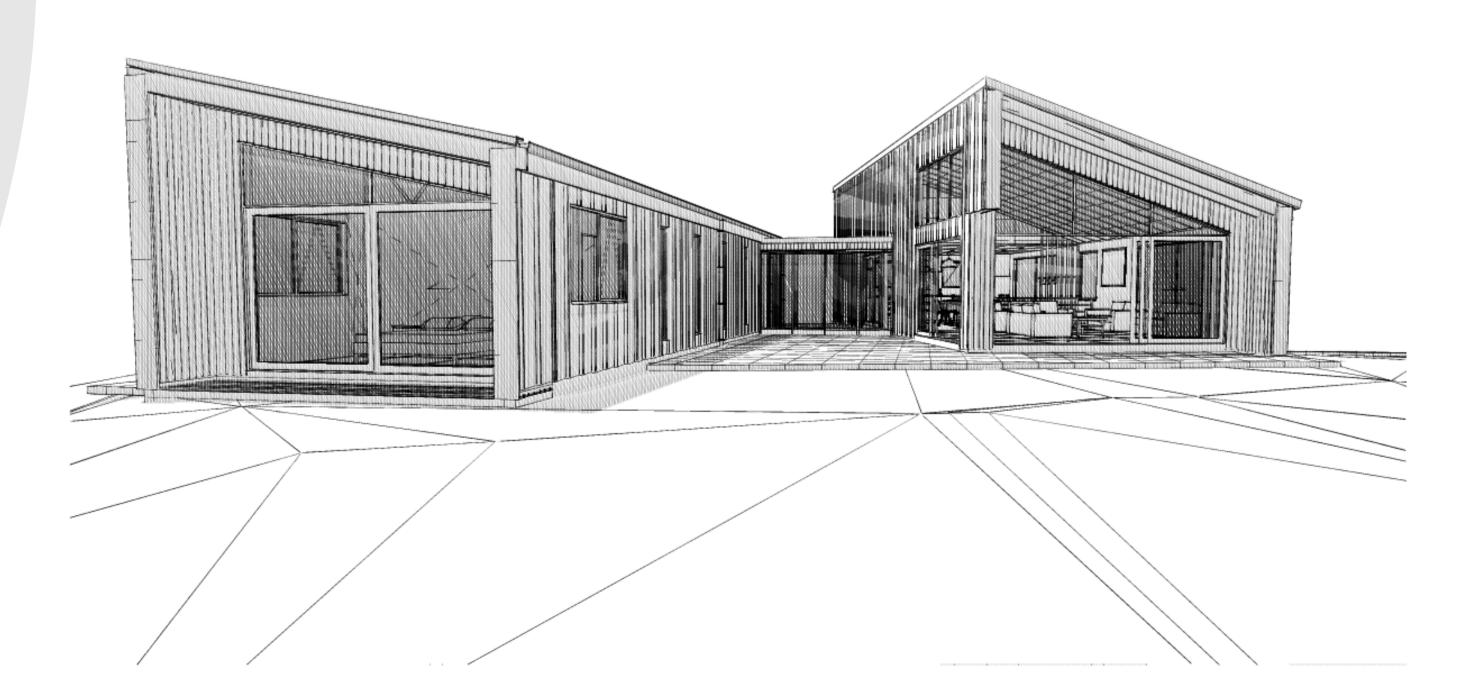
URQUHARTS HOUSE FOR JAMES CROAD & SHONA POULSON 43 BASIL ROAD, WHANGAREI HEADS, WHANGAREI


JOB NO:13060


DATE: 16 DECEMBER 2016

ISSUE:

STATUS:FOR CONSENT



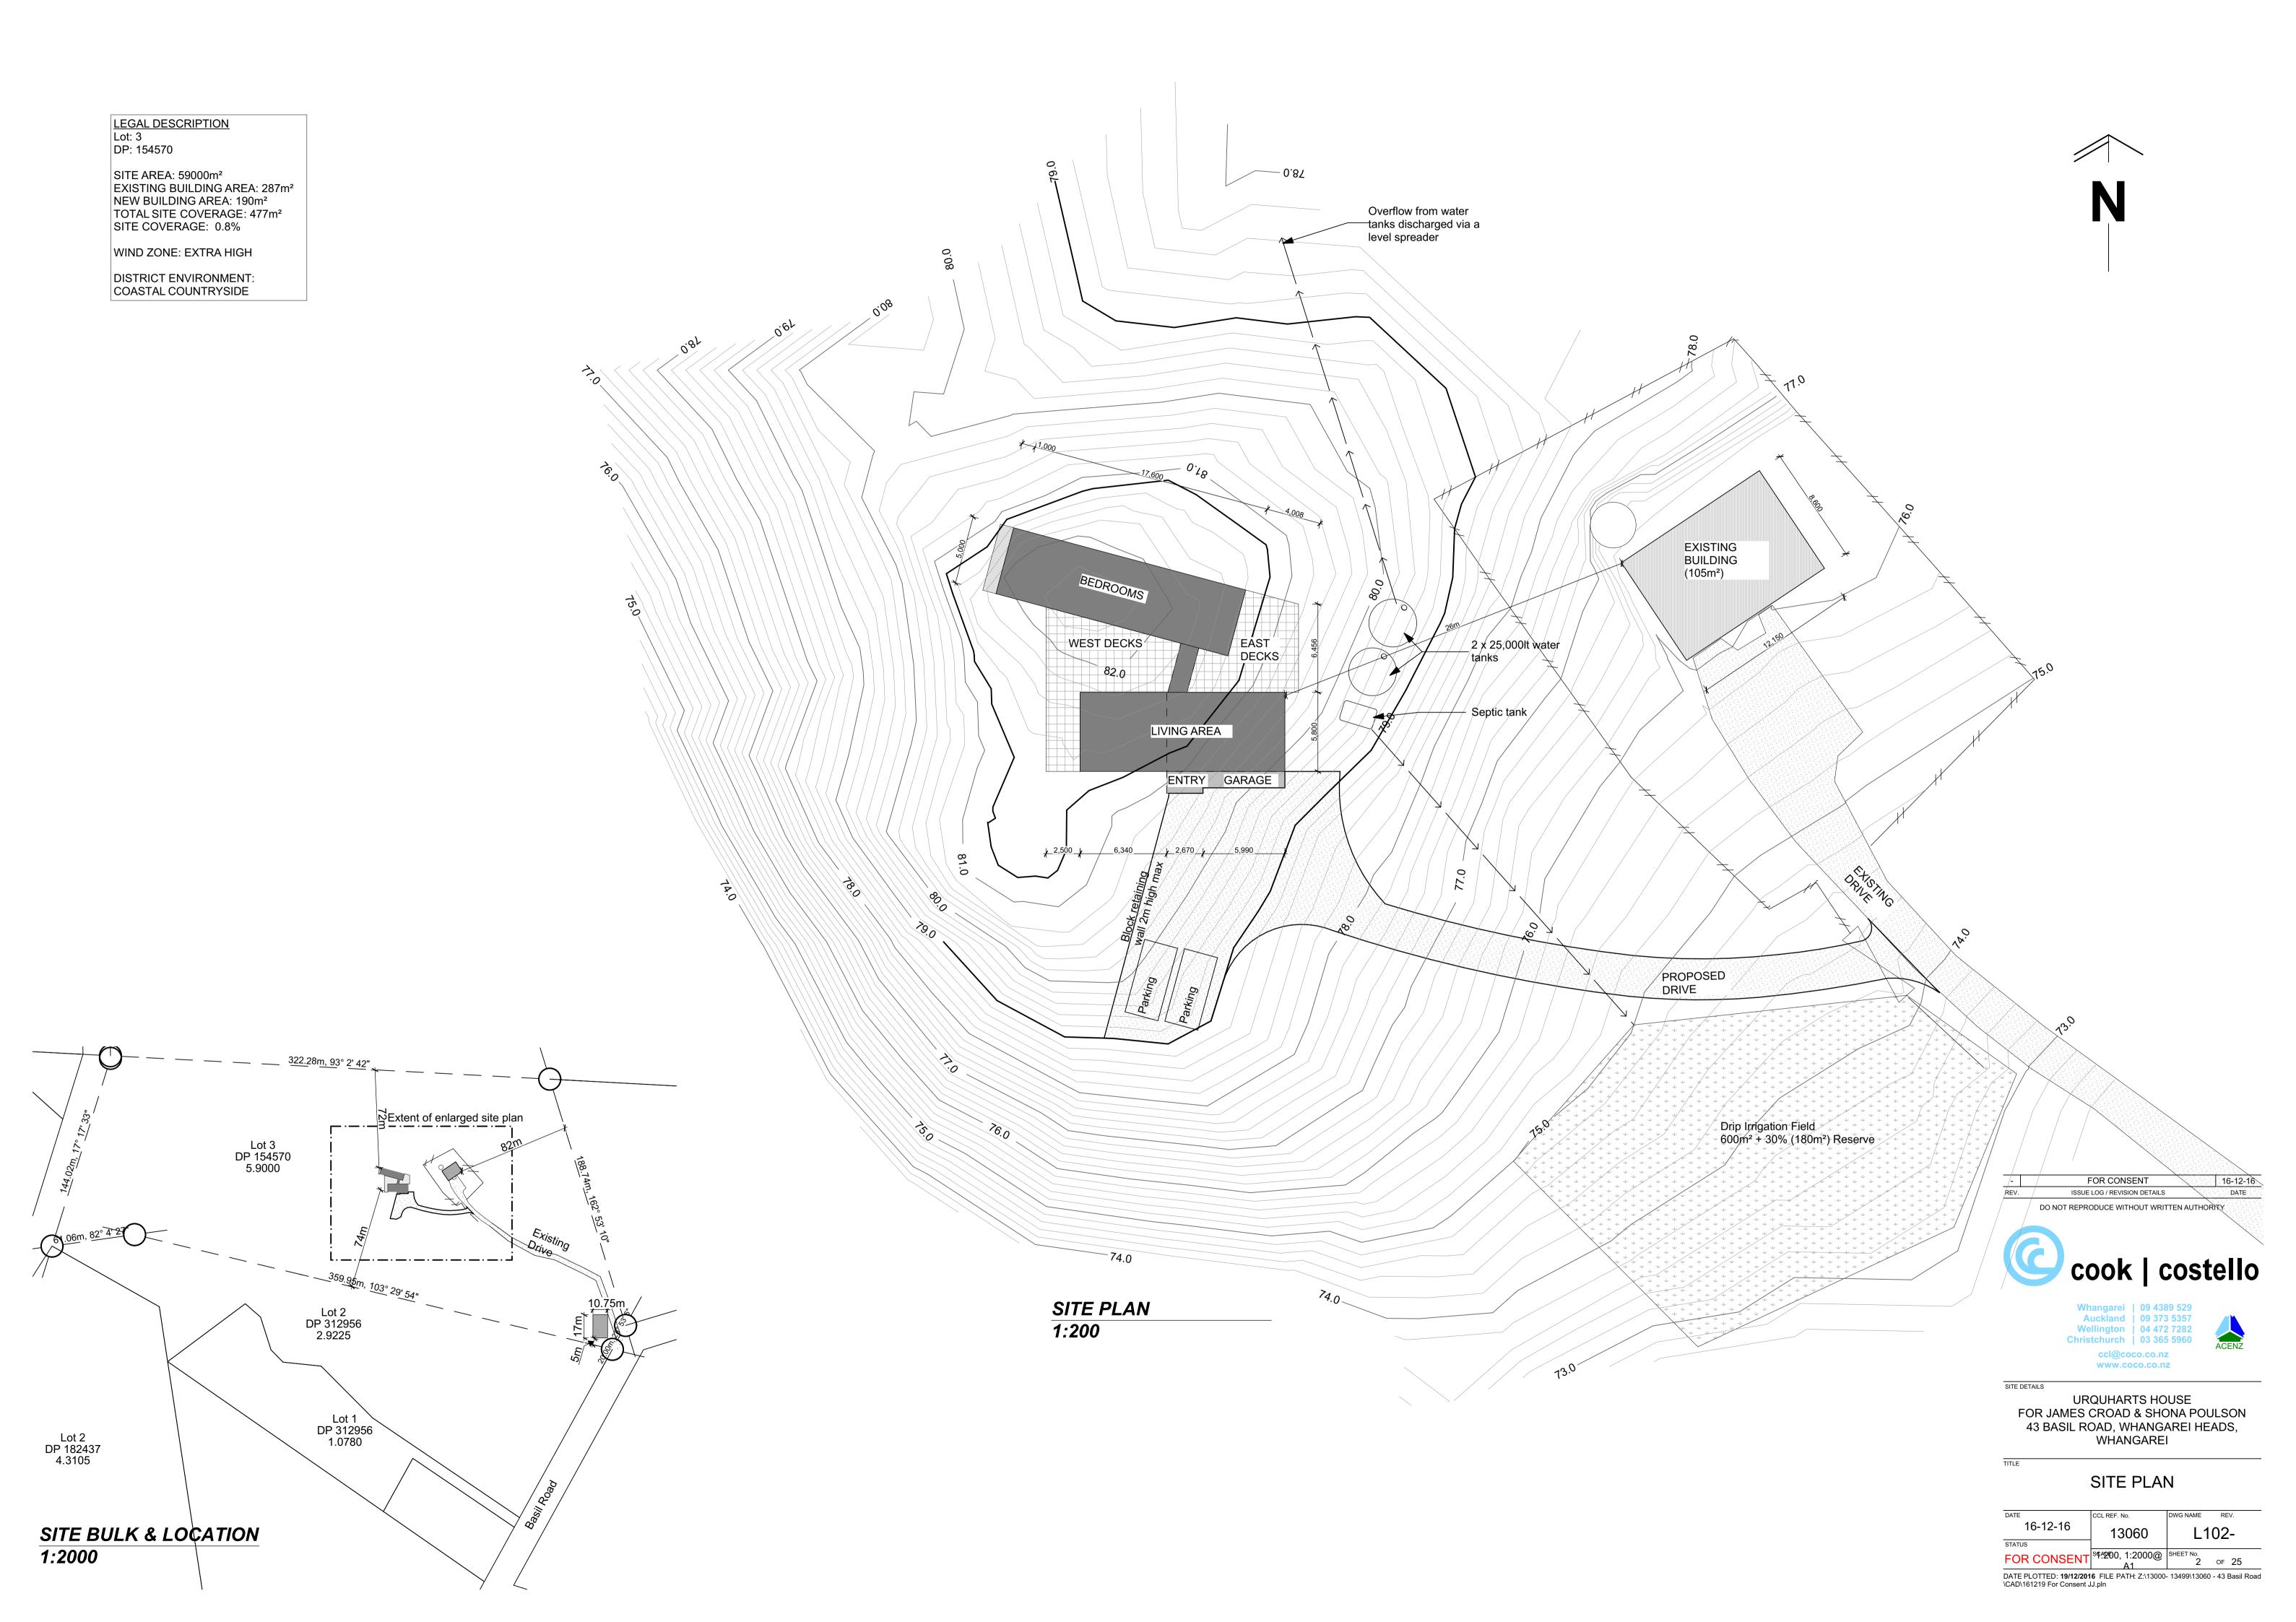

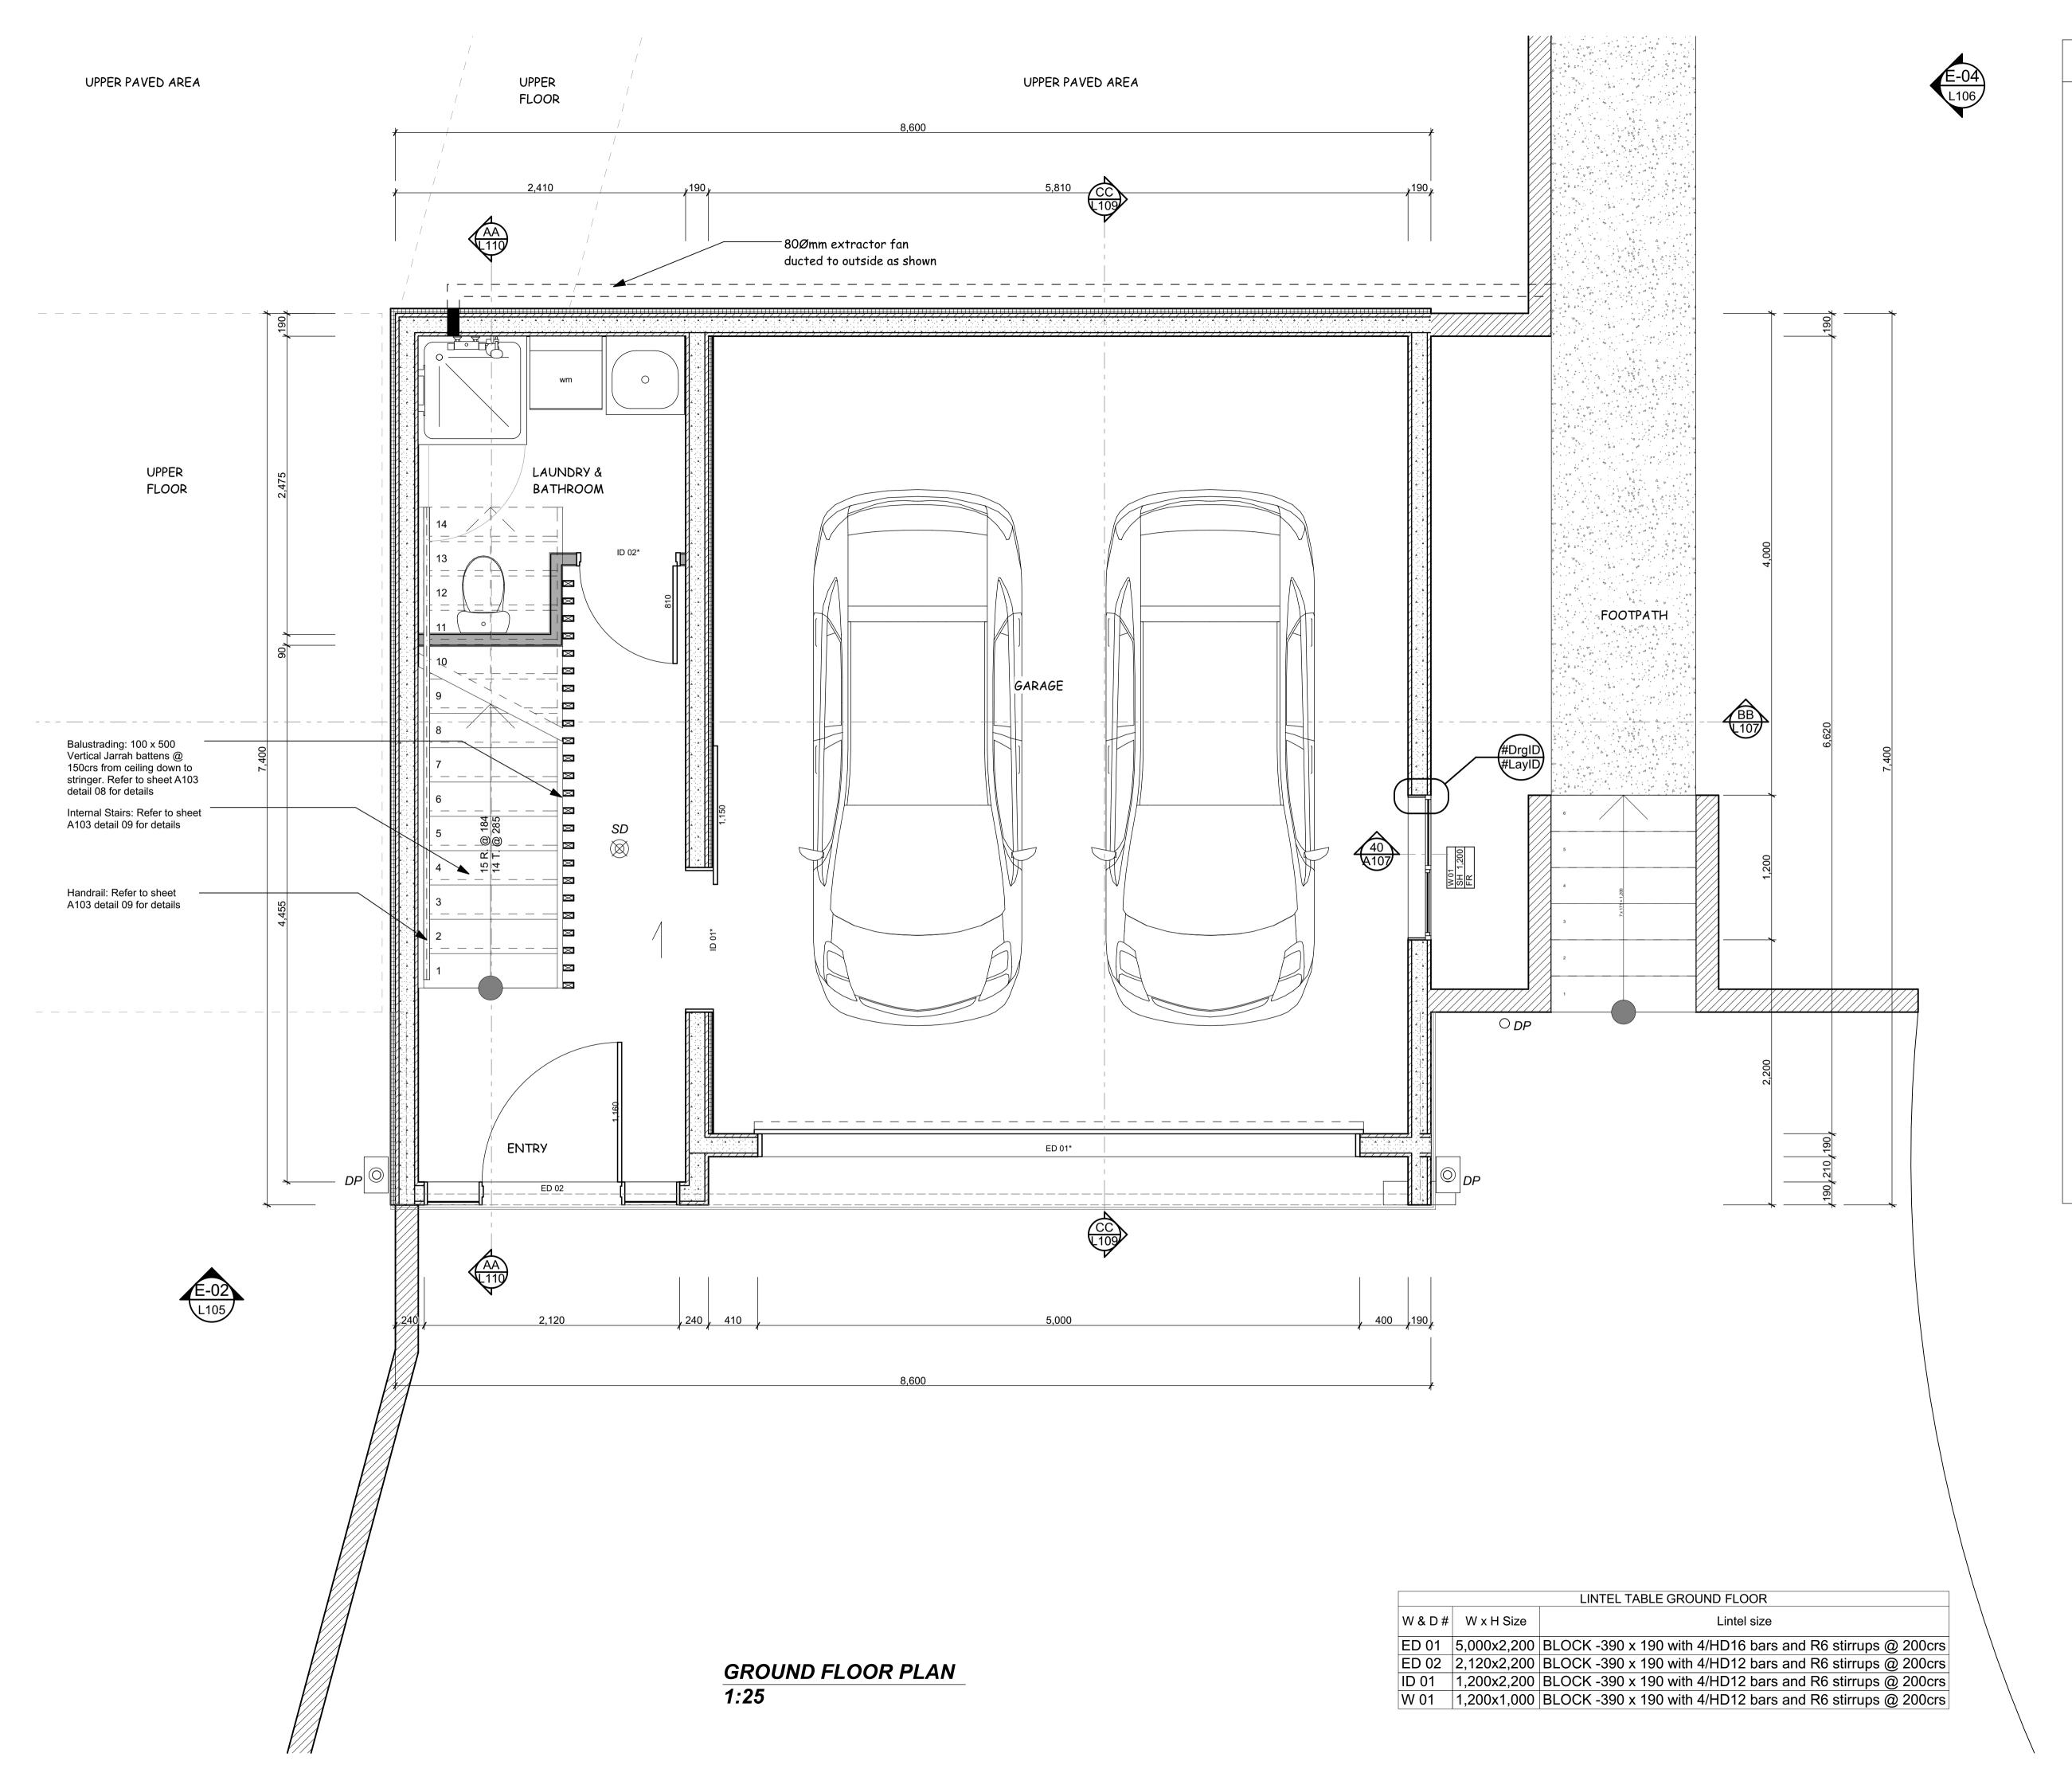

LEGEND SMOKE DETECTOR - Install near or on SD ceiling in each sleeping space or within 3 \bigotimes meters of every sleeping space door. Ø80mm Marley PVC downpipes

WALL CONSTRUCTION

Internal Garage wall to be 20 Series solid filled Architectural Masonry stack bond block wall with Honed finish.

Mortar joints to be Half round / concaved joint with 30mm thick Expol Platinum board R0.81 and lined with 10mm standard Gib to garage side

External retaining walls to North and west to be 20 Series solid filled Architectural Masonry stack bond block wall with Honed finish. Mortar joints to be Half round / concaved joint with 30mm EXPOL ThermaSlab S grade R0.79 insulation

External Garage walls to South and East to be 20 Series solid filled Architectural Masonry stack bond block wall with Honed finish. Mortar joints to

be Half round / concaved joint Internal Non-Loadbearing Walls - 90 x 45 SG8 H1.2 timber studs at 600 crs with nogs at 1350 max. crs.

External Retaining walls to be 20 Series solid filled Architectural Masonry stack bond block wall with Honed finish.

Mortar joints to be Half round / concaved joint CLADDING

BBS Timbers Cedar vertical random width and depth boards on 20 x 45mm H3.2 cavity battens

FLOOR FINISHES



Polished concrete floors

GENERAL NOTES

- 1. Contractor to confirm all dimensions on site.
- 2. Do not scale from drawings.
- 3. If any discrepancies are found contact the designer.

FLOOR AREA Ground Floor area: 62m2

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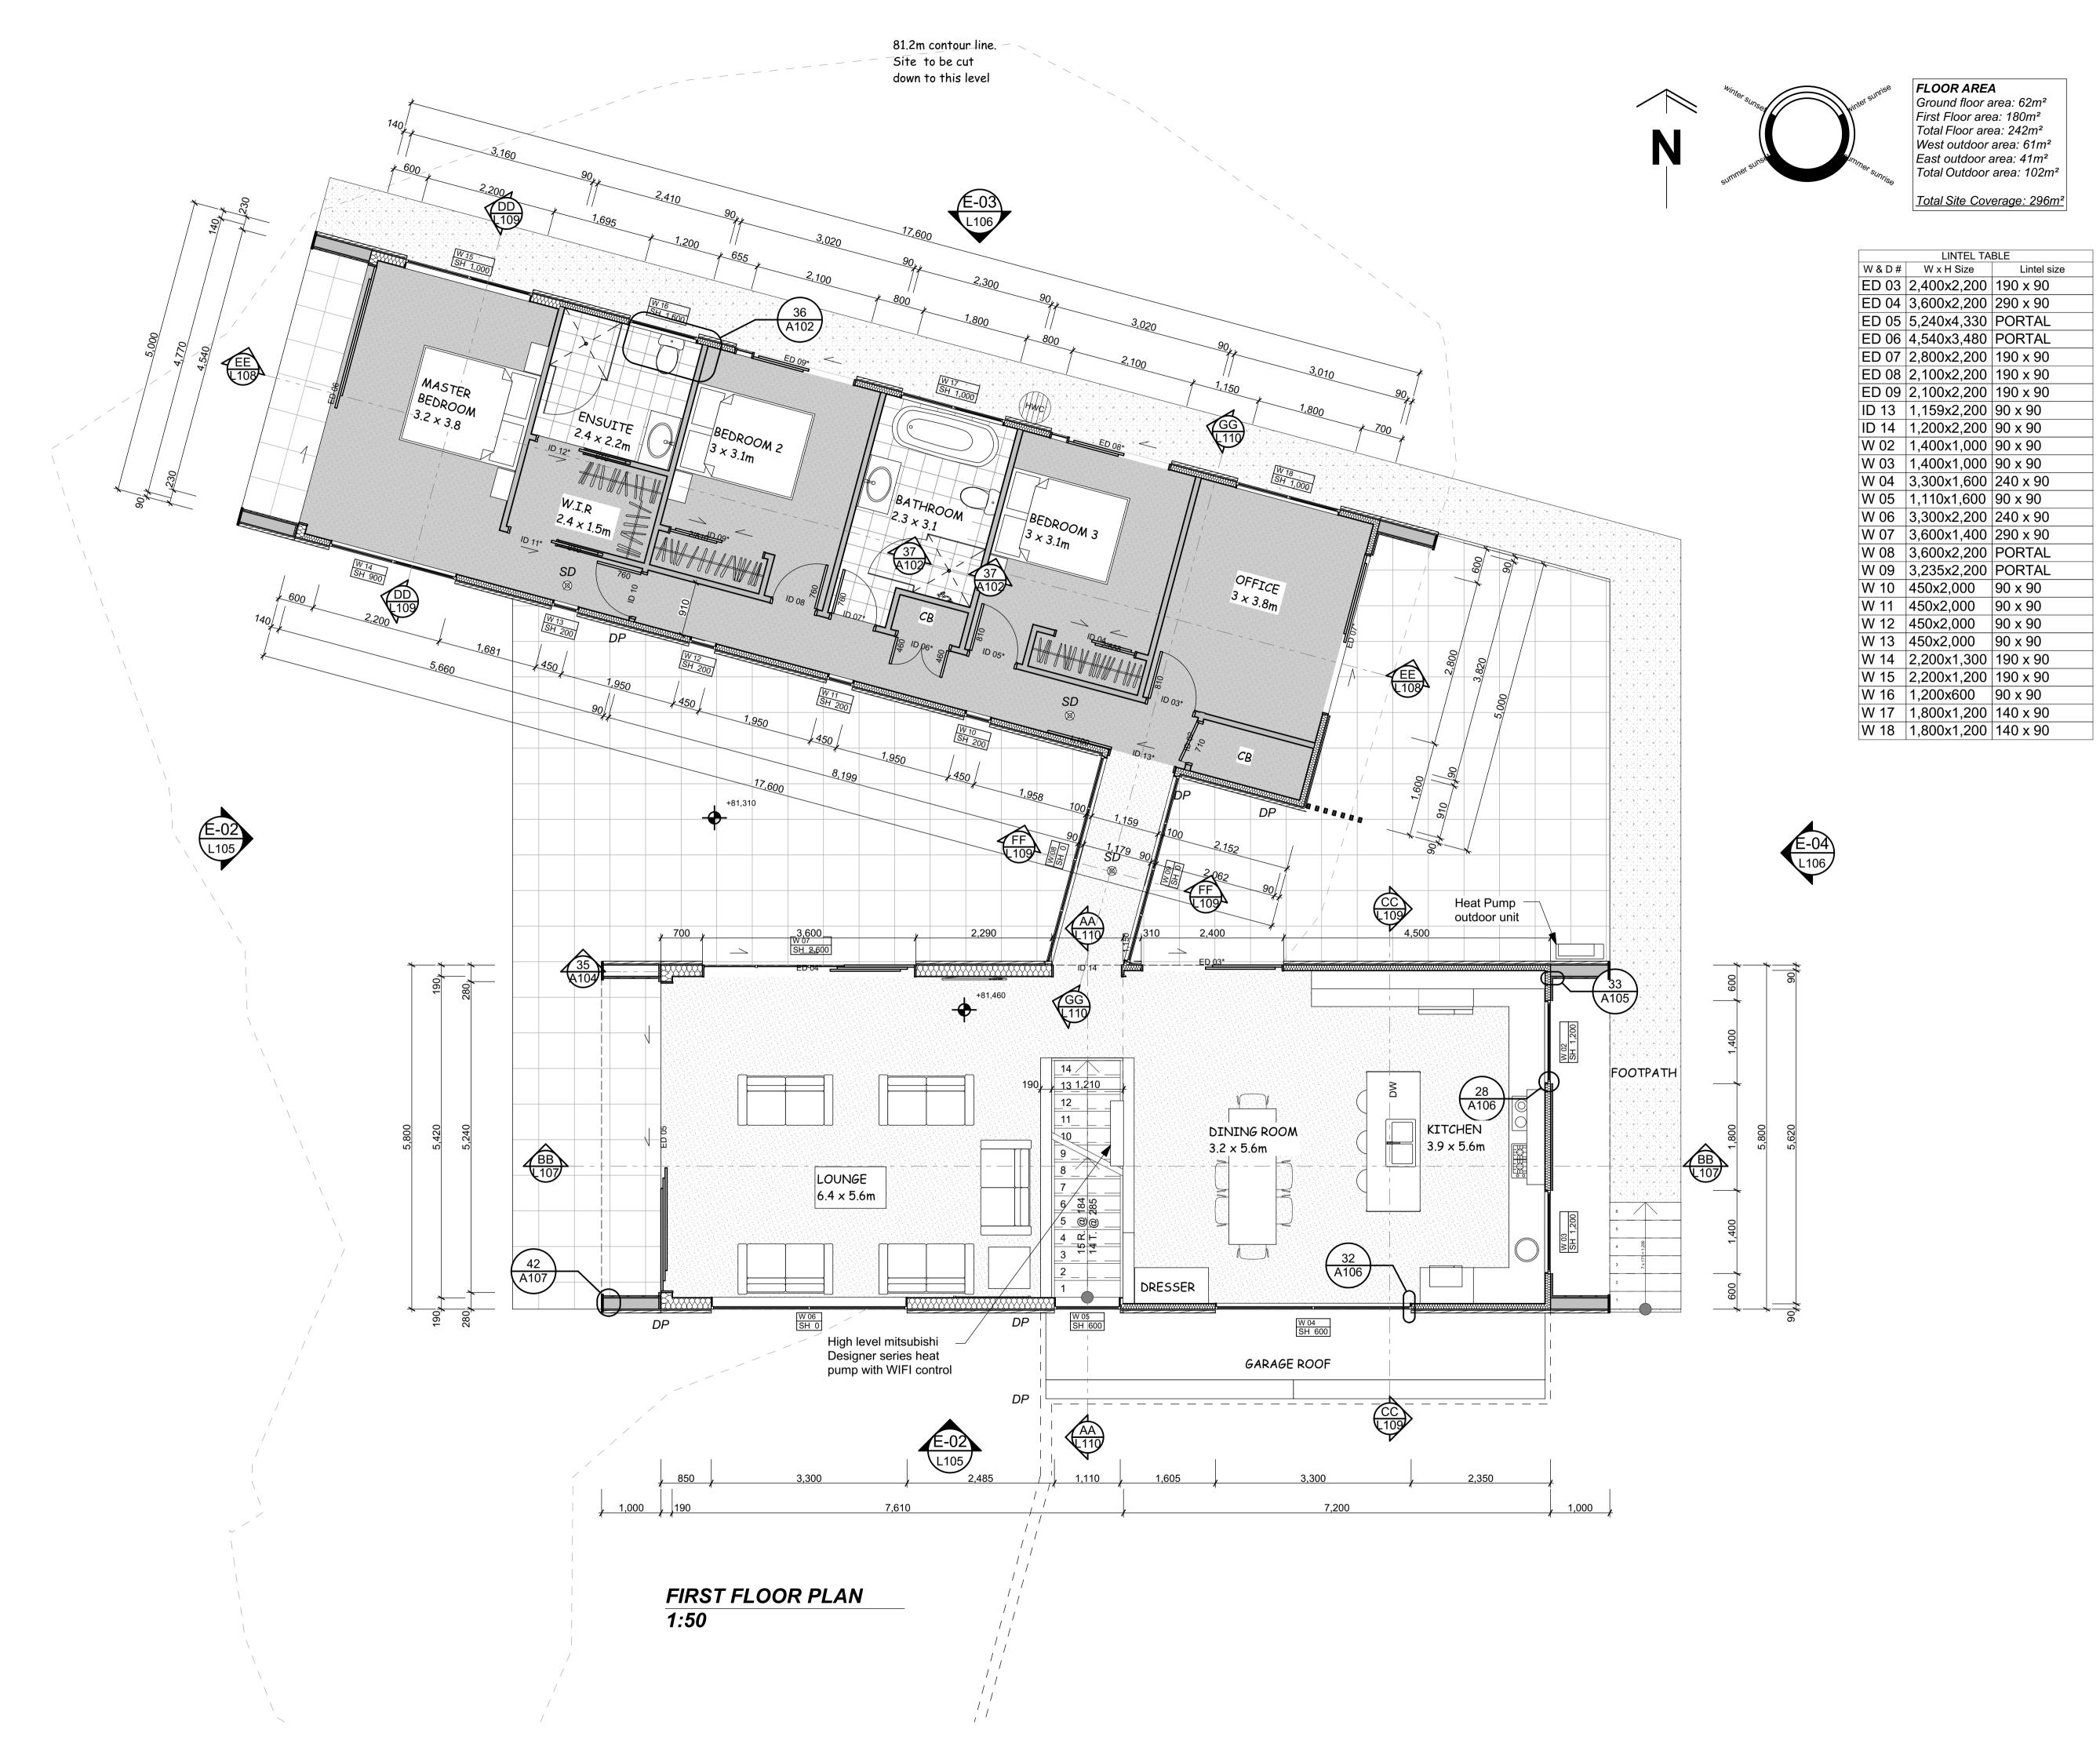


SITE DETAILS

URQUHARTS HOUSE FOR JAMES CROAD & SHONA POULSON 43 BASIL ROAD, WHANGAREI HEADS, WHANGAREI

GROUND FLOOR PLAN

CCL REF. No.	DWG NAME	REV.	
13060	L103-		
1:25@ A1	SHEET No.	of 25	
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LEGEND

SMOKE DETECTOR - Install near or on ceiling in each sleeping space or within 3 meters of every sleeping space door.

Ø80mm Marley PVC downpipes

WALL CONSTRUCTION

Loadbearing Walls - 2.450m Stud: 90 x 45 SG8 H1.2 Timber studs at 400 crs with nogs at 800 max. c/c

> <u>Loadbearing Walls</u> - 3.6m Stud: 140 x 45 SG8 H1.2 Timber studs at 400 crs with nogs at 800 max. c/c

Loadbearing Walls - 4.8m Stud: 190 x 90 SG8 H1.2 Timber studs at 600 crs

with nogs at 800 max. c/c

Internal Non-Loadbearing Walls - 90 x 45 SG8 H1.2 timber studs at 600 crs with nogs at 1350 max. crs.

CLADDING

GABLE ENDS: BBS Timbers Cedar vertical Shiplap weather boards on 20 x 45mm H3.2 cavity battens

SIDE WALLS: -Eurostyle Spanlok 450 without swages 0.55mm Steel on 12mm ply over 20 x 40mm battens

INTERNAL LININGS

All walls to be interior lined with 10mm standard GIB Board - Wet areas to be lined with 10mm GIB Aqualine.

FLOOR FINISHES

Polished concrete floors - 83m²

Selected carpet - 69m²

300x300 selected bathroom tiles -

600 x 600 Firth Outdoor Pavers-

Concrete foot paths- 38m²

FIXINGS

BOTTOM PLATE: Cast in Anchors shall be M12 bolts set within 150mm of each end of the plate, spaced at a maximum of 1200mm crs, bent to prevent turning and projecting sufficiently to allow a 50 x 50 x 3mm washer and fully threaded nut above the timber plate. Install as per NZS:3604 2011 Figure 7.21

LINTEL FIXING: 25 x 1mm strap with 6/30 x 2.5mm nails into both lintel and stud, or a 7.5kN (tension) connection (Refer to NZS:3604 8.6.1.8)

STUDS TO TOP PLATE: 2 / 90 x 3.15 plain steel wire nails driven vertically into stud plus Lumberlok Stud Strap (one face only) Alternative fixing capacity (4.7 kN)


GENERAL NOTES

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SITE DETAILS

URQUHARTS HOUSE FOR JAMES CROAD & SHONA POULSON 43 BASIL ROAD, WHANGAREI HEADS, WHANGAREI

FIRST FLOOR PLAN

	CCL REF. No.	DWG NAME	REV.	
16-12-16	13060	L104-		
STATUS				
FOR CONSENT	1:50@ A1	SHEET No.	of 25	

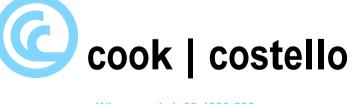Notes

Enclosure

4.01 Cedar Wall Cladding JVC Timber Cedar Random Width and Depth Weatherboards on 20 x 40mm battens on Thermakraft building underlay on H1.2 timber framing and lined with 10mm Gib internal face with R2.6 Earth wool insulation

4.02 Eurostyle Wall Cladding
Eurostyle Spanlok 450 without swages 0.55mm Steel on 12mm ply over 20 x 40mm battens on Thermakraft building underlay on H1.2 timber framing and lined with 10mm Gib internal face with R2.6 Earth wool insulation


4.03 Honed Block 20 Series solid filled Architectural Masonry stack bond block wall with Honed finish. Mortar joints to be Half round / concaved joint.

4.04 Eurostyle roofing Eurostyle Spanlok 450 without swages 0.55mm colour steel MAXX (Ebony colour) and laid over Thermakraft 215 Building paper on Rafters & trusses (Refer to roof framing plan for sizes).

4.05 Joinery Aluminium powder coated Architectural series joinery with aluminium jamb liners, Aluminium windows to be fitted with double tongue catches, Very high wind

4.07 Spouting and downpipe Roofing industries R.I. 125mm Box gutter & 75 x 50 Box down pipe. All elements to be ebony colour


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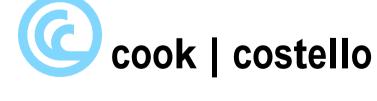


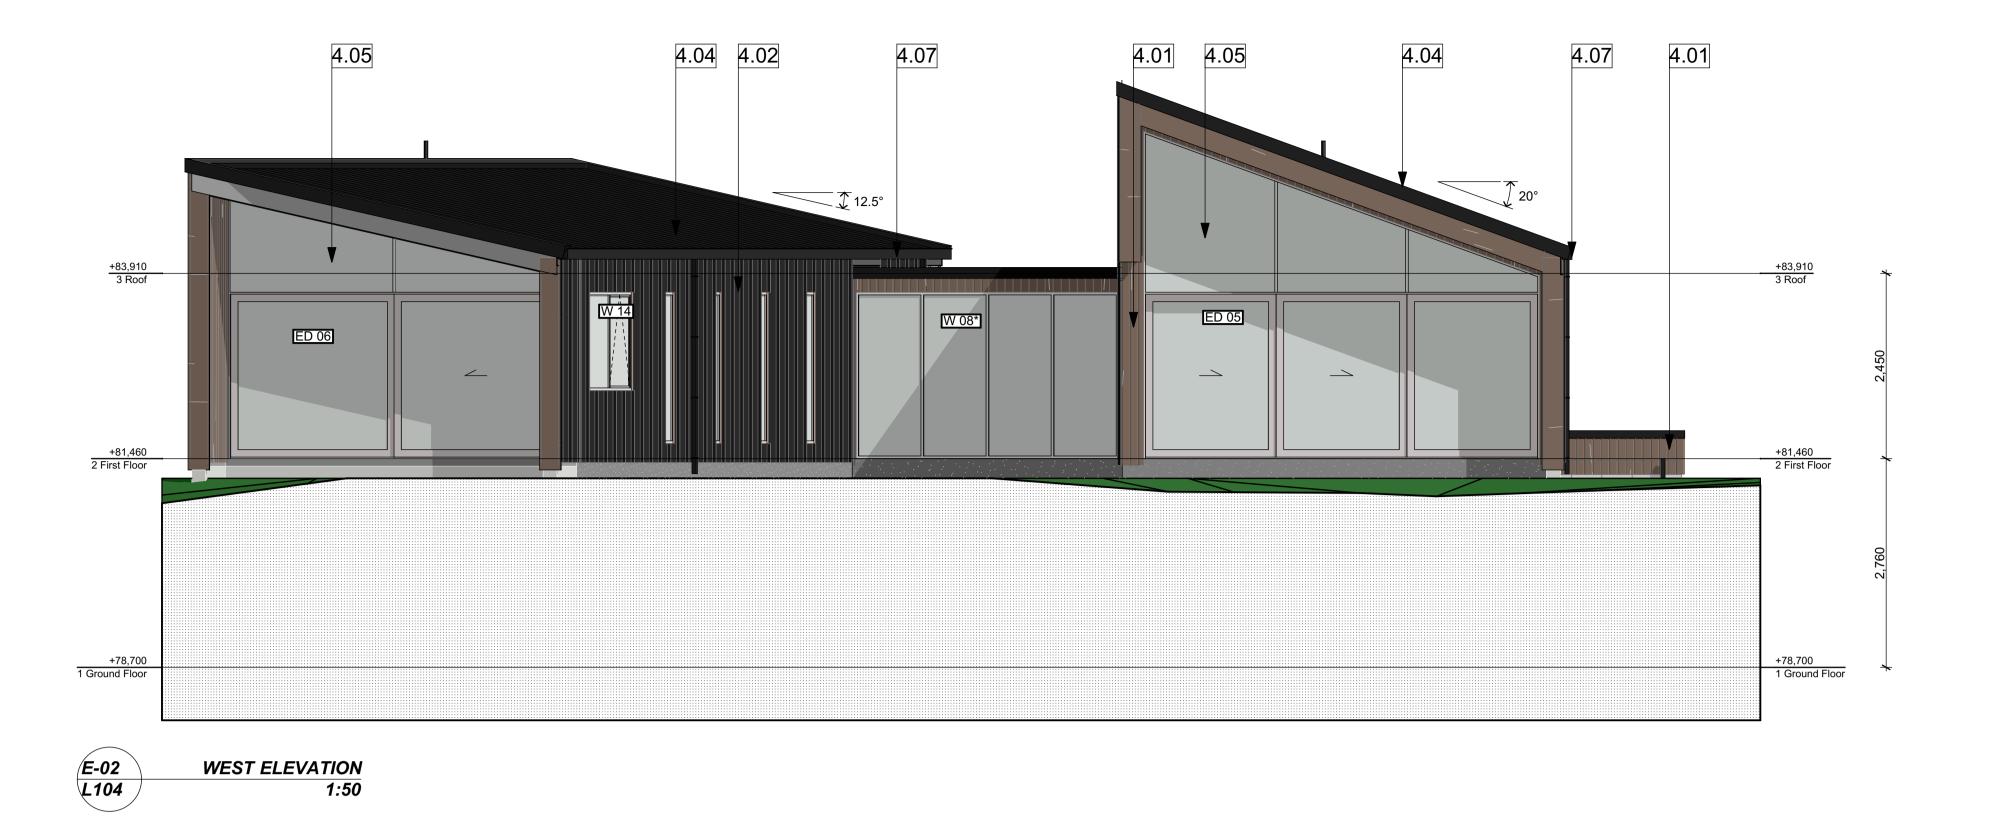LOPE RISK MATRIX	BUILDING ENVE	E
Elevation	West	
Risk Facto	re Risk Severity	Risk Scor
Wind zone (per NZS 3604	Very high risk	2
Number of storeys	Low risk	0
Roof/wall intersection design	Medium risk	1
Eaves width	Very high risk	5
Envelope complexity	Medium risk	1
Deck desigr	Low risk	0
Total Risk Score		9

LOPE RISK MATRIX	BUILDING ENVELOPE RISK MATRIX								
Elevation	South Elevation								
Risk Factor	re Risk Severity	Risk Sco							
Wind zone (per NZS 3604)	Very high risk	2							
Number of storeys	Medium risk	1							
Roof/wall intersection desigr	High risk	3							
Eaves width	Very high risk	5							
Envelope complexity	High risk	3							
Deck design	Low risk	0							
Total Risk Score		14							





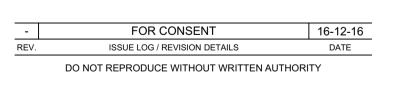


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SITE DETAILS URQUHARTS HOUSE FOR JAMES CROAD & SHONA POULSON 43 BASIL ROAD, WHANGAREI HEADS, WHANGAREI

E-01 SOUTH ELEVATION



Notes

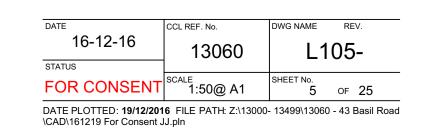Enclosure

4.01 Cedar Wall Cladding JVC Timber Cedar Random Width and

Depth Weatherboards on 20 x 40mm battens on Thermakraft building underlay on H1.2 timber framing and lined with 10mm Gib internal face with R2.6 Earth wool insulation

4.02 Eurostyle Wall Cladding

Eurostyle Spanlok 450 without swages 0.55mm Steel on 12mm ply over 20 x 40mm battens on Thermakraft building underlay on H1.2 timber framing and lined with 10mm Gib internal face with R2.6 Earth wool insulation

4.03 Honed Block

20 Series solid filled Architectural Masonry stack bond block wall with Honed finish. Mortar joints to be Half round / concaved joint.

4.04 Eurostyle roofing

Eurostyle Spanlok 450 without swages 0.55mm colour steel MAXX (Ebony colour) and laid over Thermakraft 215 Building paper on Rafters & trusses (Refer to roof framing plan for sizes).

4.05 Joinery


Aluminium powder coated Architectural series joinery with aluminium jamb liners, Aluminium windows to be fitted with double tongue catches, Very high wind zone

Timber battens

100 x 50 full height Cedar timber battens @ 150mm crs with 100mm gap between battens


4.07 Spouting and downpipe Roofing industries R.I. 125mm Box gutter & 75 x 50 Box down pipe. All elements to be ebony colour




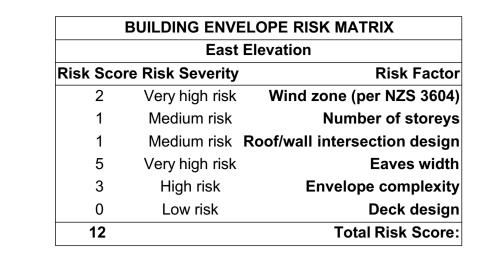

BUILDING ENVELOPE RISK MATRIX							
North Elevation							
Risk Factor	e Risk Severity	Risk Sco					
Wind zone (per NZS 3604)	Very high risk	2					
Number of storeys	Low risk	0					
Roof/wall intersection design	Medium risk	1					
Eaves width	Very high risk	5					
Envelope complexity	Low risk	0					
Deck design	Low risk	0					
Total Risk Score:		8					



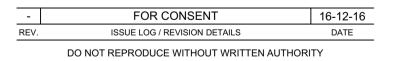

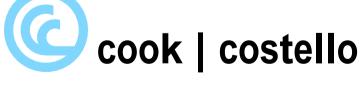


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SITE DETAILS URQUHARTS HOUSE FOR JAMES CROAD & SHONA POULSON 43 BASIL ROAD, WHANGAREI HEADS, WHANGAREI

E-03 NORTH ELEVATION

DATE	CCL REF. No.	DWG NAME	REV.
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STATUS			
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ROOF

L104

Roofing iron: Eurostyle Spanlok 450 without swages 0.55mm colour steel MAXX (Ebony colour)

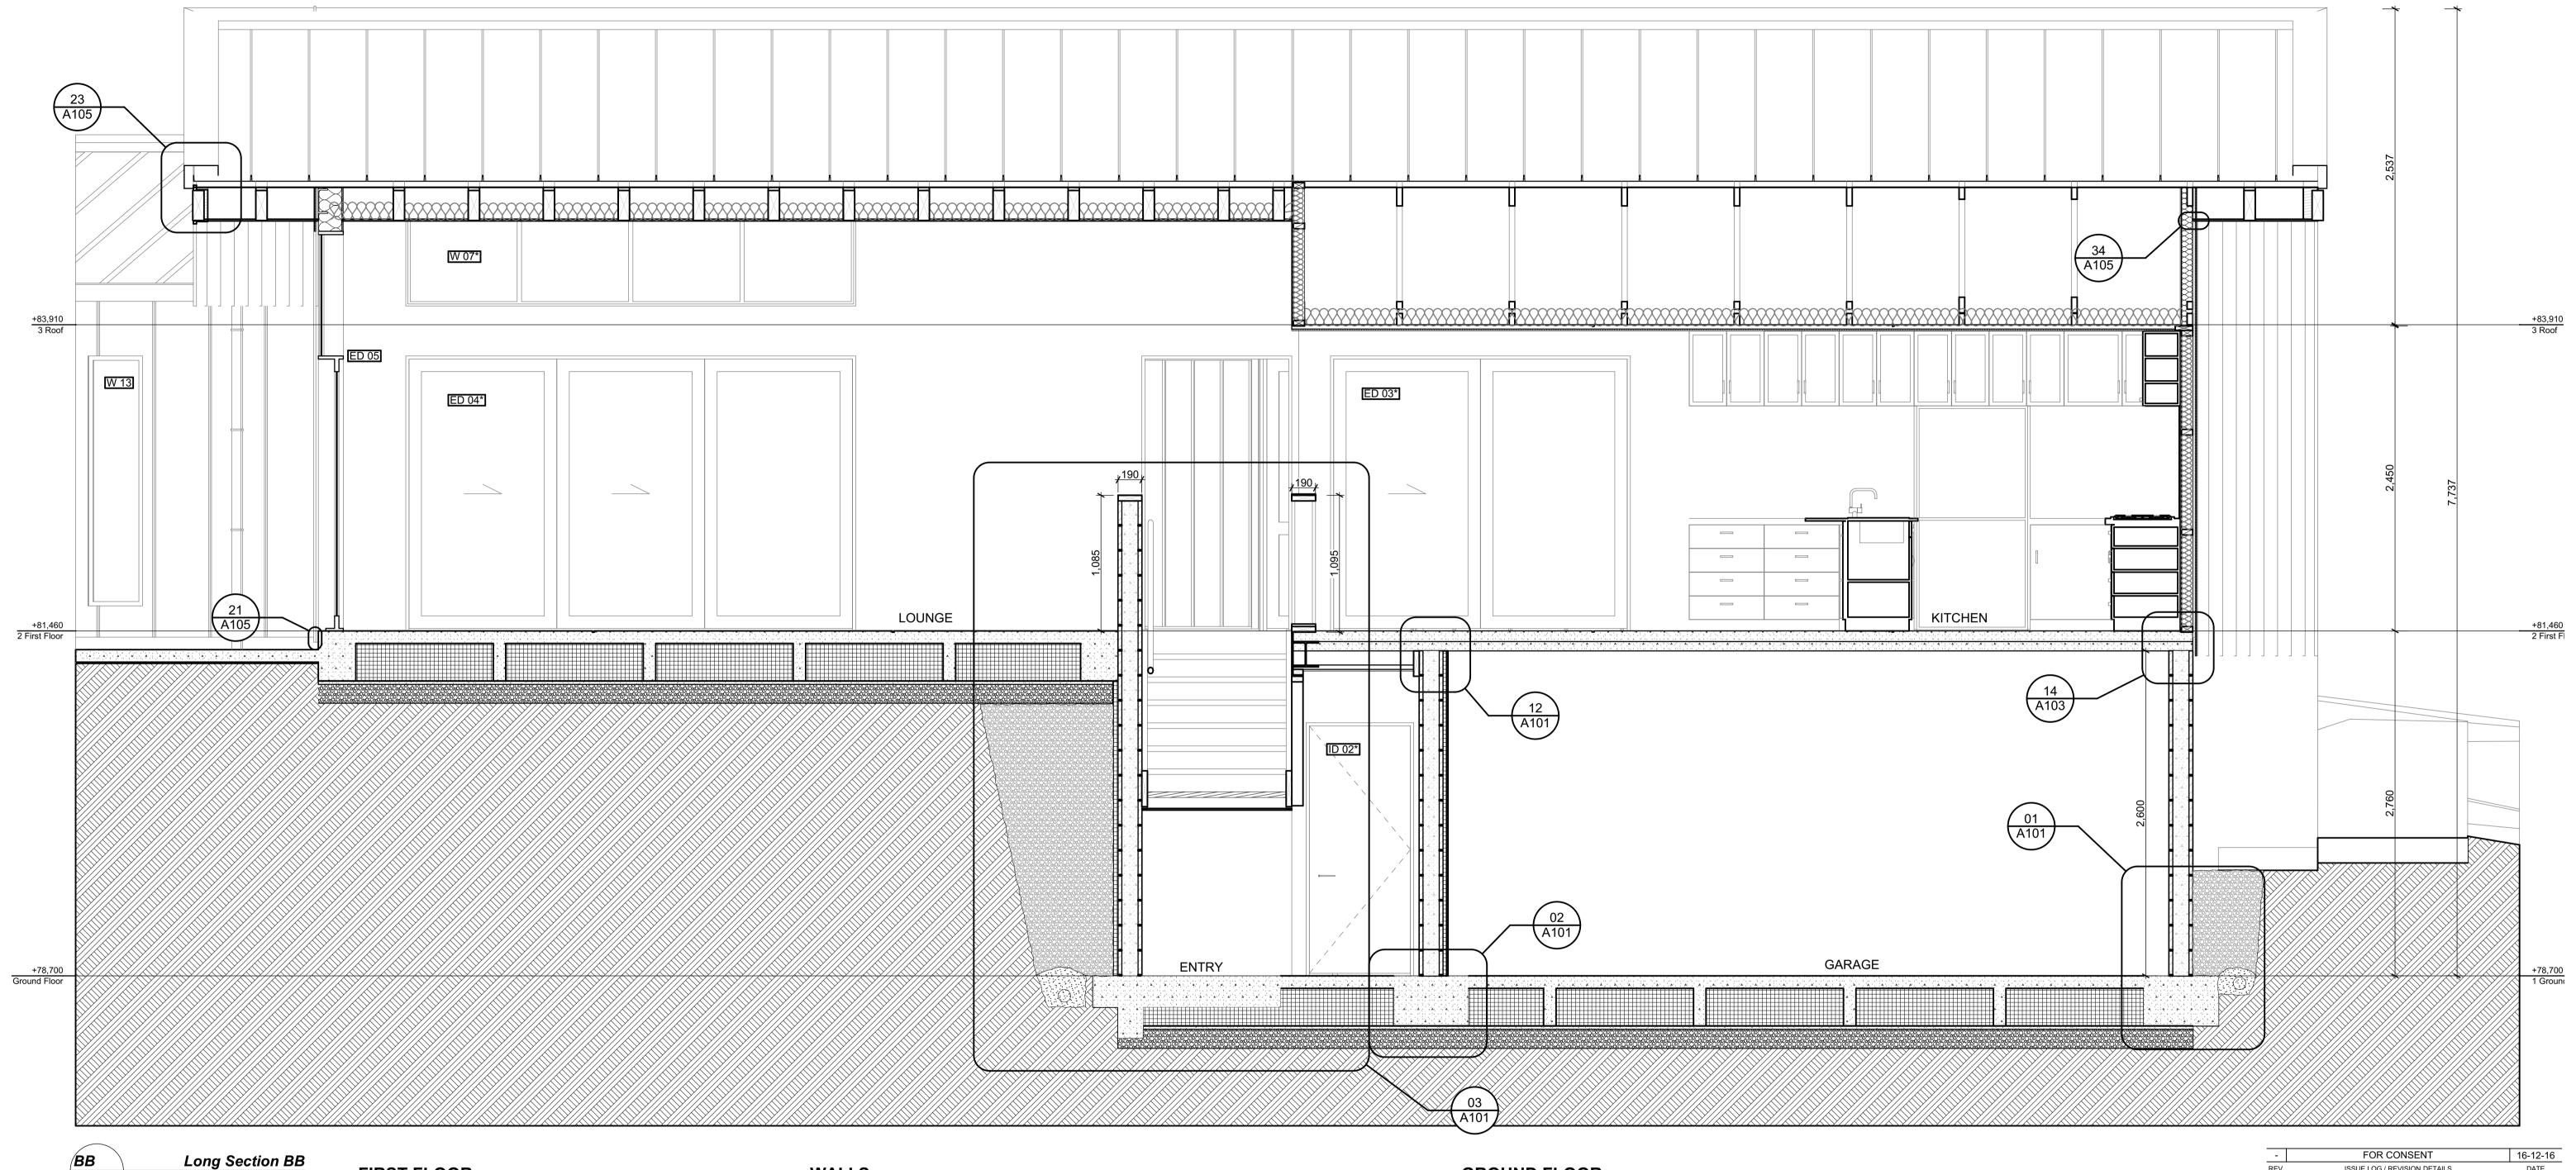Thermakraft 215 self supporting building paper

75 x 45mm Purlins @ 600c/c max.

Rafters and Trusses. (Refer to roof framing plan)

-Cedar Barge board

-Sofit lining :JVC Timber Cedar Shiplap Weatherboards to match cladding

CEILING

-R3.6 Earth Wool for ceiling insulation -13 Gib Ceiling lining

WALLS

-R2.6 Earth wool for wall insulation -JVC Timber Cedar Vertical Shiplap Weatherboards -Eurostyle Spanlok 450 without swages 0.55mm Steel on 12mm ply over 20 x 40mm battens

-Thermakraft 215 self supporting building paper - H1.2 timber framing (Refer to floor plan for stud sizes and

spacings)

-Aluminium powder coated Architectural series joinery with aluminium jamb liners, Aluminium windows to be fitted with

double tongue catches, Very high wind zone
-10mm Gib to walls with paint finish
- Roofing industries R.I. 125mm Box gutter & 75 x 50 Box down

pipe. All elements to be ebony colour

GROUND FLOOR

FIRST FLOOR & CEILING

KITCHEN DINING FLOOR

75mm Unispan and 85mm 30MPa concrete topping -Concrete floor to be polished and sealed

- Entry ceiling to be strapped and lined with 13mm Gib

LOUNGE FLOOR
-Firth Rib raft floor- Refer to details

-Floors to be polished concrete


GROUND FLOOR WALLS

20 Series 25MPa solid filled Architectural Masonry Onyx stack bond block wall with Honed finish. Mortar joints to be Half round / concaved joint.

GROUND FLOOR

-Firth Rib raft floor- Refer to details

-Floors to be polished concrete

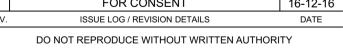



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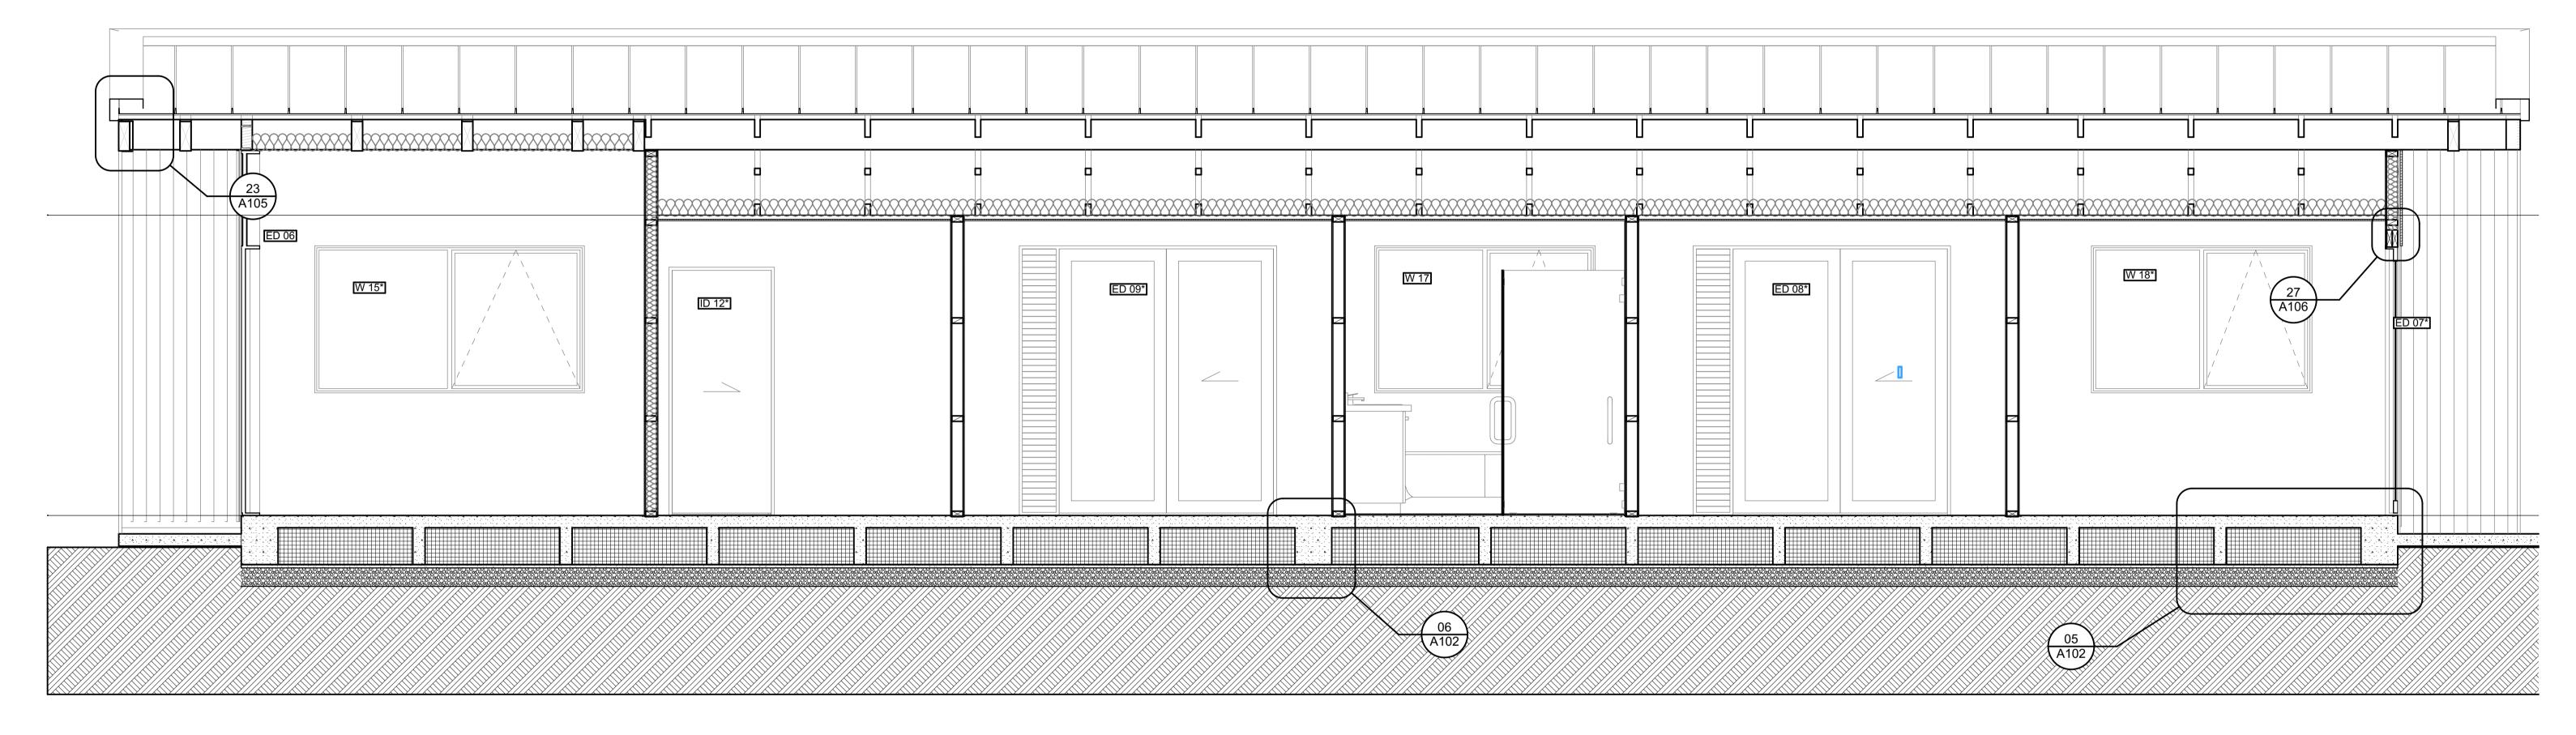
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URQUHARTS HOUSE FOR JAMES CROAD & SHONA POULSON 43 BASIL ROAD, WHANGAREI HEADS, WHANGAREI

SITE DETAILS

LONG	SEC1	ΓΙΟΝ	BB

DATE	CCL REF. No.	DWG NAME REV.		
16-12-16	13060	L107-		
STATUS				
FOR CONSENT	1:25@ A1	SHEET No. 7 OF 25		



ROOF

Roofing iron: Eurostyle Spanlok 450 without swages 0.55mm colour steel MAXX (Ebony colour) Thermakraft 215 self supporting building paper 75 x 45mm Purlins @ 600c/c max.

Rafters and Trusses. (Refer to roof framing plan) -Cedar Barge board -Soffit lining :JVC Timber Cedar Shiplap Weatherboards to match

cladding **CEILING**

- -R3.6 Earth Wool for ceiling insulation -13mm Gib ceiling lining

WALLS

-R2.6 Earth wool for wall insulation

- -JVC Timber Cedar Vertical Shiplap Weatherboards -Eurostyle Spanlok 450 without swages 0.55mm Steel on 12mm ply over 20 x 40mm battens
- -Thermakraft 215 self supporting building paper - H1.2 timber framing (Refer to floor plan for stud sizes and
- spacings) -Aluminium powder coated Architectural series joinery with aluminium jamb liners, Aluminium windows to be fitted with
- double tongue catches, Very high wind zone -10mm Gib to walls with paint finish
- Roofing industries R.I. 125mm Box gutter & 75 x 50 Box down pipe. All elements to be ebony colour

FLOOR

- -Firth Rib raft floor- Refer to details
- -Floors to be carpeted in bedrooms and tiled in bathrooms





ROOF

Roofing iron: Eurostyle Spanlok 450 without swages 0.55mm colour steel MAXX (Ebony colour) laid on

Thermakraft 215 self supporting building paper

75 x 45mm Purlins @ 600c/c max.

Rafters and Trusses. (Refer to roof framing plan) -Cedar Barge board

-Soffit lining :JVC Timber Cedar Shiplap Weatherboards to match cladding

CEILING

-R3.6 Earth Wool for ceiling insulation -13mm Gib to ceiling

WALLS

-R2.6 Earth wool for wall insulation -JVC Timber Cedar Vertical Shiplap Weatherboards -Eurostyle Spanlok 450 without swages 0.55mm Steel on

12mm ply over 20 x 40mm battens -Thermakraft 215 self supporting building paper
- H1.2 timber framing (Refer to floor plan for stud sizes and

-Aluminium powder coated Architectural series joinery with aluminium jamb liners, Aluminium windows to be fitted with double tongue catches, Very high wind zone -10mm Gib to walls with paint finish
- Roofing industries R.I. 125mm Box gutter & 75 x 50 Box down

pipe. All elements to be ebony colour

GROUND FLOOR

FIRST FLOOR & CEILING

KITCHEN DINING FLOOR

75mm Unispan and 85mm 30MPa concrete topping -Concrete floor to be polished and sealed - Entry ceiling to be strapped and lined with 13mm Gib to ceiling


LOUNGE FLOOR
-Firth Rib raft floor- Refer to details -Floors to be polished concrete


GROUND FLOOR WALLS

20 Series 25MPa solid filled Architectural Masonry stack bond block wall with Honed finish. Mortar joints to be Half round / concaved joint.


GROUND FLOOR


-Firth Rib raft floor- Refer to details -Floors to be polished concrete

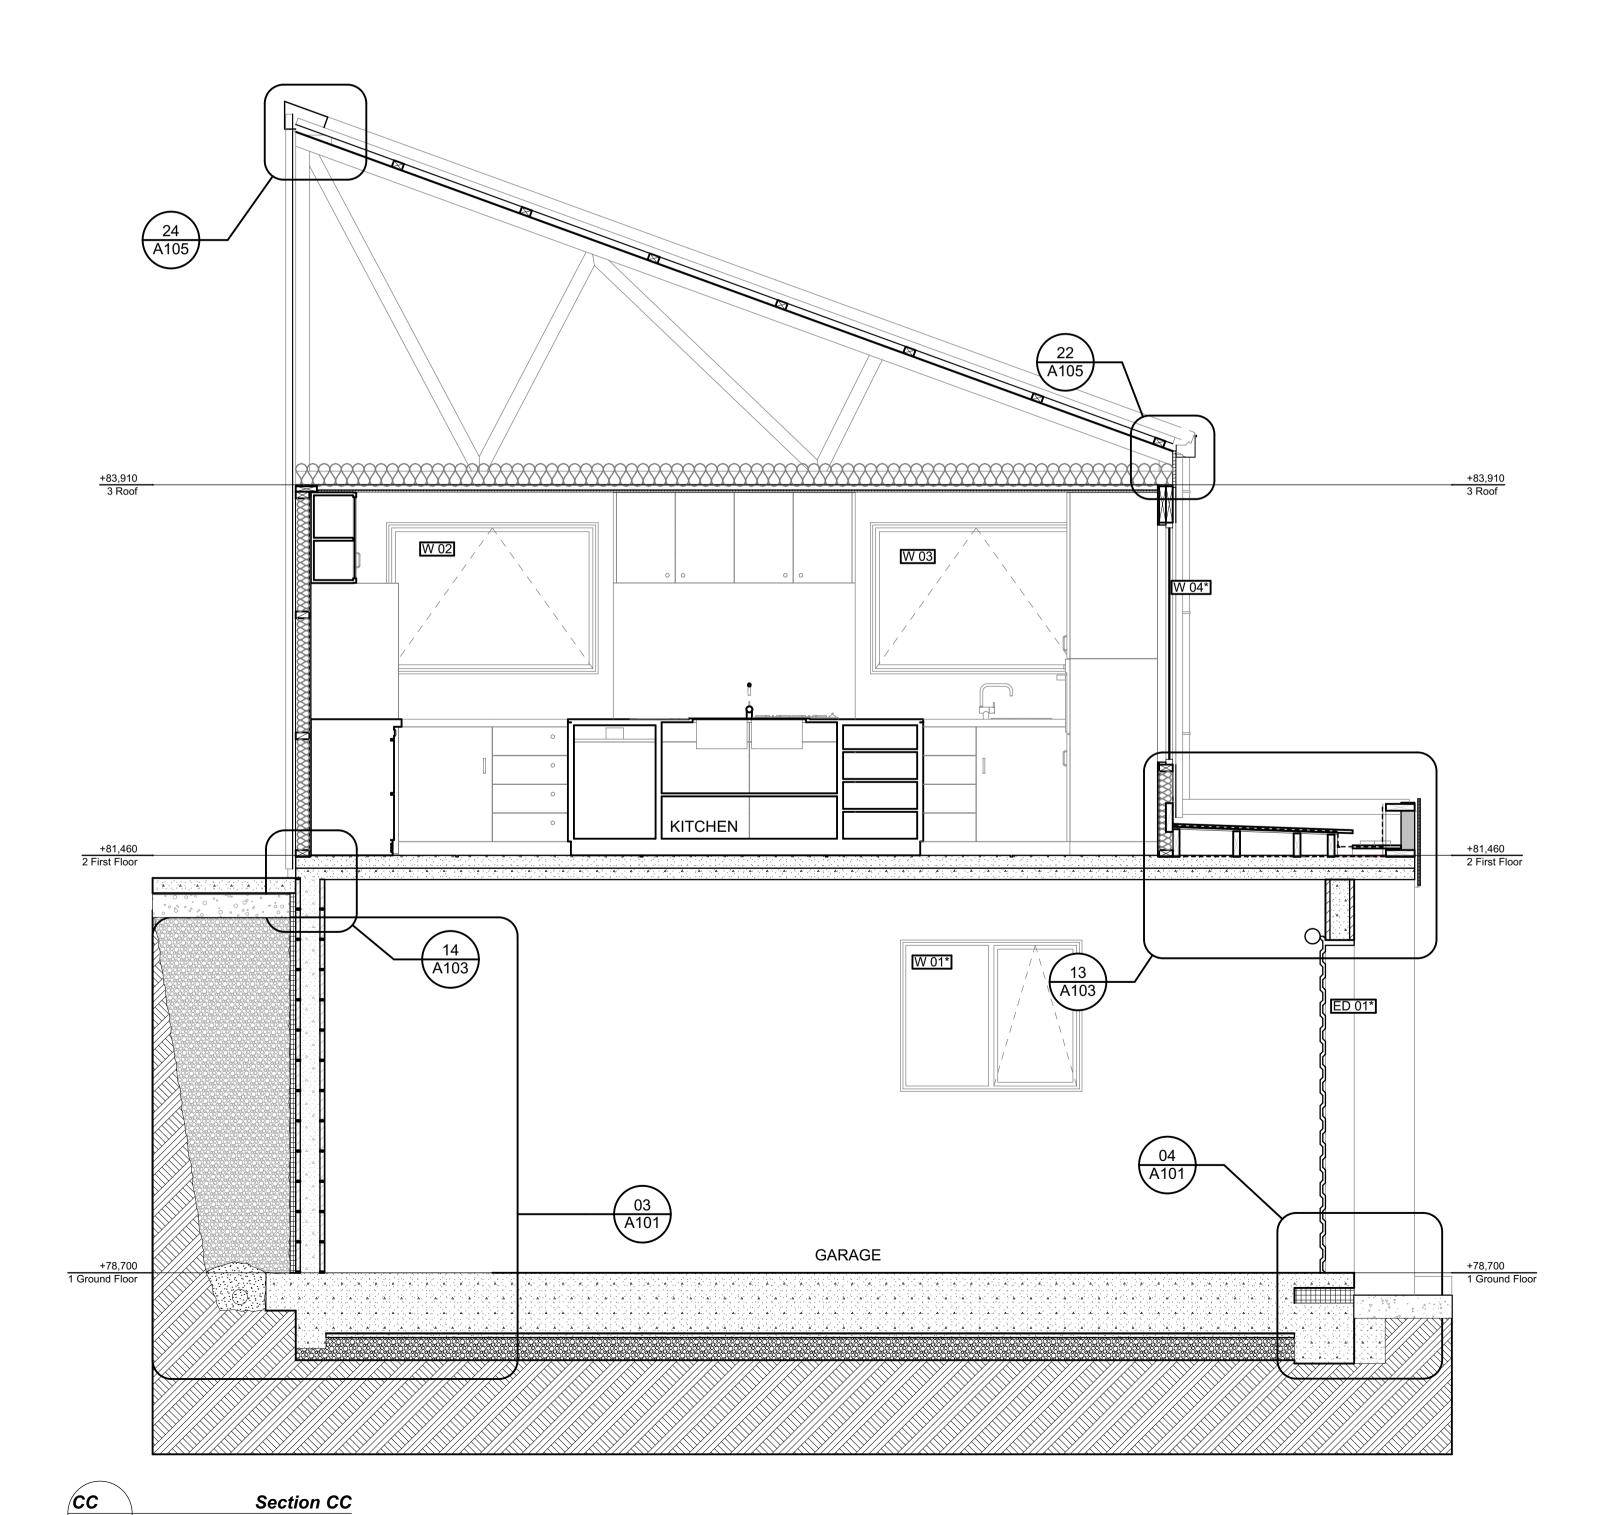

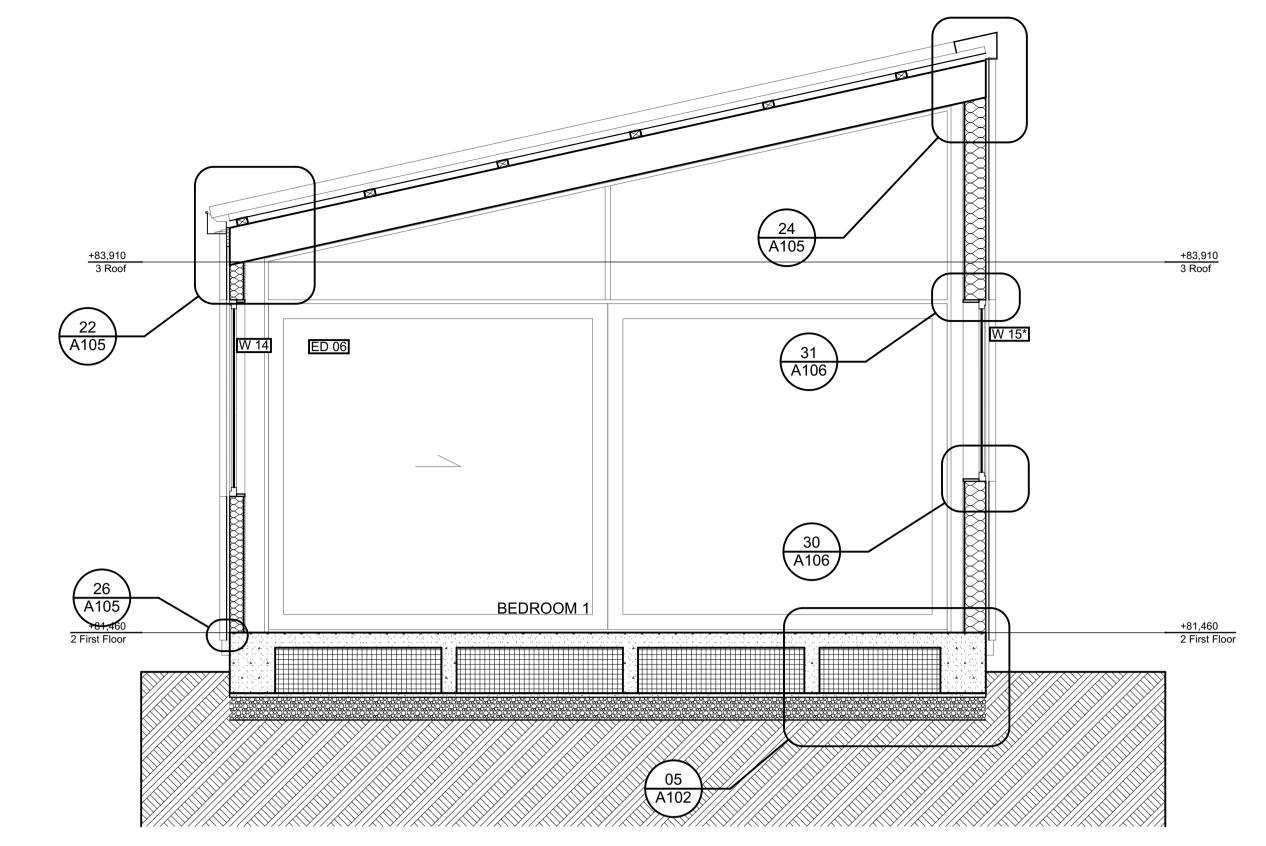

Section DD 1:25

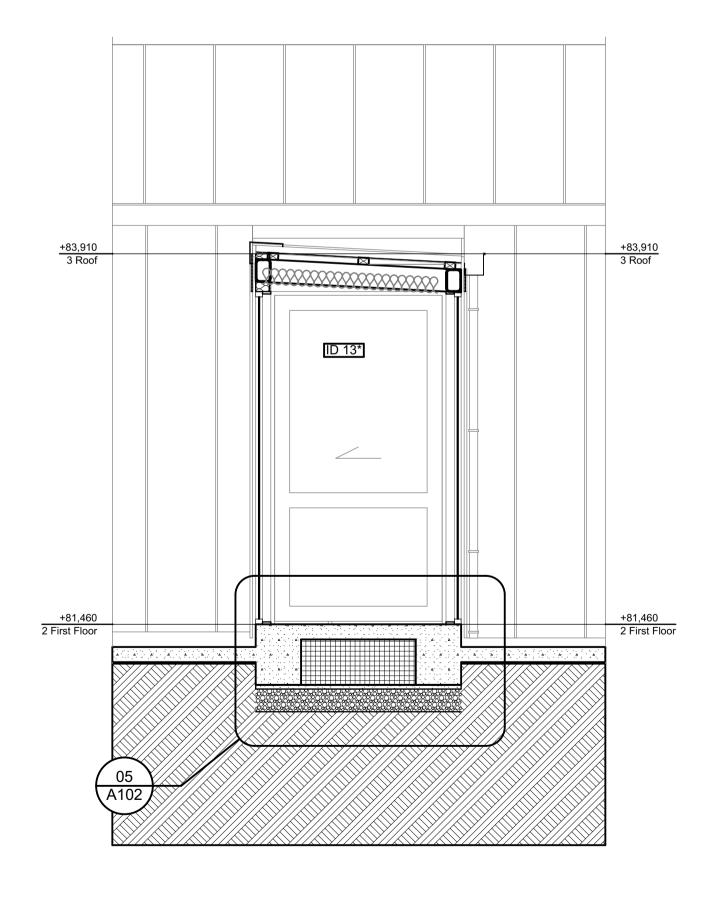

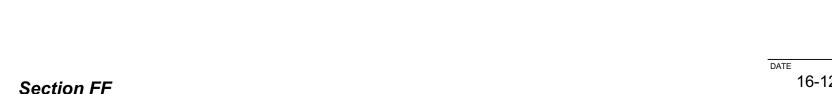

16-12-16 13060 FOR CONSENT SCALE 1:25@ A1 DATE PLOTTED: **19/12/2016** FILE PATH: Z:\13000- 13499\13060 - 43 Basil Road \CAD\161219 For Consent JJ.pln

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URQUHARTS HOUSE

FOR JAMES CROAD & SHONA POULSON

43 BASIL ROAD, WHANGAREI HEADS, WHANGAREI

CROSS SECTION

SITE DETAILS

cook | costello

16-12-16

Section FF 1:25

ROOF

Roofing iron: Eurostyle Spanlok 450 without swages 0.55mm colour steel MAXX (Ebony colour)

Thermakraft 215 self supporting building paper

75 x 45mm Purlins @ 600c/c max.

Rafters and Trusses. (Refer to roof framing plan) -Cedar Barge board

-Soffit lining :JVC Timber Cedar Shiplap Weatherboards to match cladding

25 A105

CEILING

+83,910 3 Roof

-R3.6 Earth Wool for ceiling insulation -13mm Gib to ceiling

WALLS

-R2.6 Earth wool for wall insulation

-JVC Timber Cedar Vertical Shiplap Weatherboards -Eurostyle Spanlok 450 without swages 0.55mm Steel on 12mm ply over 20 x 40mm battens

-Thermakraft 215 self supporting building paper
- H1.2 timber framing (Refer to floor plan for stud sizes and

-Aluminium powder coated Architectural series joinery with aluminium jamb liners, Aluminium windows to be fitted with double tongue catches, Very high wind zone -10mm Gib to walls with paint finish
- Roofing industries R.I. 125mm Box gutter & 75 x 50 Box down

pipe. All elements to be ebony colour

W 08*

GROUND FLOOR

FIRST FLOOR & CEILING

KITCHEN DINING FLOOR

75mm Unispan and 85mm 30MPa concrete topping -Concrete floor to be polished and sealed - Entry ceiling to be strapped and lined with 13mm Gib to ceiling


LOUNGE FLOOR
-Firth Rib raft floor- Refer to details -Floors to be polished concrete


GROUND FLOOR WALLS

20 Series 25MPa solid filled Architectural Masonry stack bond block wall with Honed finish. Mortar joints to be Half round / concaved joint.

GROUND FLOOR

-Firth Rib raft floor- Refer to details -Floors to be polished concrete

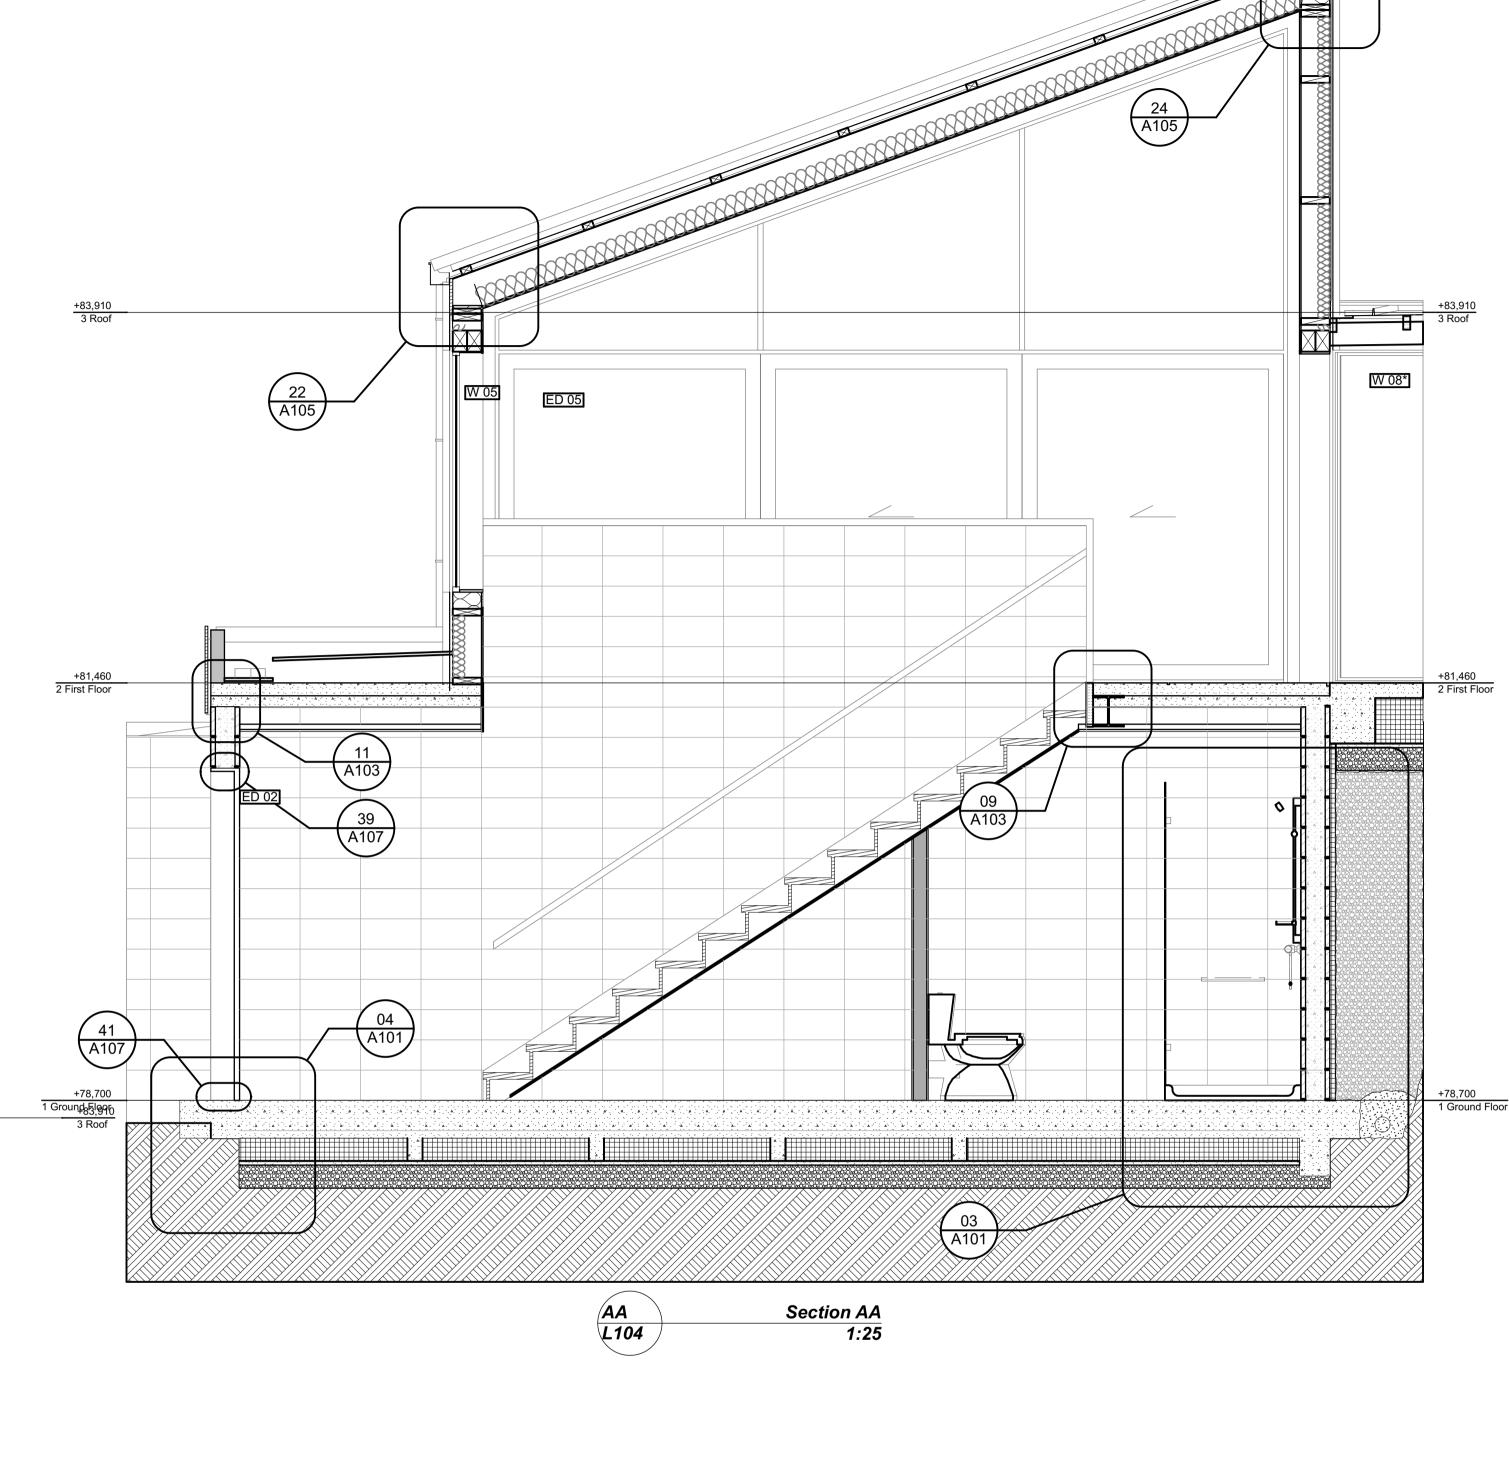

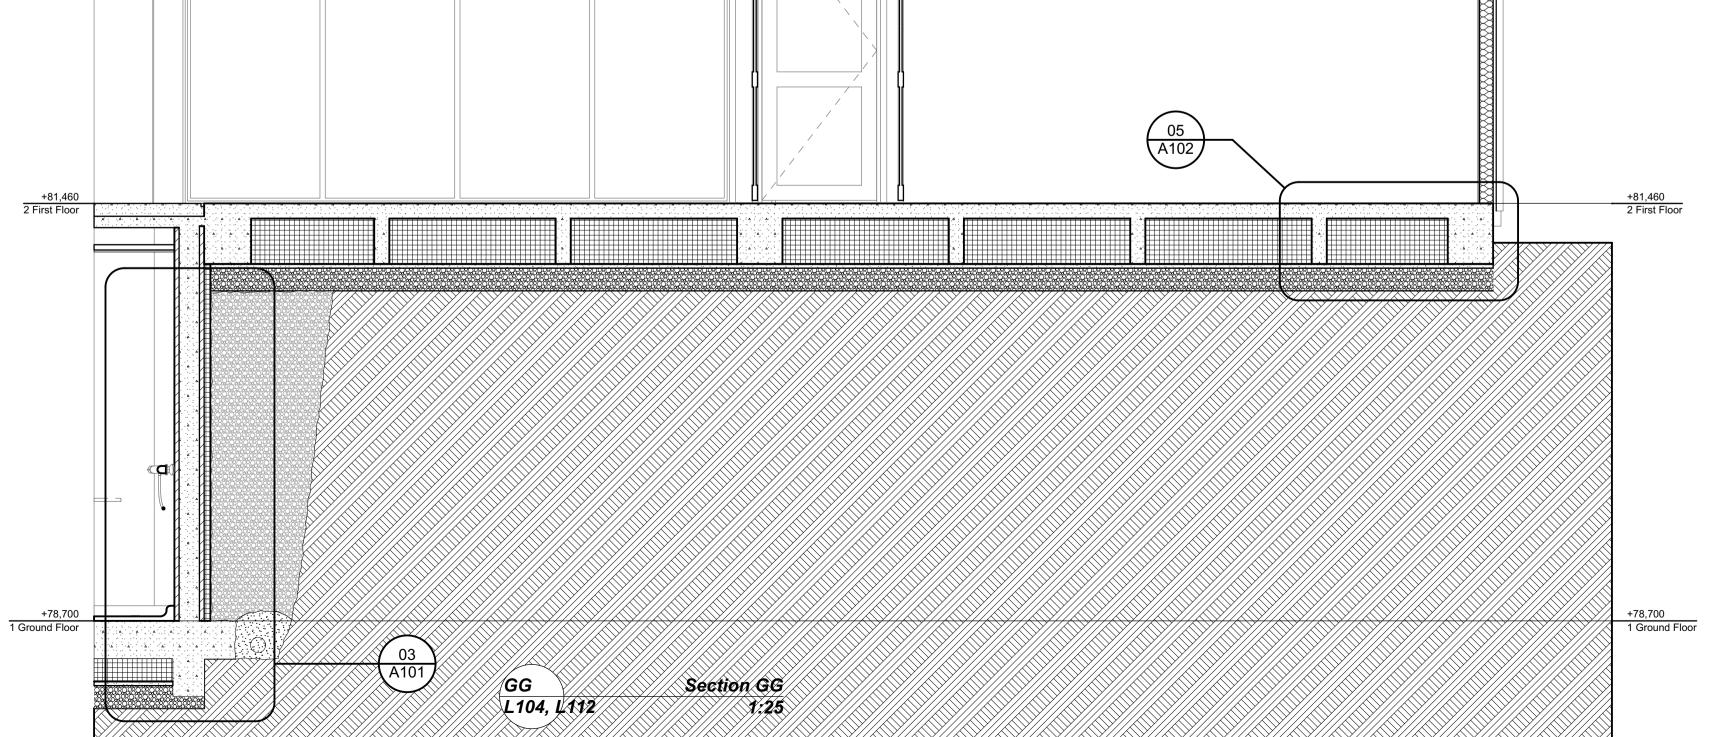

ID 10

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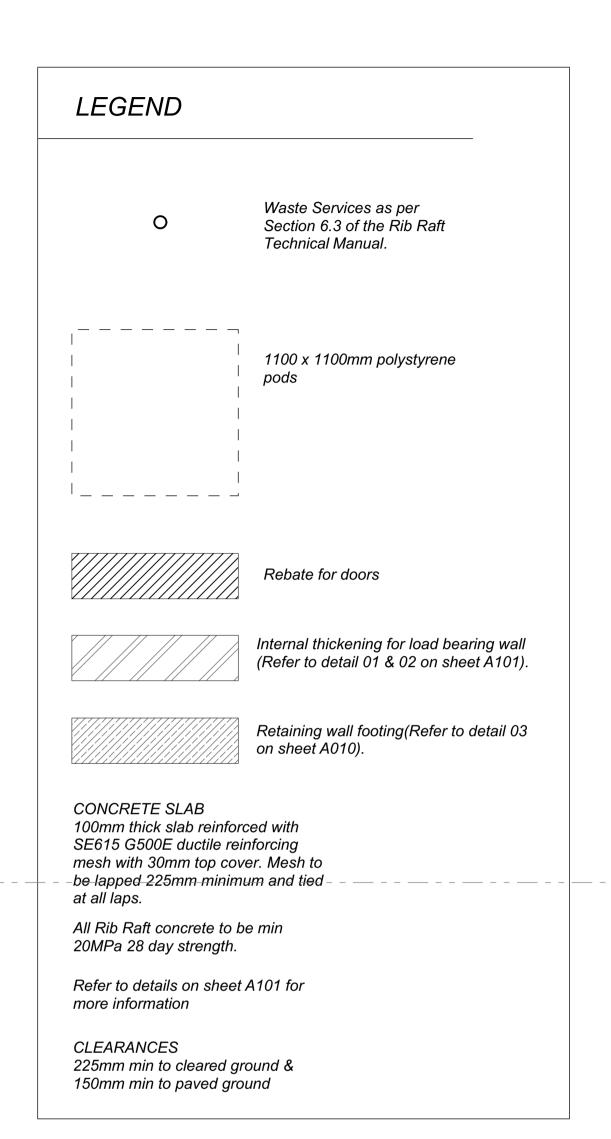
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SITE DETAILS URQUHARTS HOUSE FOR JAMES CROAD & SHONA POULSON 43 BASIL ROAD, WHANGAREI HEADS, WHANGAREI

CROSS SECTIONS

DWG NAME REV. 16-12-16 L110-13060 FOR CONSENT 1:25@ A1 DATE PLOTTED: **19/12/2016** FILE PATH: Z:\13000- 13499\13060 - 43 Basil Road \CAD\161219 For Consent JJ.pln





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> GROUND FLOOR FOUNDATION PLAN 1:25

1,100 100_k 1,100 100_k 1,100 100_k 1,100 y 600 y 795 y

600 100_/ /



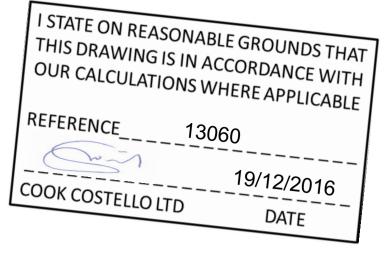

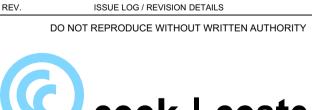FOR CONSENT

16-12-16

DATE




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SITE DETAILS URQUHARTS HOUSE FOR JAMES CROAD & SHONA POULSON 43 BASIL ROAD, WHANGAREI HEADS, WHANGAREI

GROUND FLOOR FOUNDATION PLAN

DWG NAME REV. CCL REF. No. 16-12-16 L111-13060 STATUS FOR CONSENT SCALE 1:25@ A1 HEET No. 11 OF 25 DATE PLOTTED: **19/12/2016** FILE PATH: Z:\13000- 13499\13060 - 43 Basil Road \CAD\161219 For Consent JJ.pln



FIRST FLOOR FOUNDATION PLAN

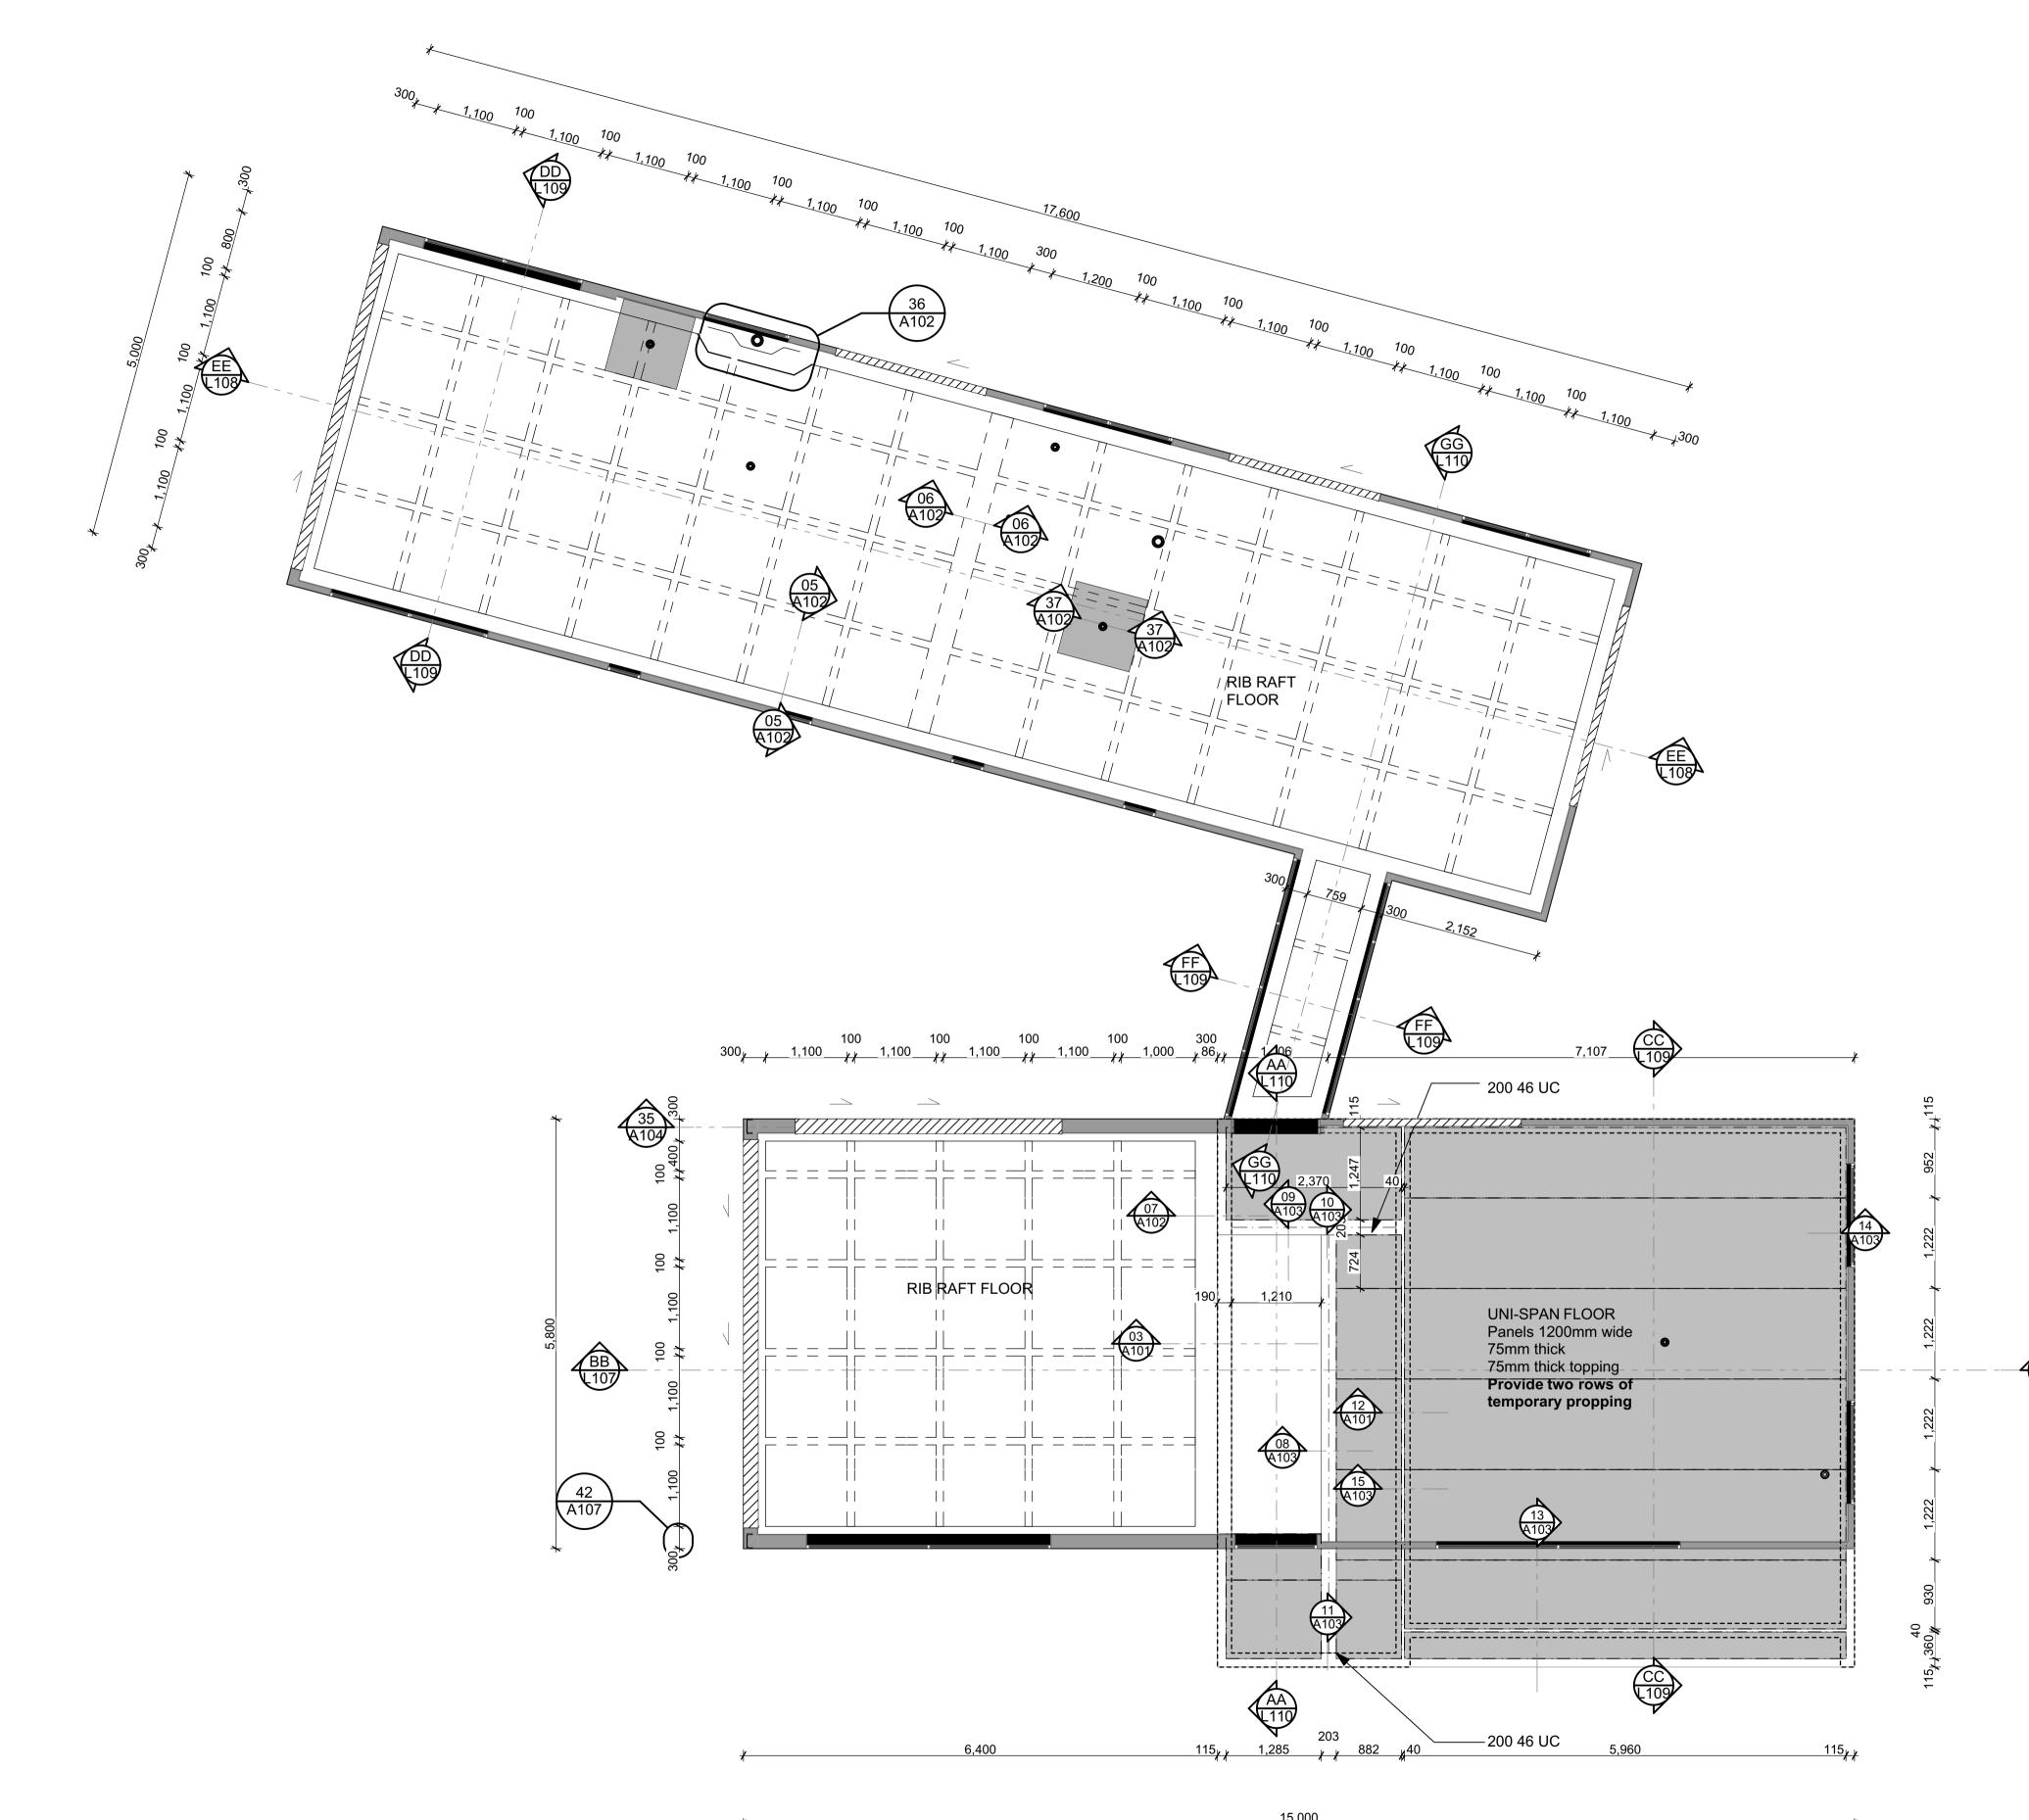1:50

LEGEND

Waste Services as per Section 6.3 of the Rib Raft

Refer to detail 36 on sheet A102

1100 x 1100mm polystyrene

Rebated 1m x 1m shower. refer to detail 37 on sheet

75mm Thick Unispan

Rebate for doors

100mm thick slab reinforced with SE615 G500E ductile reinforcing mesh with 30mm top cover. Mesh to

be lapped 225mm minimum and tied

All Rib Raft concrete to be min 20MPa

Refer to details on sheet A102 for

225mm min to cleared ground & 150mm min to paved ground

CONCRETE SLAB

at all laps.

28 day strength.

more information

CLEARANCES

reinforcing around waste penetration Waste Services as per Section 6.3 of the Rib Raft Technical Manual.

Technical Manual.



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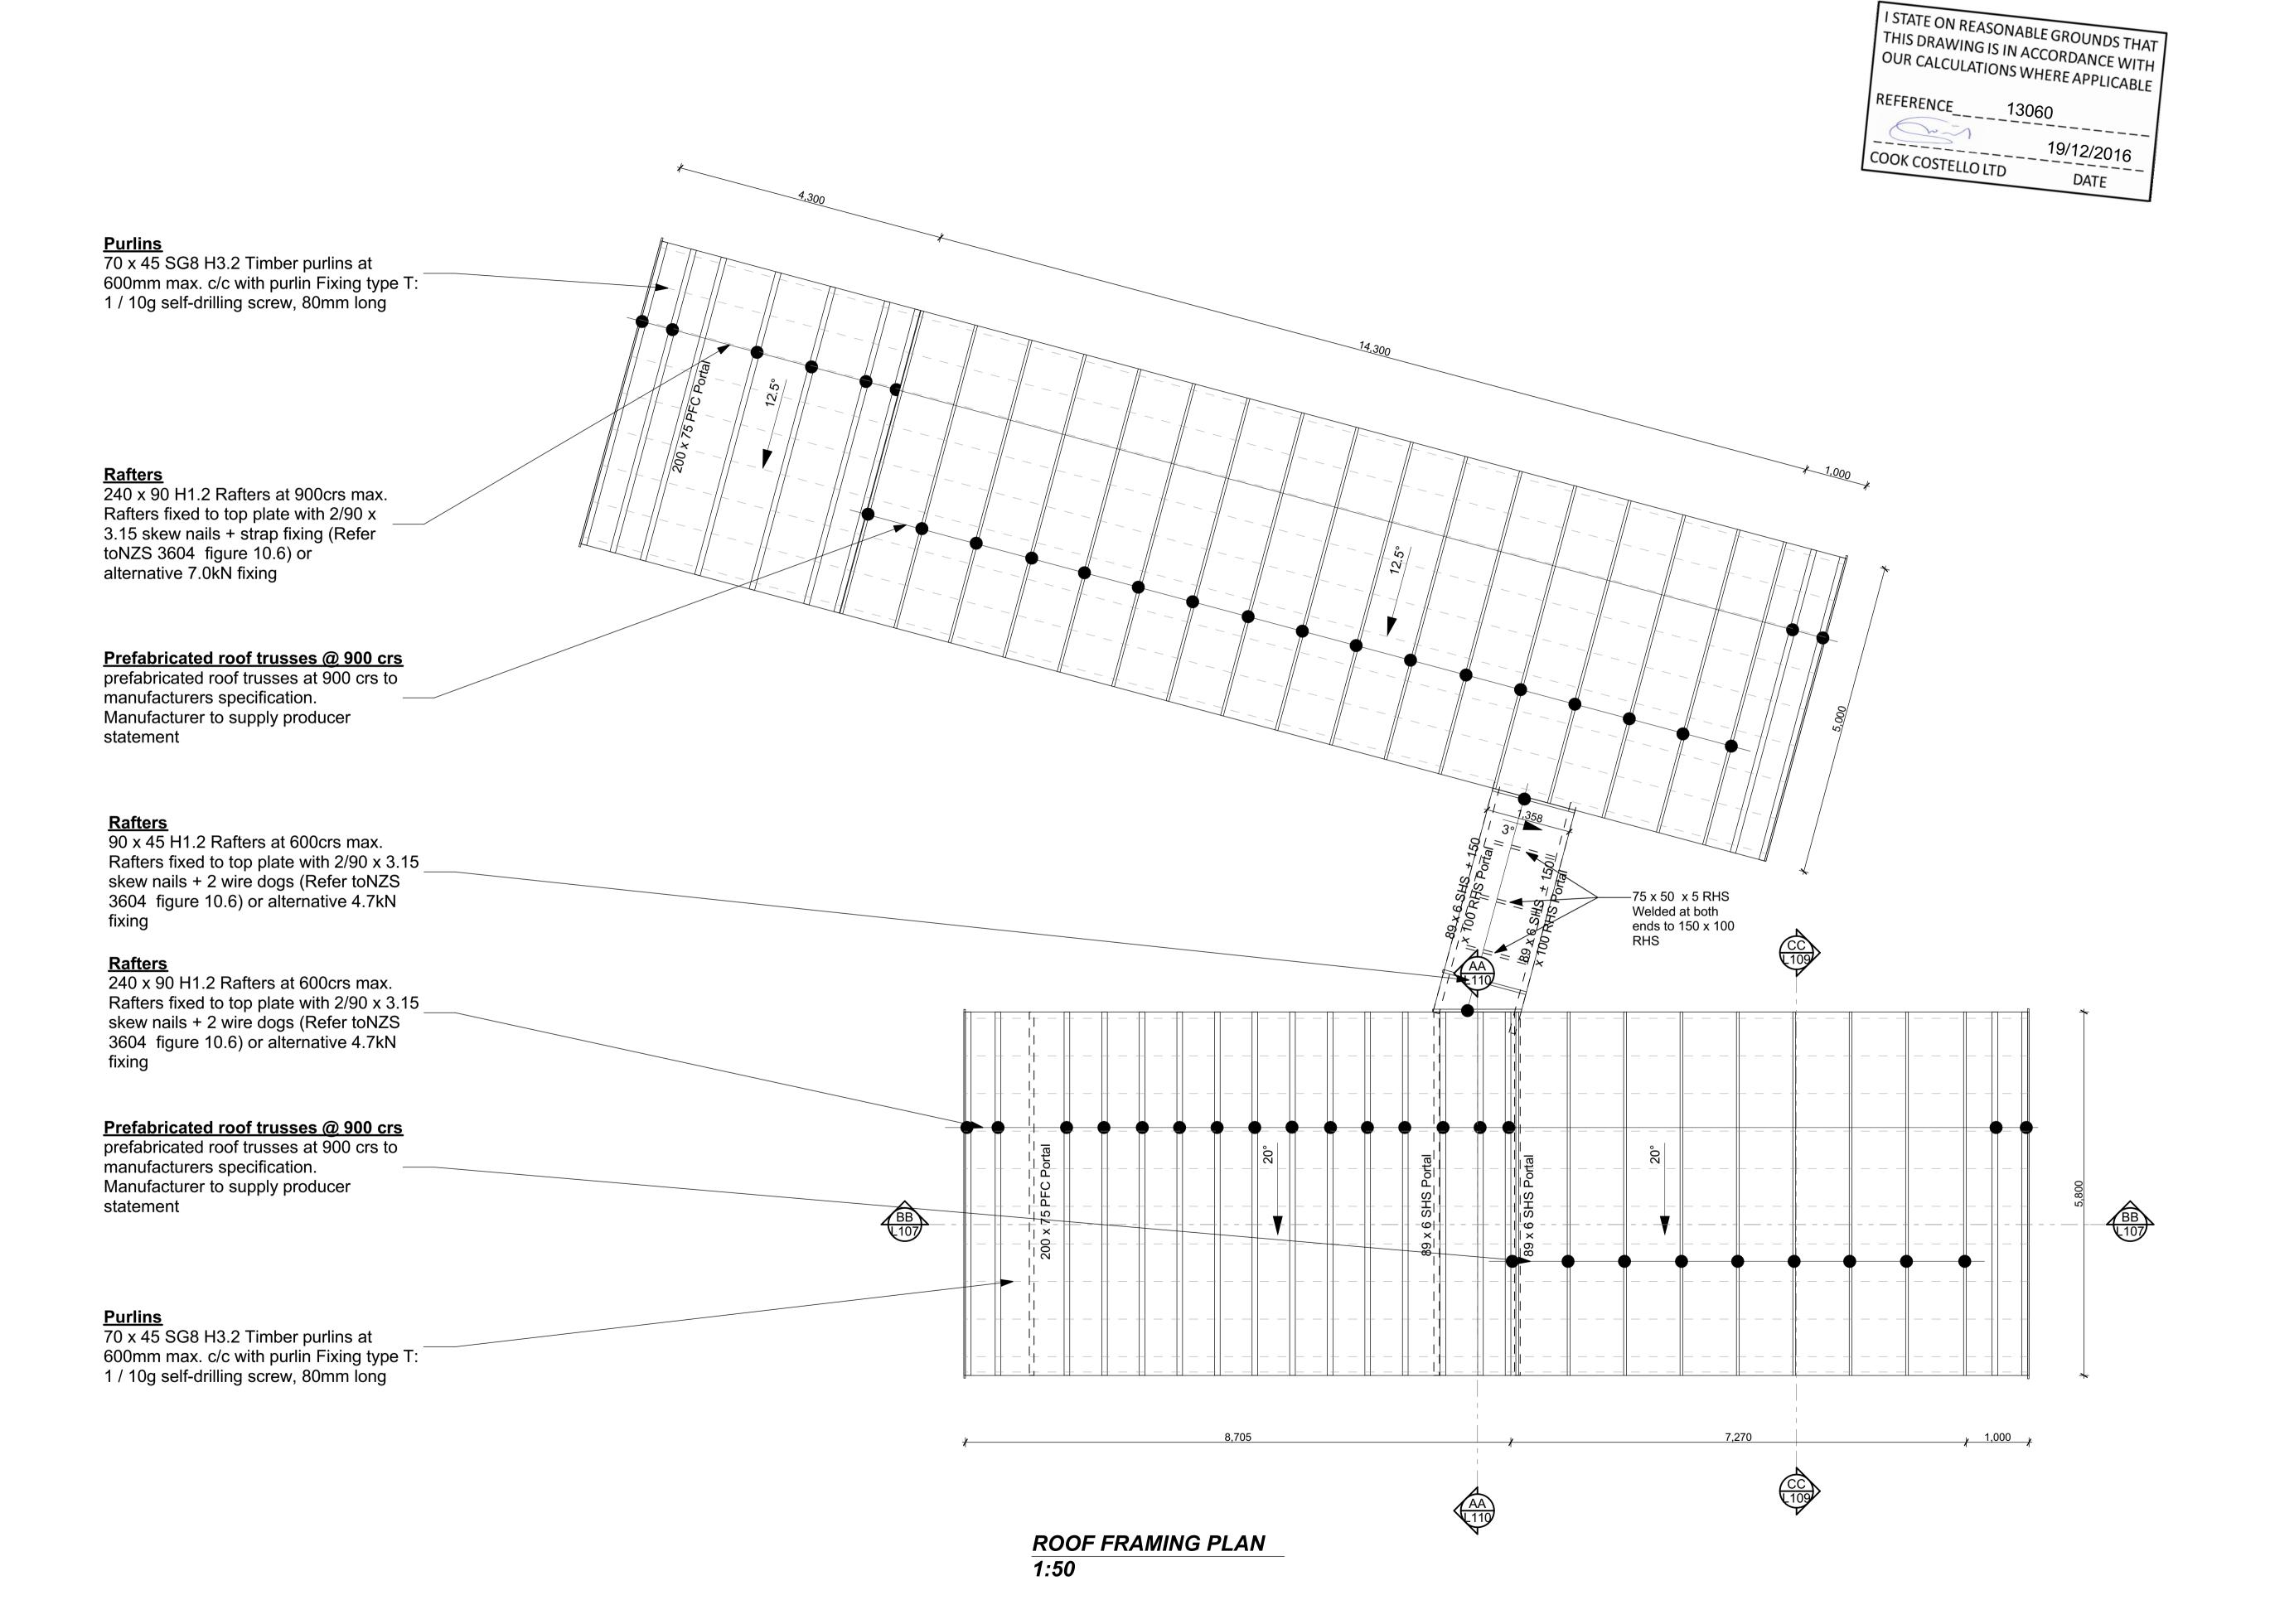
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SITE DETAILS URQUHARTS HOUSE FOR JAMES CROAD & SHONA POULSON 43 BASIL ROAD, WHANGAREI HEADS, WHANGAREI

FIRST FLOOR FOUNDATION PLAN

16-12-16 L112-13060 STATUS EET No. 12 OF 25 FOR CONSENT 1:50@ A1 DATE PLOTTED: **19/12/2016** FILE PATH: Z:\13000- 13499\13060 - 43 Basil Road \CAD\161219 For Consent JJ.pln



LEGEND

FIXINGS:

70 x 45 SG8 H3.2 Timber purlins at 600mm max. c/c with fixing type: T -1 / 10g self-drilling screw, 80mm long

Truss fixing to be NZS: 3604 Type E: 2 / 90 x 3.15 skew nails + 2 Wire dogs. for walls with 3.0 - 3.5m loaded Dimension

Rafter fixing to be NZS: 3604 Type E where specified: 2 / 90 x 3.15 skew nails + 2 Wire dogs

Rafter fixing to be NZS: 3604 Type F where specified: 2 / 90 x 3.15 skew nails + Strap fixing

LININGS:

Soffit lining to be Cedar shiplap weatherboards Ceiling linings to be 13mm Gib on 35 x 70 ceiling battens at 600mm max.

NOTE:

These drawings are to be read in conjunction with the truss design (MiTek New Zealand Ltd Dated 09-12-2016), and all other related documents and standards. Contact the architect/designer in any discrepancies found.

INSULATION:

Ceiling to have a minimum or R3.6 insulation.

FOR CONSENT ISSUE LOG / REVISION DETAILS

SITE DETAILS

16-12-16

16-12-16 DO NOT REPRODUCE WITHOUT WRITTEN AUTHORITY



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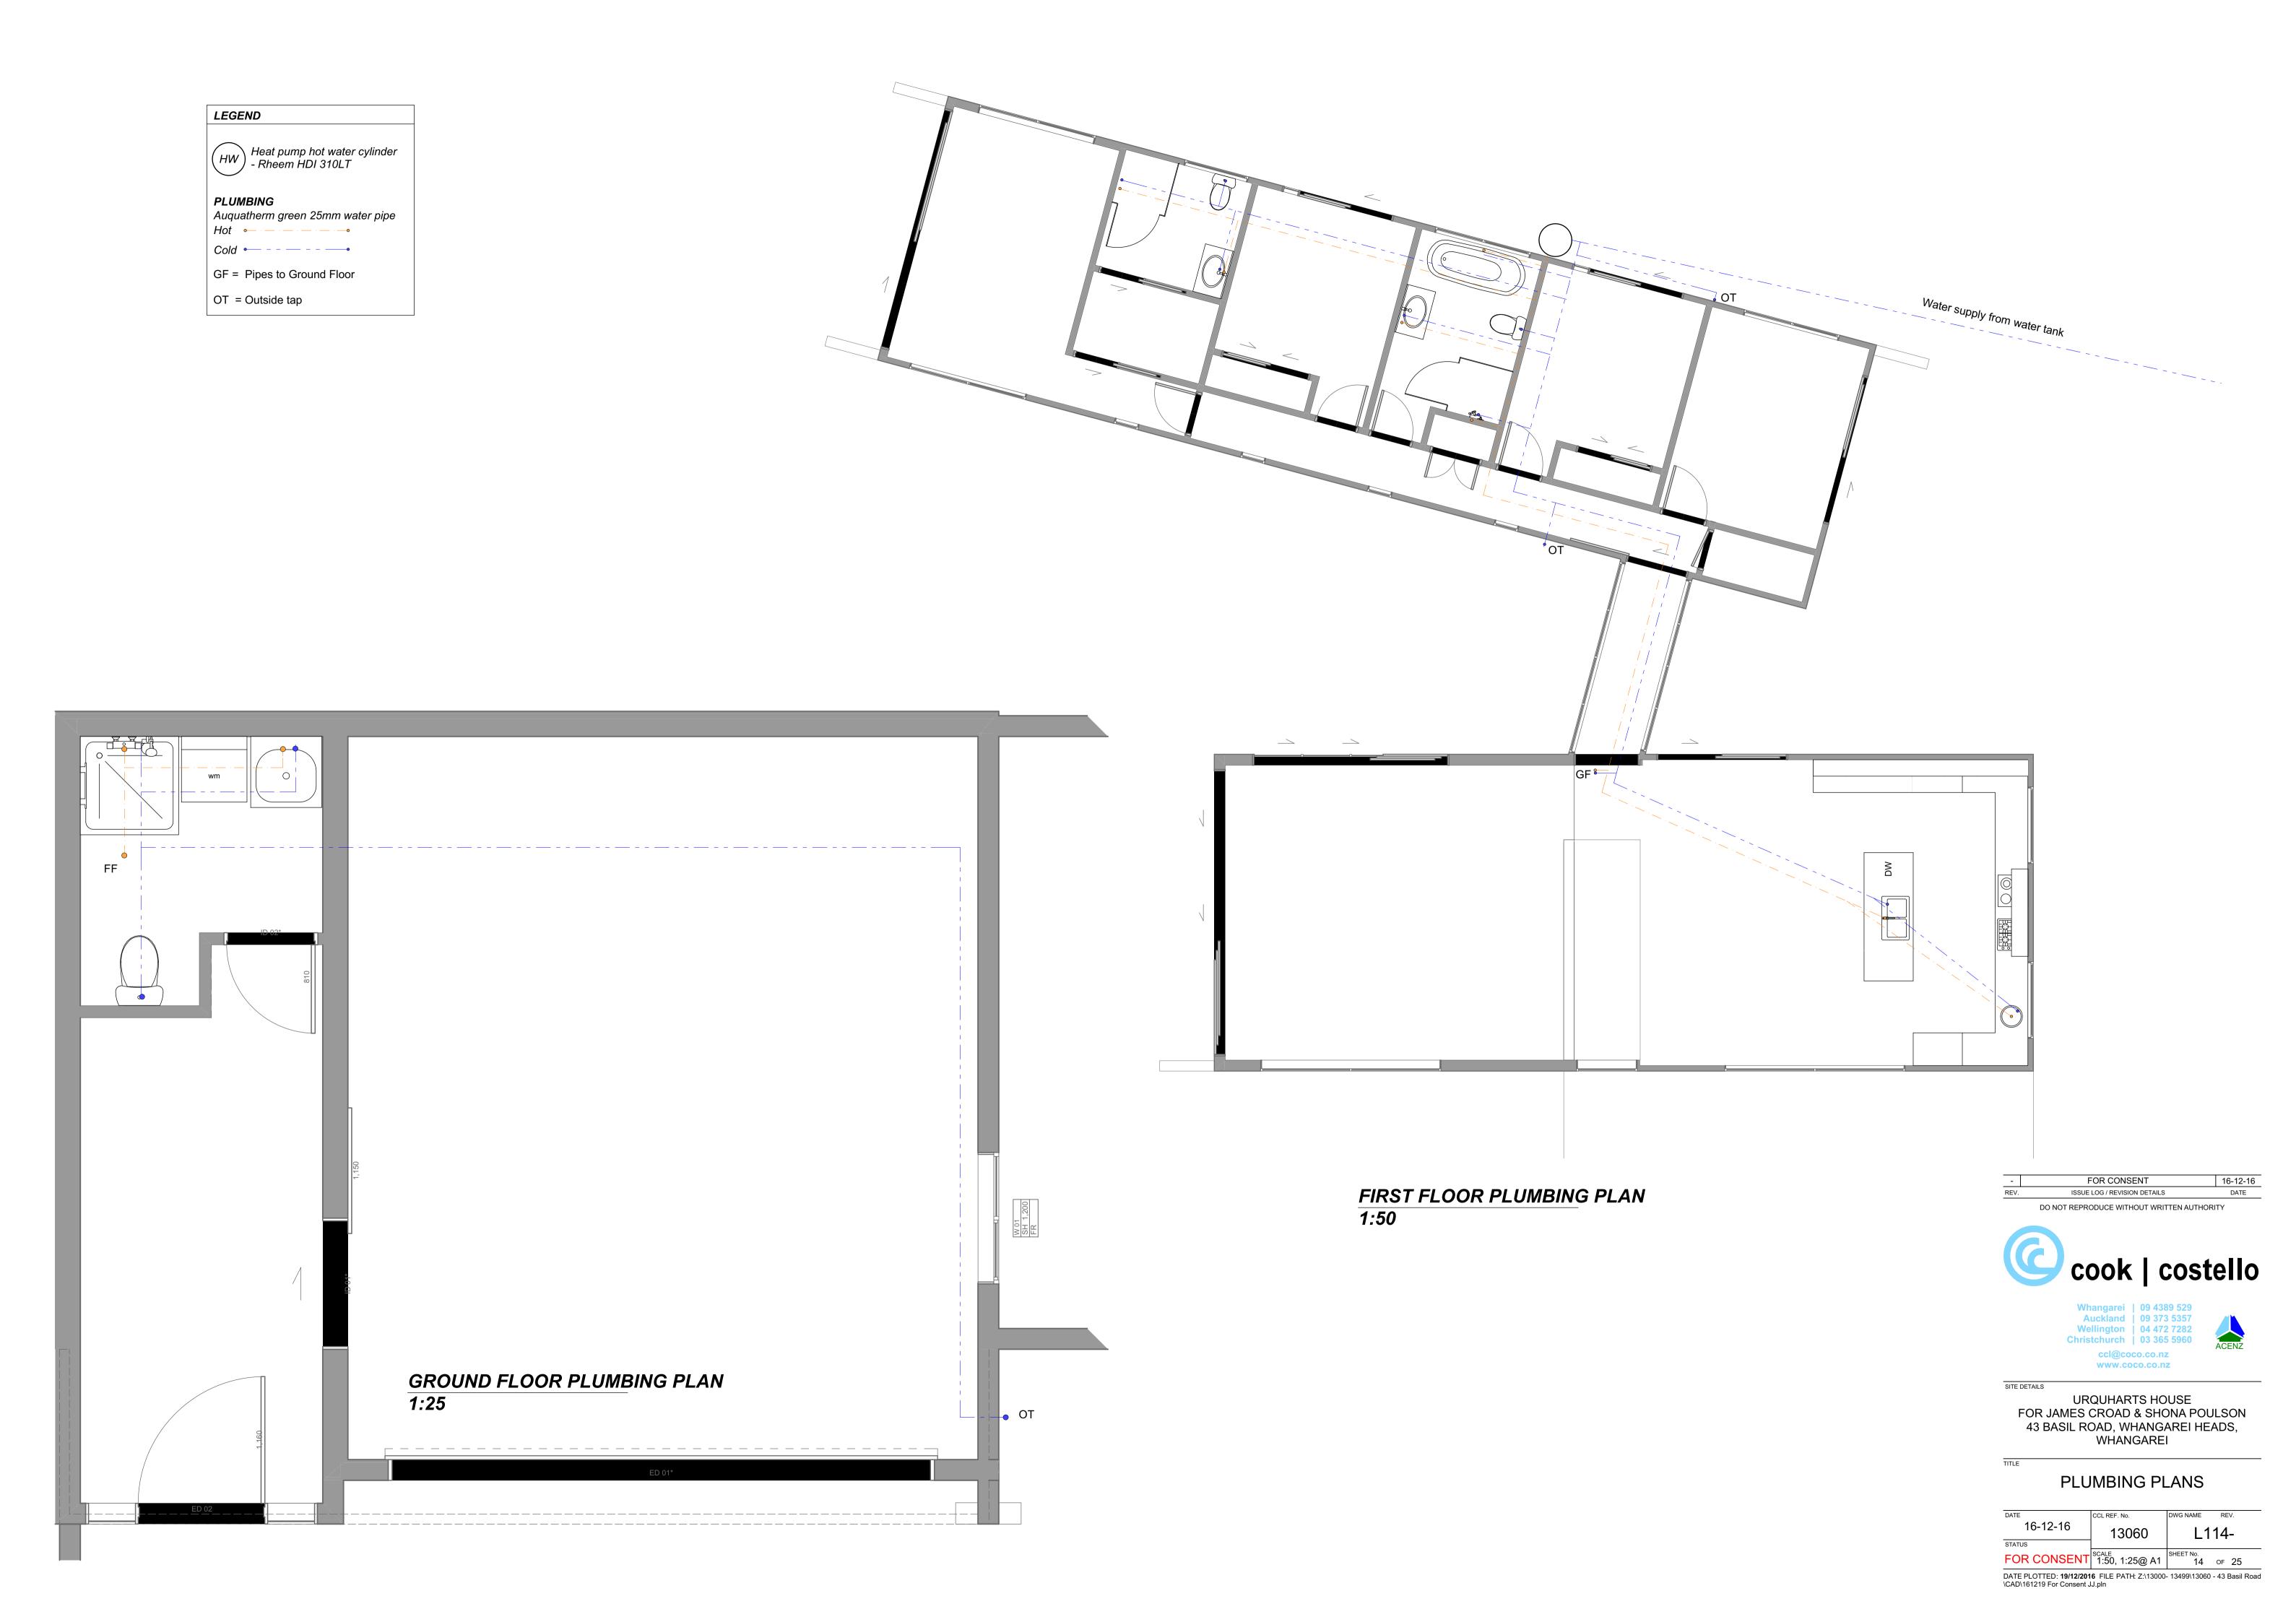
www.coco.co.nz URQUHARTS HOUSE


FOR JAMES CROAD & SHONA POULSON 43 BASIL ROAD, WHANGAREI HEADS,


WHANGAREI

ROOF FRAMING PLAN

L113-13060 FOR CONSENT SCALE 1:50@ A1 DATE PLOTTED: **19/12/2016** FILE PATH: Z:\13000- 13499\13060 - 43 Basil Road \CAD\161219 For Consent JJ.pln



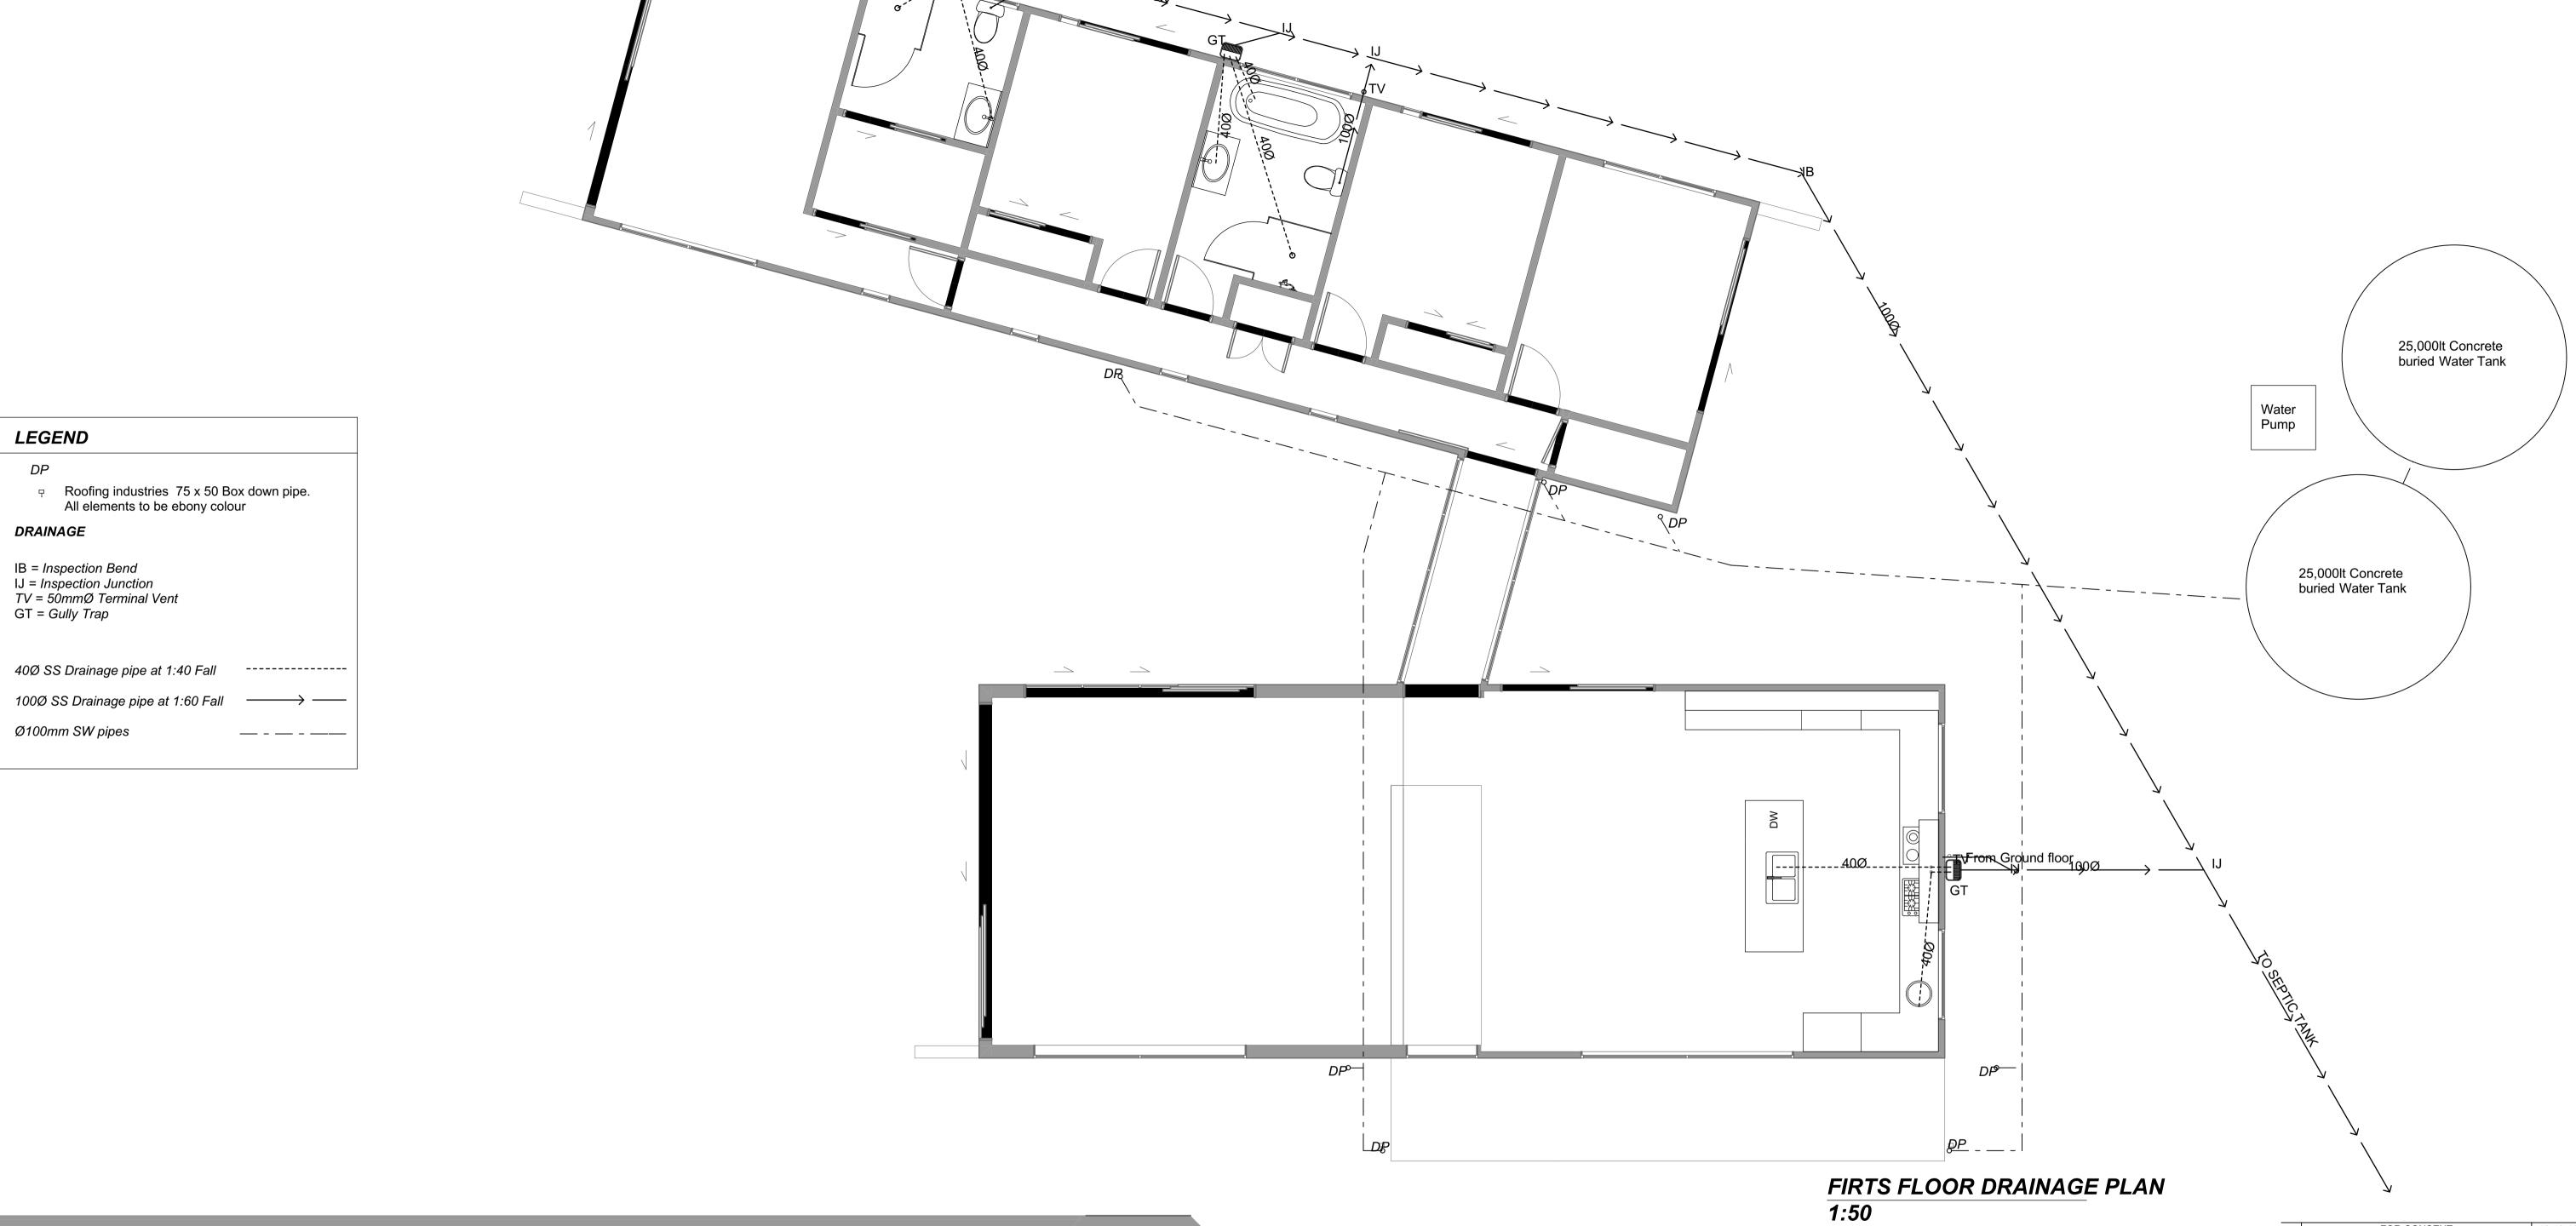

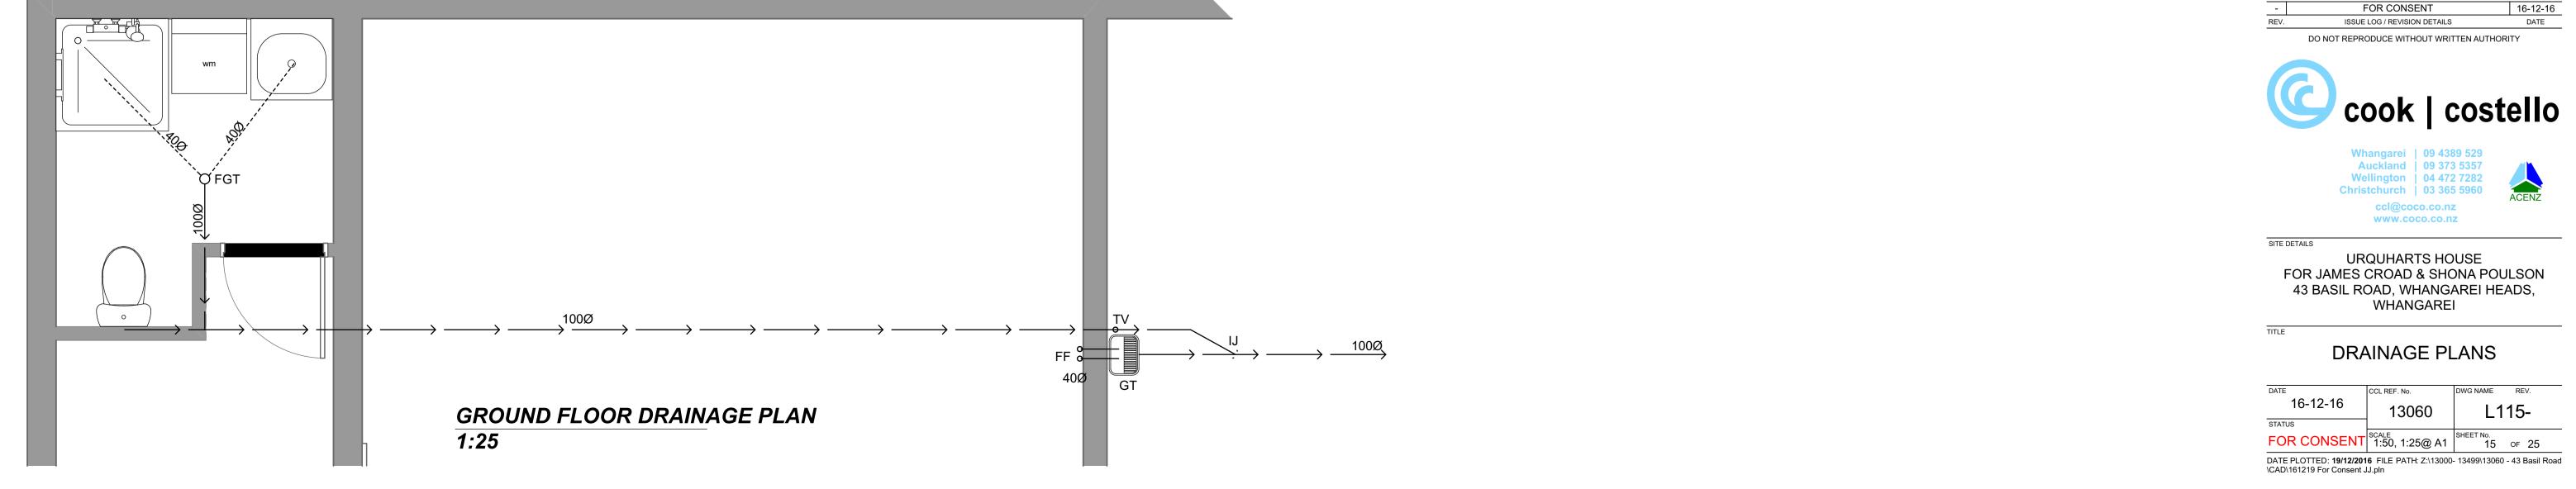

BRACING CALCULATIONS - BE	EDROOM WING		
Location of Storey	Single	Floor Load	2kPa
Floor Height to Apex	5.0 m	Roof Weight	Light
Roof Height Above Eaves	2.0 m	Cladding Weights:	
Roof Pitch	0 - 25 °	- Subfloor	Concrete Floor
Roof Style	Monopitch	- Wall Cladding	Light
Building Length (BL)	17.6 m	Building Width (BW)	5.0 m
Room in Roof Space	0	Wind Zone	Very High
Soil Class	E - Very Soft	W along	71.5 BUs/m
Gross Plan Area (GPA)	88.0 m2	W across	71.5 BUs/m
Earthquake Zone	1	W along x BW	357.5 BUs
EQ	3.0 BUs/m2	W across x BL	1,258.4 BUs
EQ x GPA	264.0 BUs		

Calculations are based on NZS3604:2011

AL	ONG	•	

ALONG	•										
Bracing	Line		Bracing	Elements	Provided			Wind		Earthqu	ake
Line	Min BUs	Min BUs	Brace	Brace	Brace	Brace	Brace	Rating	BUs	Rating	BUs
Label	W	E	No.	Type	Length	Angle	Height	BUs/m	Achieved	BUs/m	Achieved
Α	264	264	A1	BL1-H	0.6	0.0	2.4	90	54.0	100	60.0
			A2	GS1-N	0.5	0.0	2.4	50	25.0	55	27.5
			A4	GS1-N	0.6	0.0	2.4	50	30.0	55	33.0
			A5	GS1-N	0.8	0.0	2.4	50	40.0	55	44.0
			A6	GS1-N	0.8	0.0	2.4	50	40.0	55	44.0
			A7	GS1-N	1.2	0.0	2.4	50	57.5	55	63.3
			A8	GS1-N	0.7	0.0	2.4	50	35.0	55	38.5
В	264	264	B1	GS1-N	1.9	0.0	2.4	70	133.0	60	114.0
			B2	GS1-N	1.7	0.0	2.4	70	119.0	60	102.0
			В3	GS1-N	2.2	0.0	2.4	70	154.0	60	132.0
	-	ı			Т	otals Ac	hieved:	W	687.5	E	658.3
Totals Required: W 357.5 E 264.0											


ACROS	SS										
Bracing	Line		Bracing	Elements	Provided			Earthquake			
Line	Min BUs	Min BUs	Brace	Brace	Brace	Brace	Brace	Rating	BUs	Rating	BUs
Label	W	E	No.	Type	Length	Angle	Height	BUs/m	Achieved	BUs/m	Achieved
М	129	100	M1		5.0	0.0	2.4		200.0		200.0
N	129	100	N2	GS1-N	3.9	0.0	2.4	70	273.0	60	234.0
0	129	100	01	GS1-N	4.0	0.0	2.4	70	280.0	60	240.0
P	129	100	P1	GS1-N	3.9	0.0	2.4	70	273.0	60	234.0
			P2	GS1-N	0.7	0.0	2.4	50	35.0	55	38.5
Q	129	100	Q2	GS2-N	3.9	0.0	2.4	95	370.5	85	331.5
R	129	100	R1	BL1-H	0.6	0.0	2.4	90	54.0	100	60.0
			R2	BL1-H	1.5	0.0	2.4	125	187.5	105	157.5
		•			Т	otals Ac	hieved:	W	1,673.0	E	1,495.5
					Т	otals Re	quired:	W	1,258.4	Е	264.0


GS1-N = Any 10mm or 13mm GIB Standard plasterboard to one side only as per GIB EzyBrace system specification


BL1-H = 10mm or 13mm GIB Braceline to one side only

1. Ceiling Diaphragm - Install 13mm Gib ceiling diaphragm as per Gib installation

2. Bracing calculations above are for bedroom wing only. Refer to structural engineering calcs for lounge wing bracing calculations

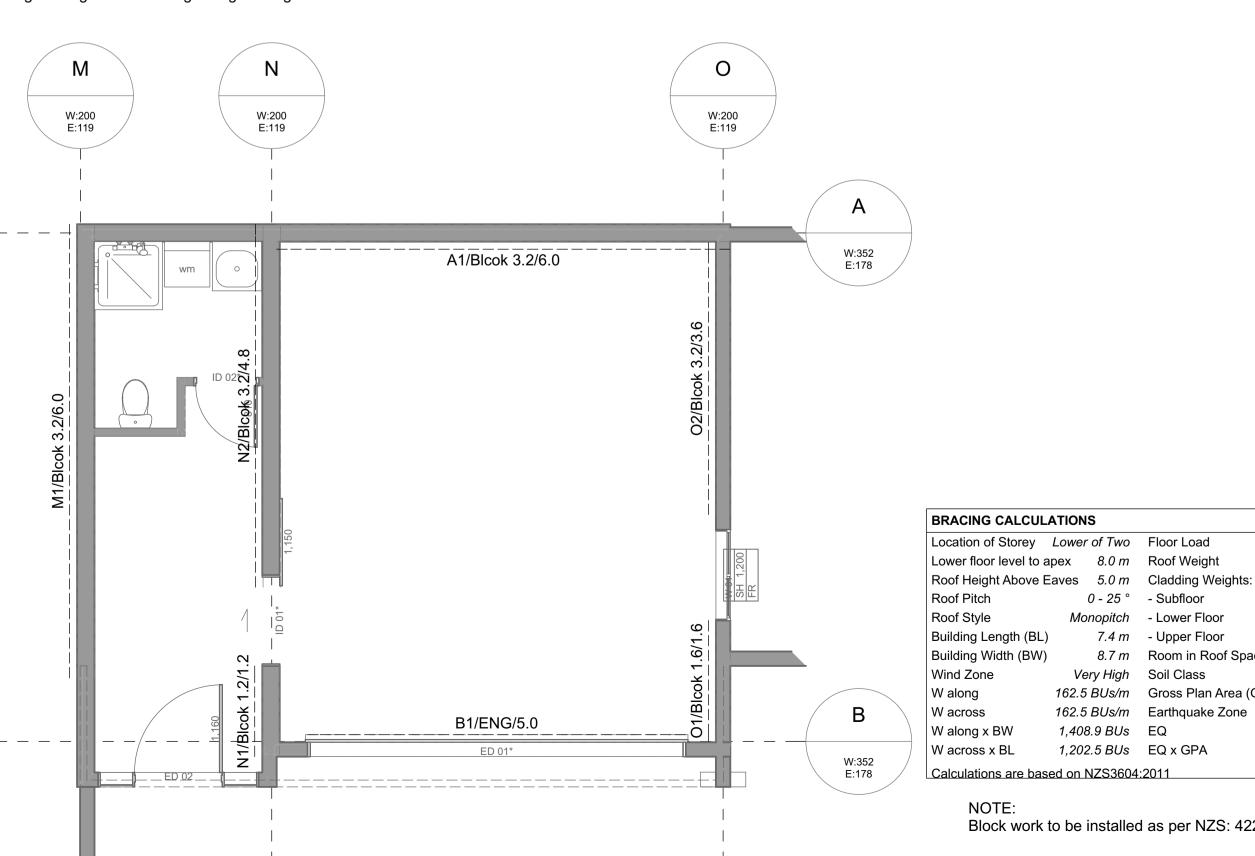

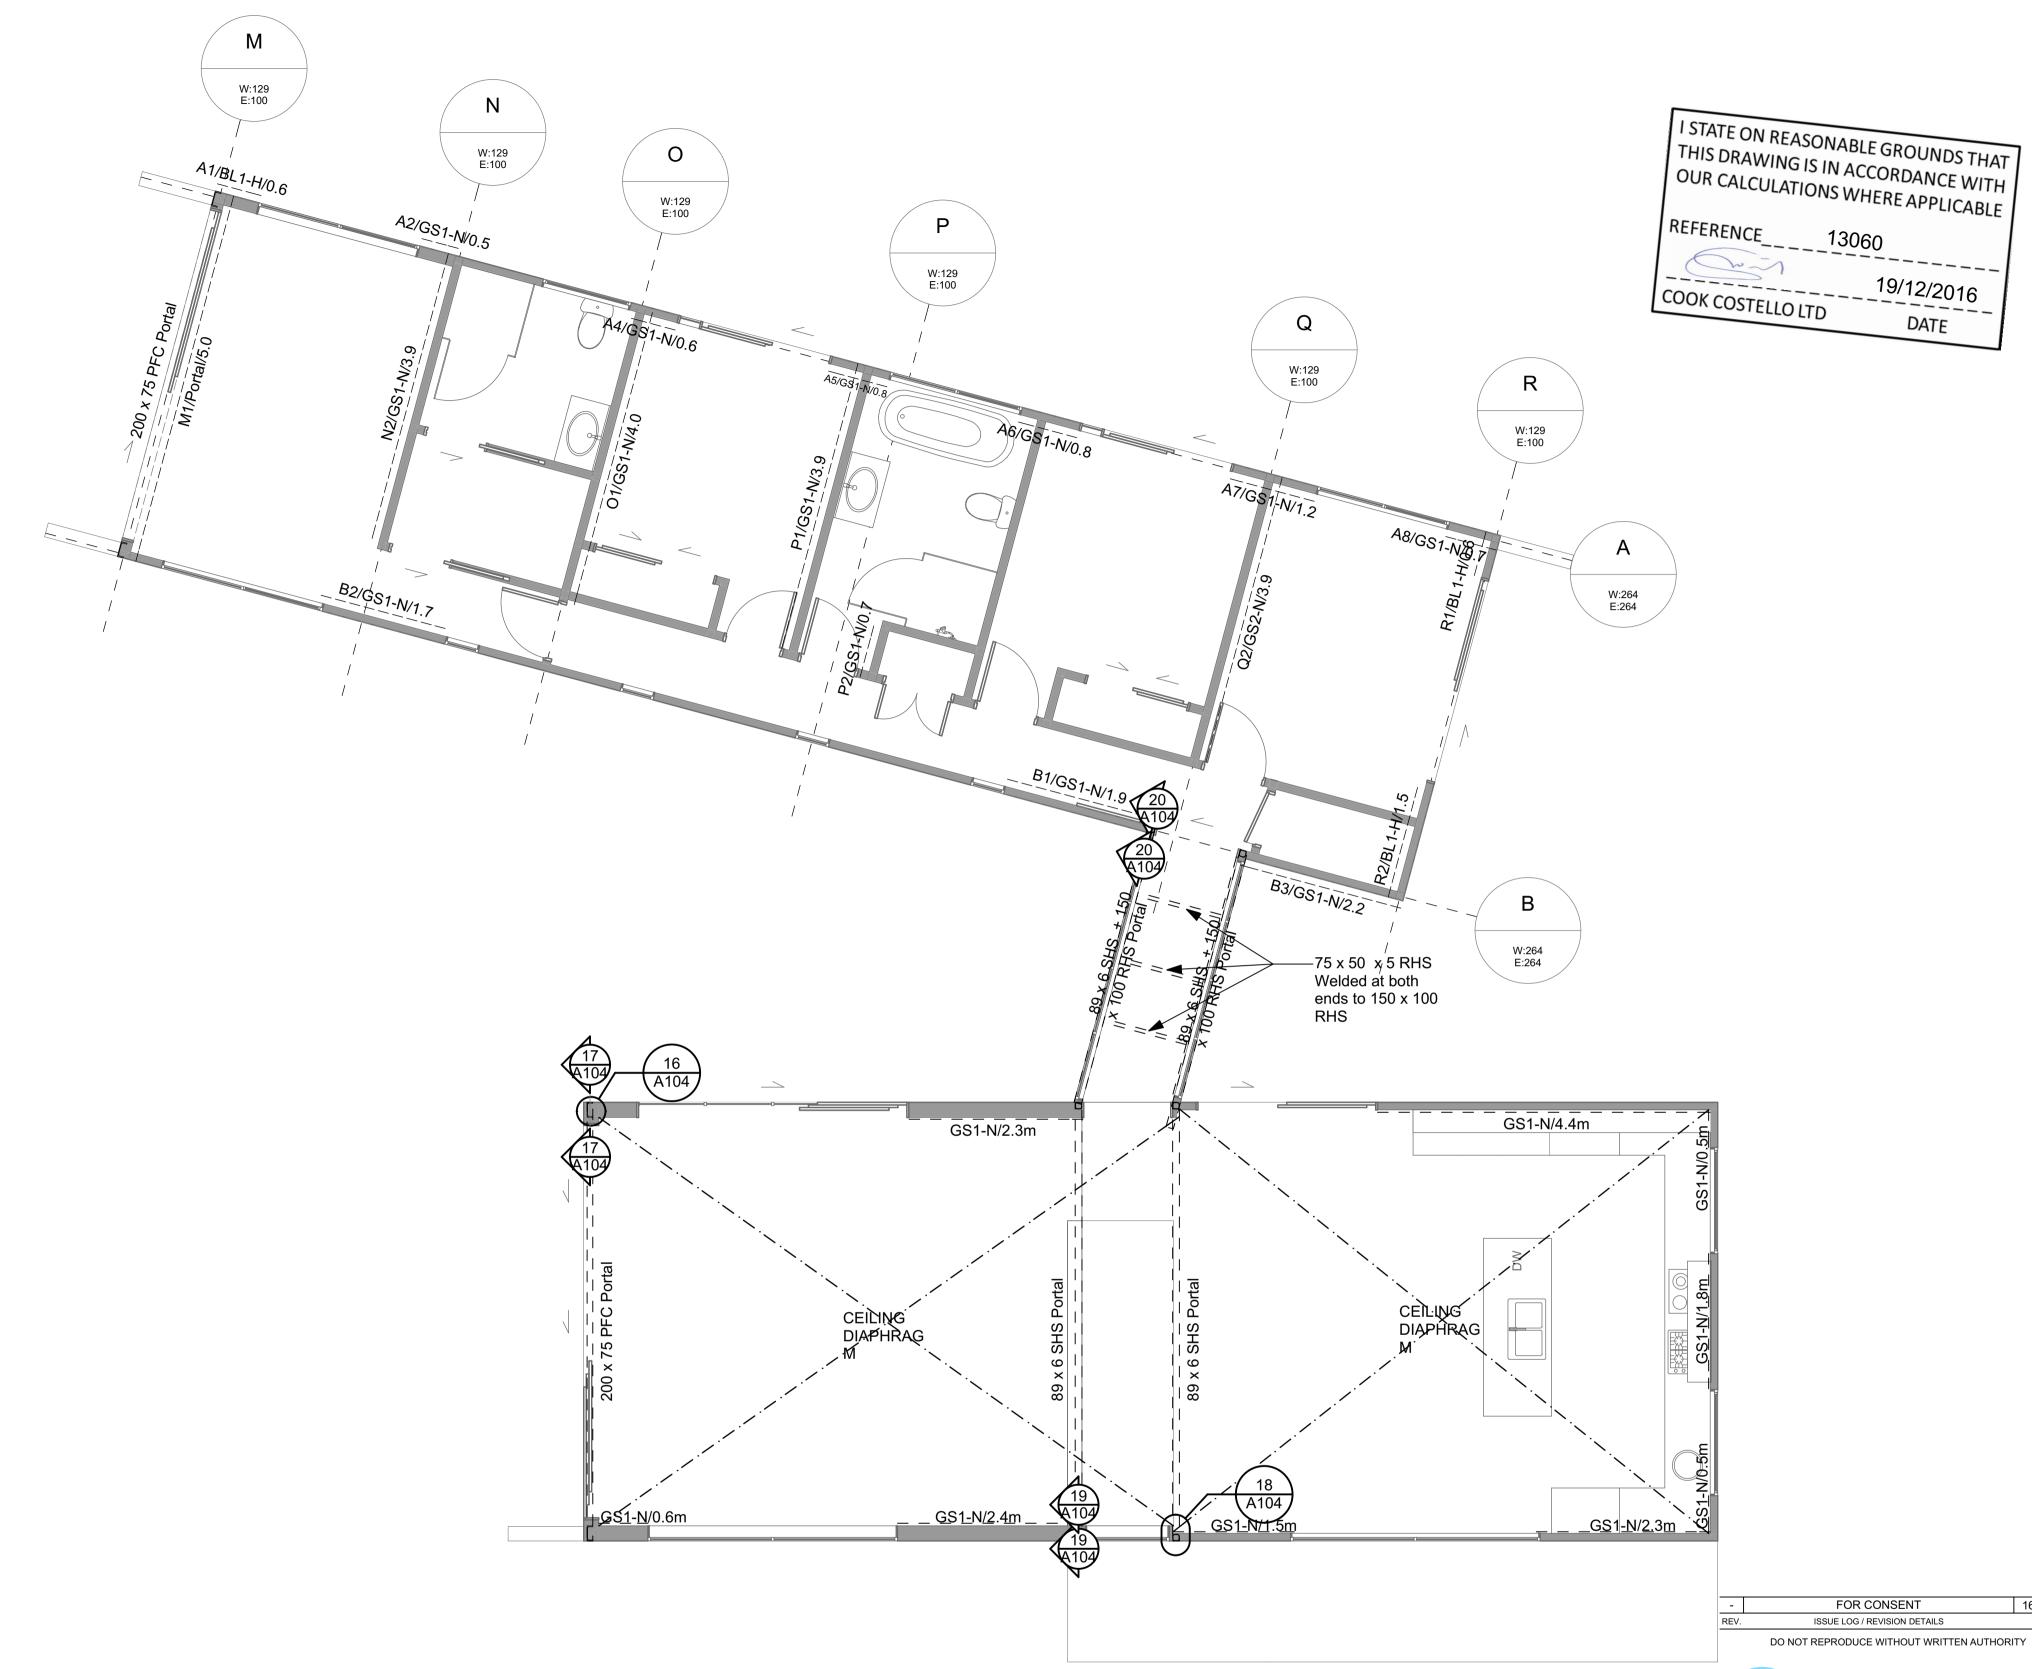

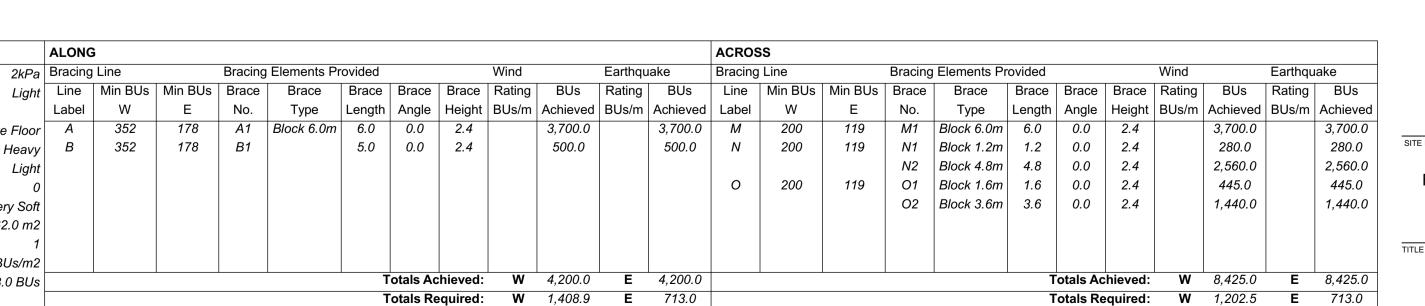

Block work to be installed as per NZS: 4229

0 - 25 ° - Subfloor

Monopitch - Lower Floor

Very High Soil Class

1,408.9 BUs EQ

1,202.5 BUs EQ x GPA

7.4 m - Upper Floor

162.5 BUs/m Earthquake Zone

8.7 m Room in Roof Space

162.5 BUs/m Gross Plan Area (GPA) 62.0 m2

GROUND FLOOR BRACING PLAN 1:50

178 B1

Bracing Elements Provided

Type

178 A1 Block 6.0m 6.0 0.0 2.4

5.0 0.0 2.4

ALONG

352

2kPa Bracing Line

11.5 BUs/m2

713.0 BUs





FOR CONSENT

ISSUE LOG / REVISION DETAILS

16-12-16


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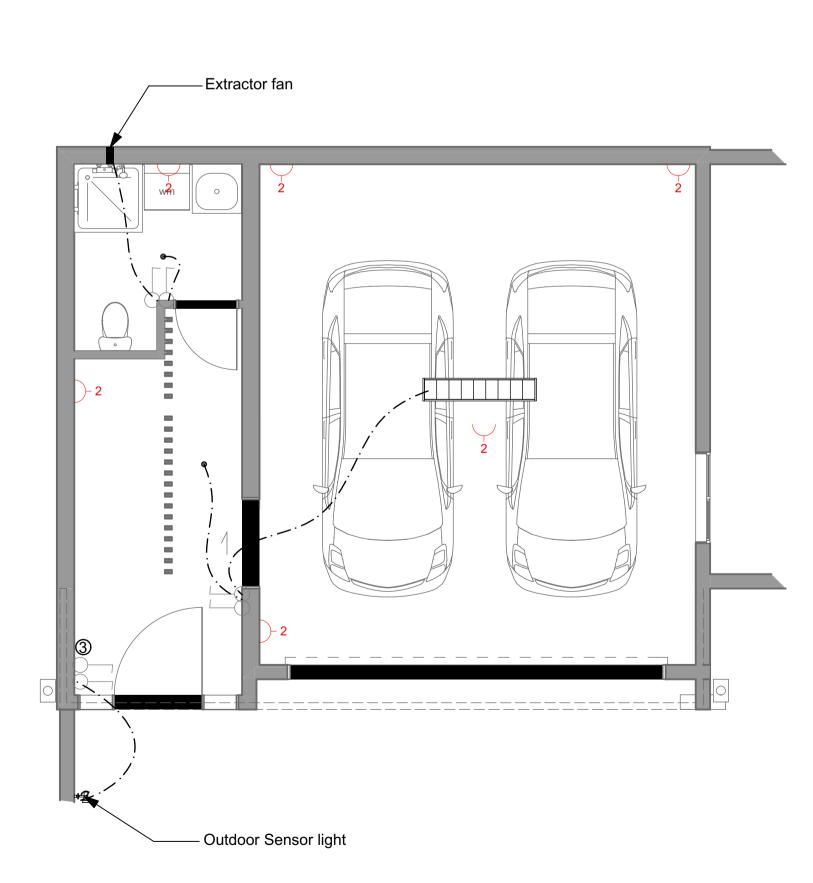
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URQUHARTS HOUSE FOR JAMES CROAD & SHONA POULSON 43 BASIL ROAD, WHANGAREI HEADS, WHANGAREI


BARCING PLANS

DATE	CCL REF. No.	DWG NAME REV.
16-12-16	13060	L116-
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FOR CONSENT	SCALE 1:50@ A1	SHEET No. 16 OF 25
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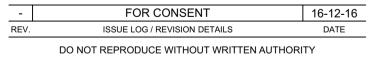






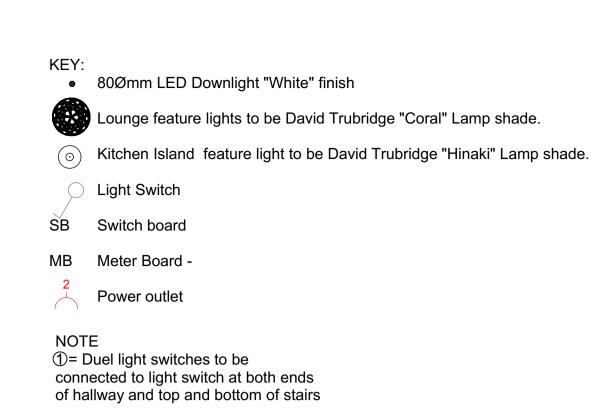

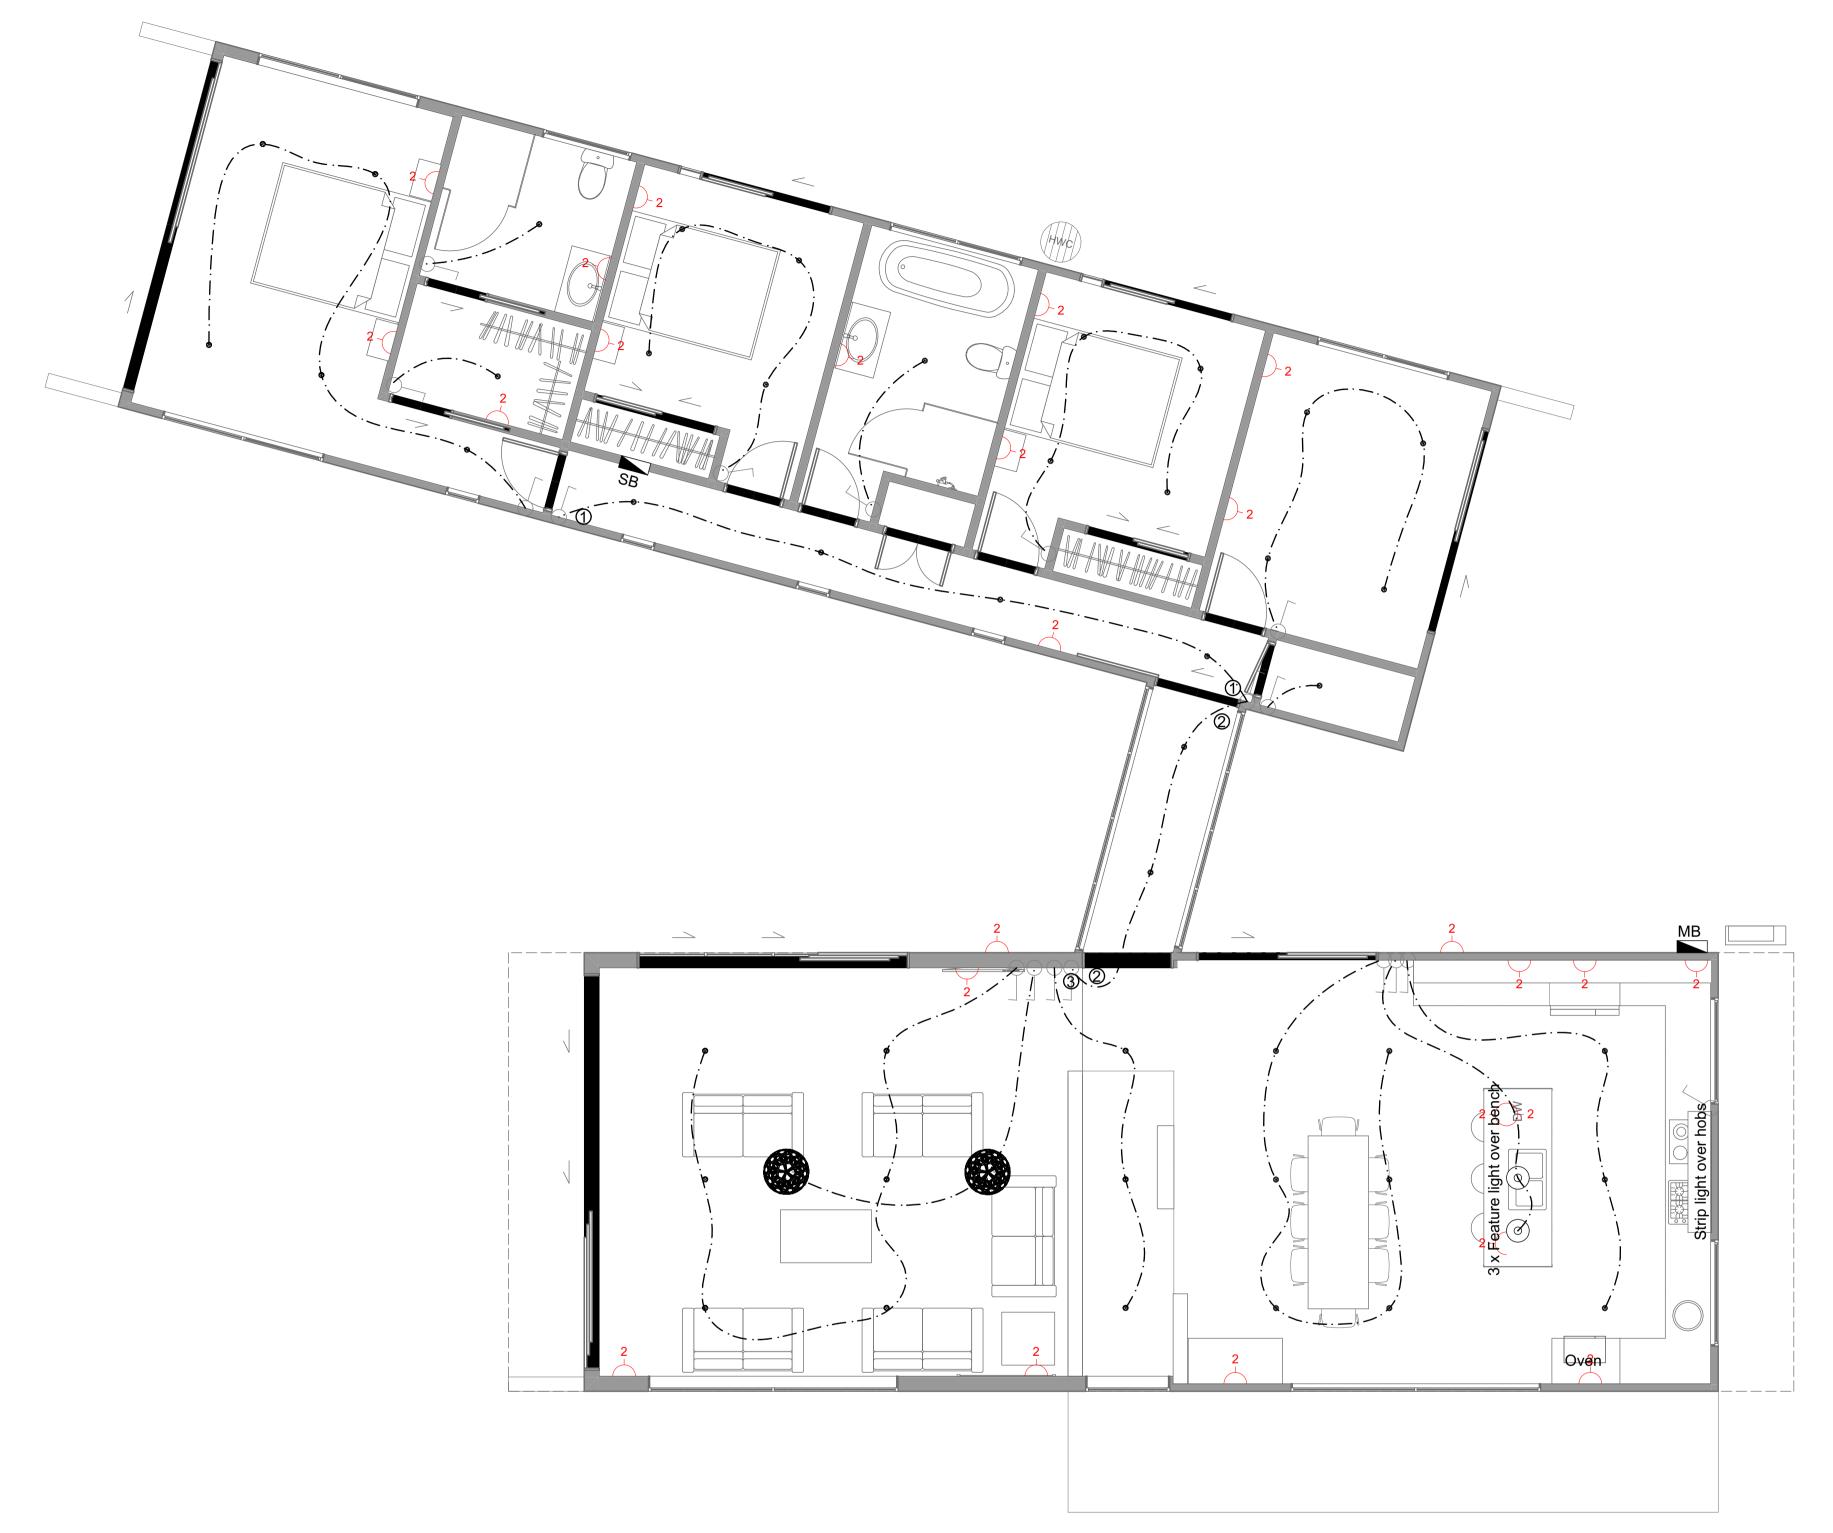FIRST FLOOR ELECTRICAL PLAN 1:50






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SITE DETAILS URQUHARTS HOUSE FOR JAMES CROAD & SHONA POULSON 43 BASIL ROAD, WHANGAREI HEADS, WHANGAREI

ELECTRICAL PLANS

DATE	CCL REF. No.	DWG NAME REV.
16-12-16	13060	L117-
STATUS		
FOR CONSENT	SCALE 1:50@ A1	SHEET No. 17 OF 25
DATE PLOTTED: 19/12/201 \CAD\161219 For Consent J		- 13499\13060 - 43 Basil R




NOTE:

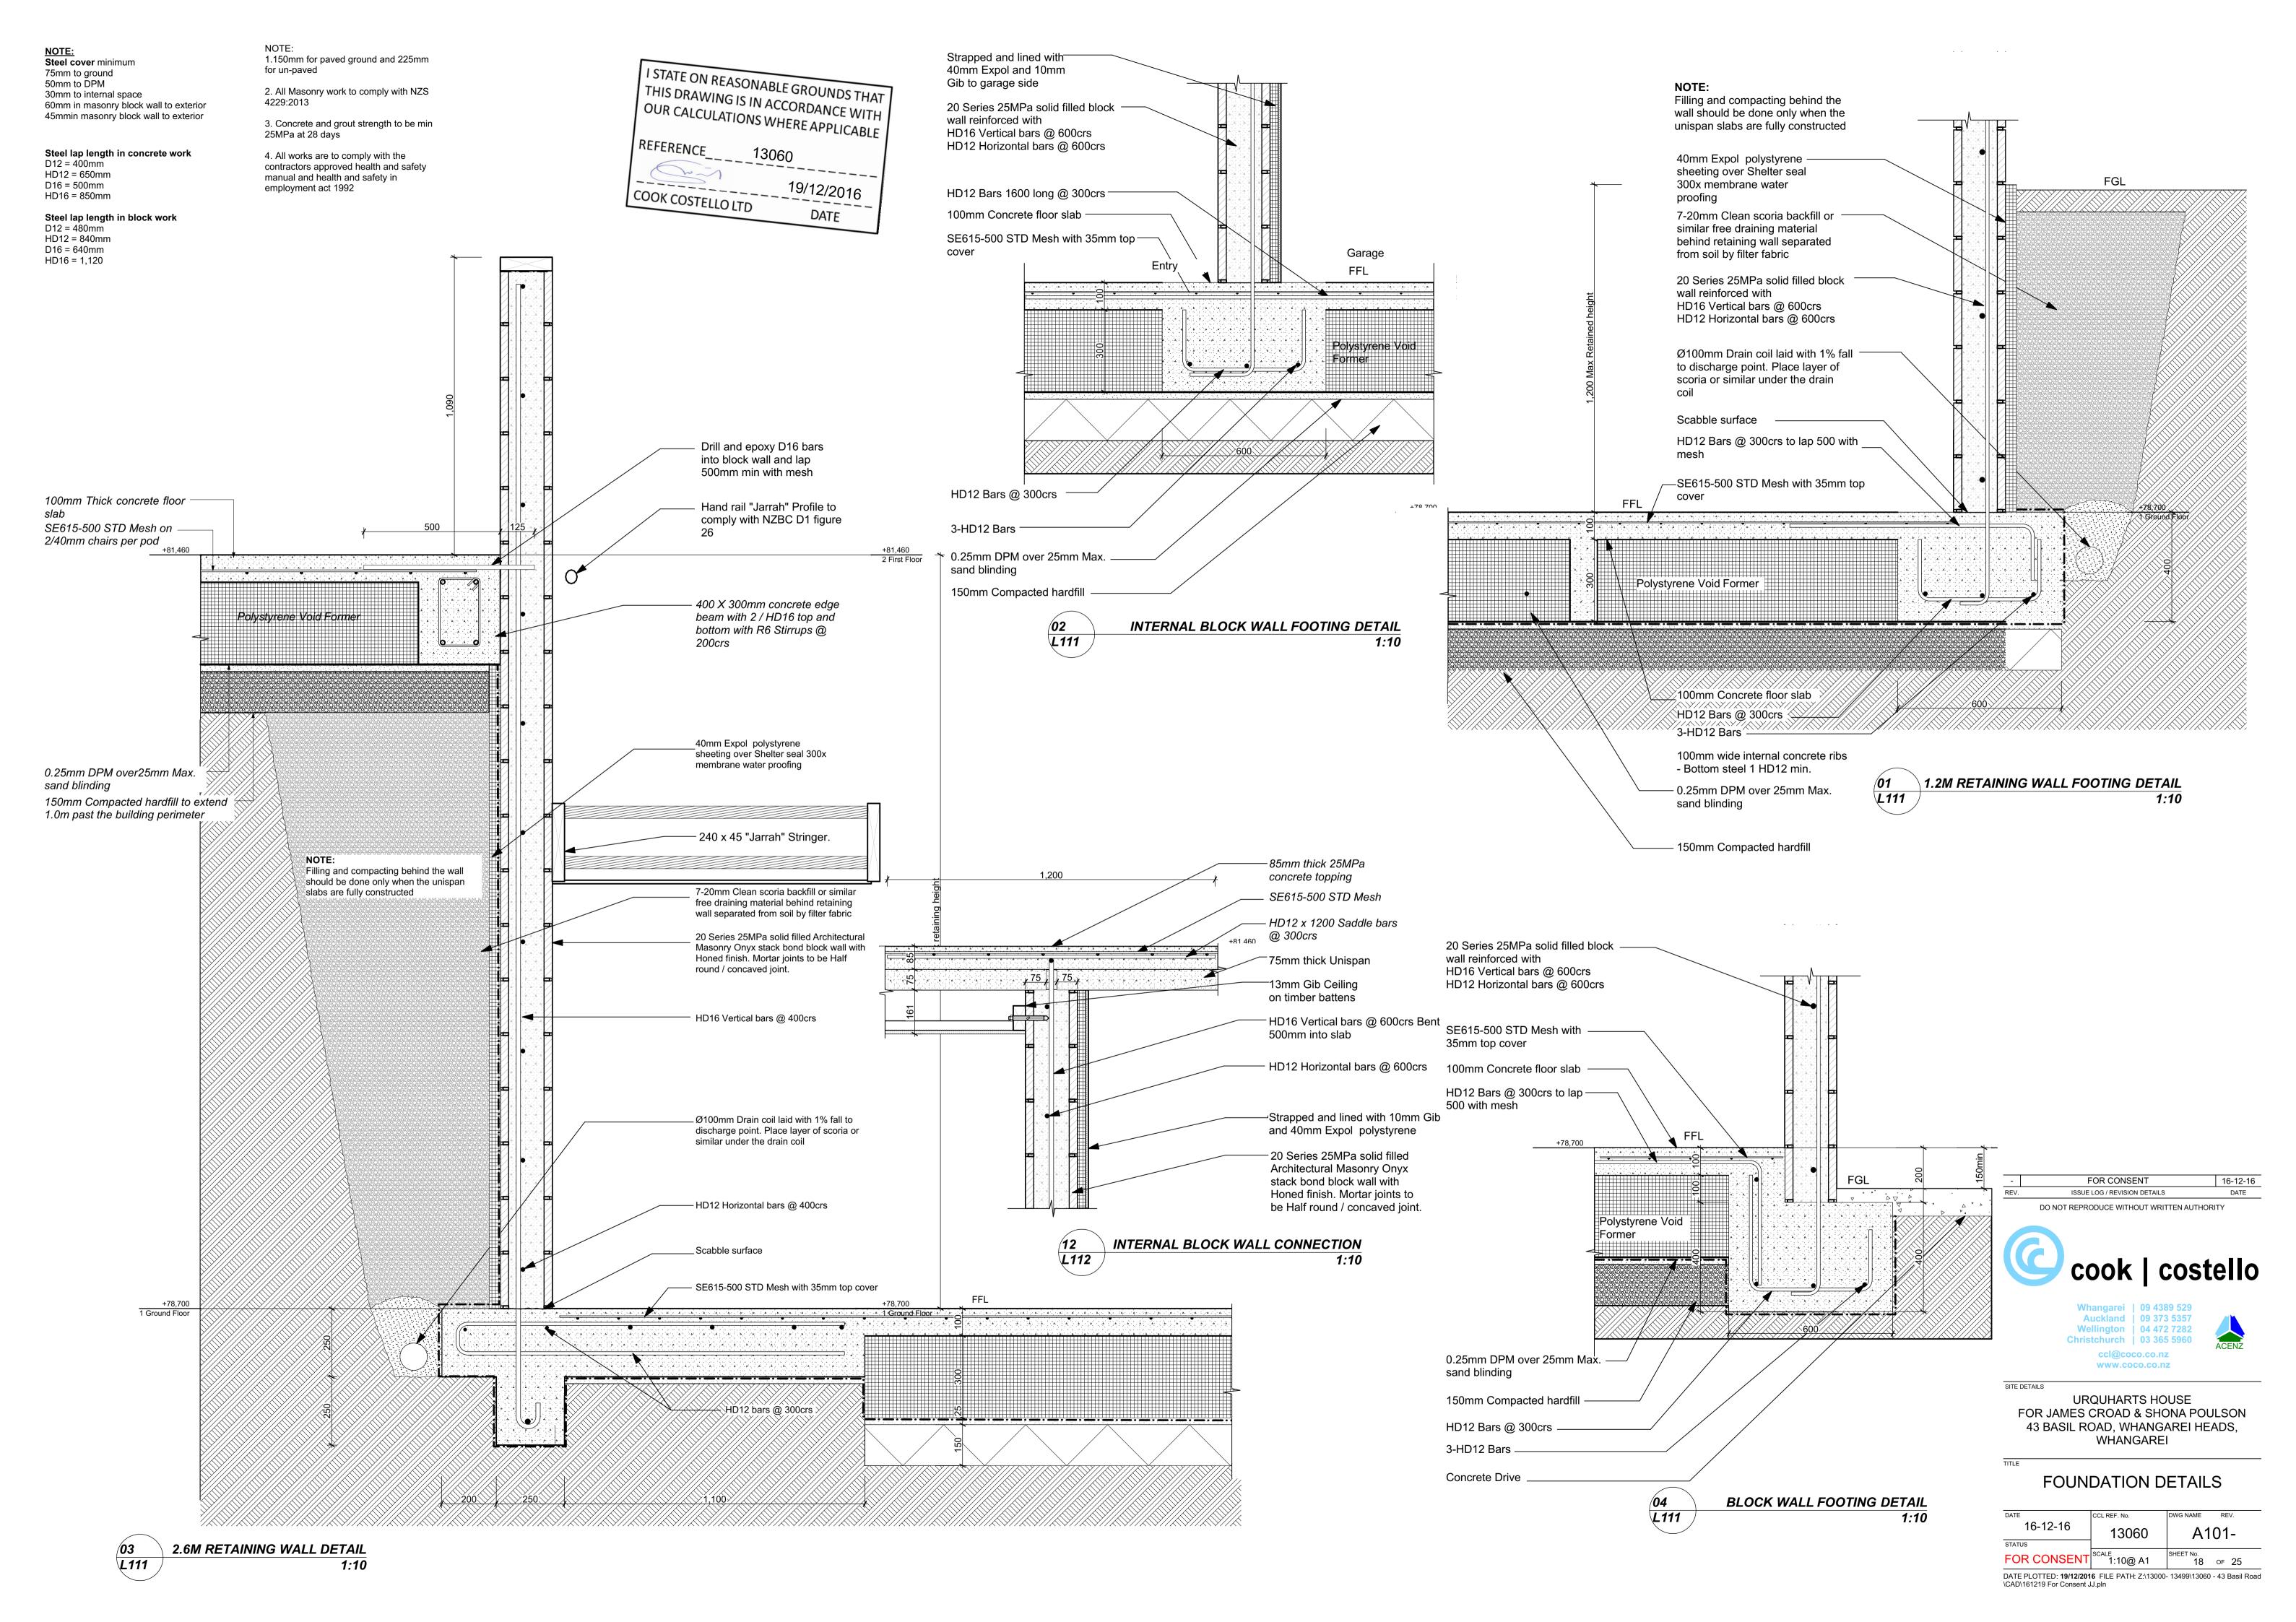- 1) Plumbing/services are to be conveyed underground. services are to be taken through polystyrene pods as much as possible. If this is unavoidable, it may be taken through ribs/thickenings, provided the details (or similar in principle) on this sheet are used.
- 2) All service trench backfill shall be properly compacted
- 3) Use recommended spacers as per details.
- 4) DPM shall be in accordance with NZS3604. All penetrations through the DPM shall be sealed.
- 5) A layer of sand blinding or granular fines (PAP7) shall be placed, screeded and compacted over the building platform. Max thickness

MAXIMUM DIAME	Vertical services	Horizontal service			
300mm edge beam	50mm in a duct 50mm larger diameter than pipe	50mm in a duct 50mm larger diameter than pipe			
600mm localised wide edge beam.	100mm in a duct 50mm larger diameter than pipe	50mm in a duct 50mm larger diameter than pipe			
300mm wide internal load bearing rib.	50mm in a duct 50mm larger diameter than pipe	50mm in a duct 50mm larger diameter than pipe			
100mm wide internal rib.	NIL	50mm in a duct 50mm larger diameter than pipe			
Slab	110mm in a duct 50mm larger diameter than pipe, or for a large service 450mm square	NIL			

NOTES:

- 1) 100mm thick slab reinforced with SE615-STD 500E ductile reinforcing mesh with 30mm top cover. Mesh to be lapped 225mm minimum and tied at all laps.
- 2) All Rib Raft concrete to be min 25MPa 28 day strength. 3) Foundation reinforcing steel to have 50mm min cover to ground where protected by DPC and 30mm min cover to
- internal space. 4) Waffle raft foundation slab to be in accordance with the requirements of firth rib raft manual except for specific design
- portions. 5) All services are to be coordinated with pod layout prior to construction to ensure service penetrations through Rib Raft are in accordance with RIBRAFT technical manual section 6.3 services detailing.
- 6) Garage designed for residential use with vehicle limited to 2500kg gross
- 7) Construction joints required along party wall using 20mm deep saw cut and every second bar of the mesh cut.
- 8) All works are to comply with the contractors approved health and safety manual and health and safety in employment act
- 9) If shower base is to be rebated into concrete slab use Firth Ribraft shower rebate detail 4-S3

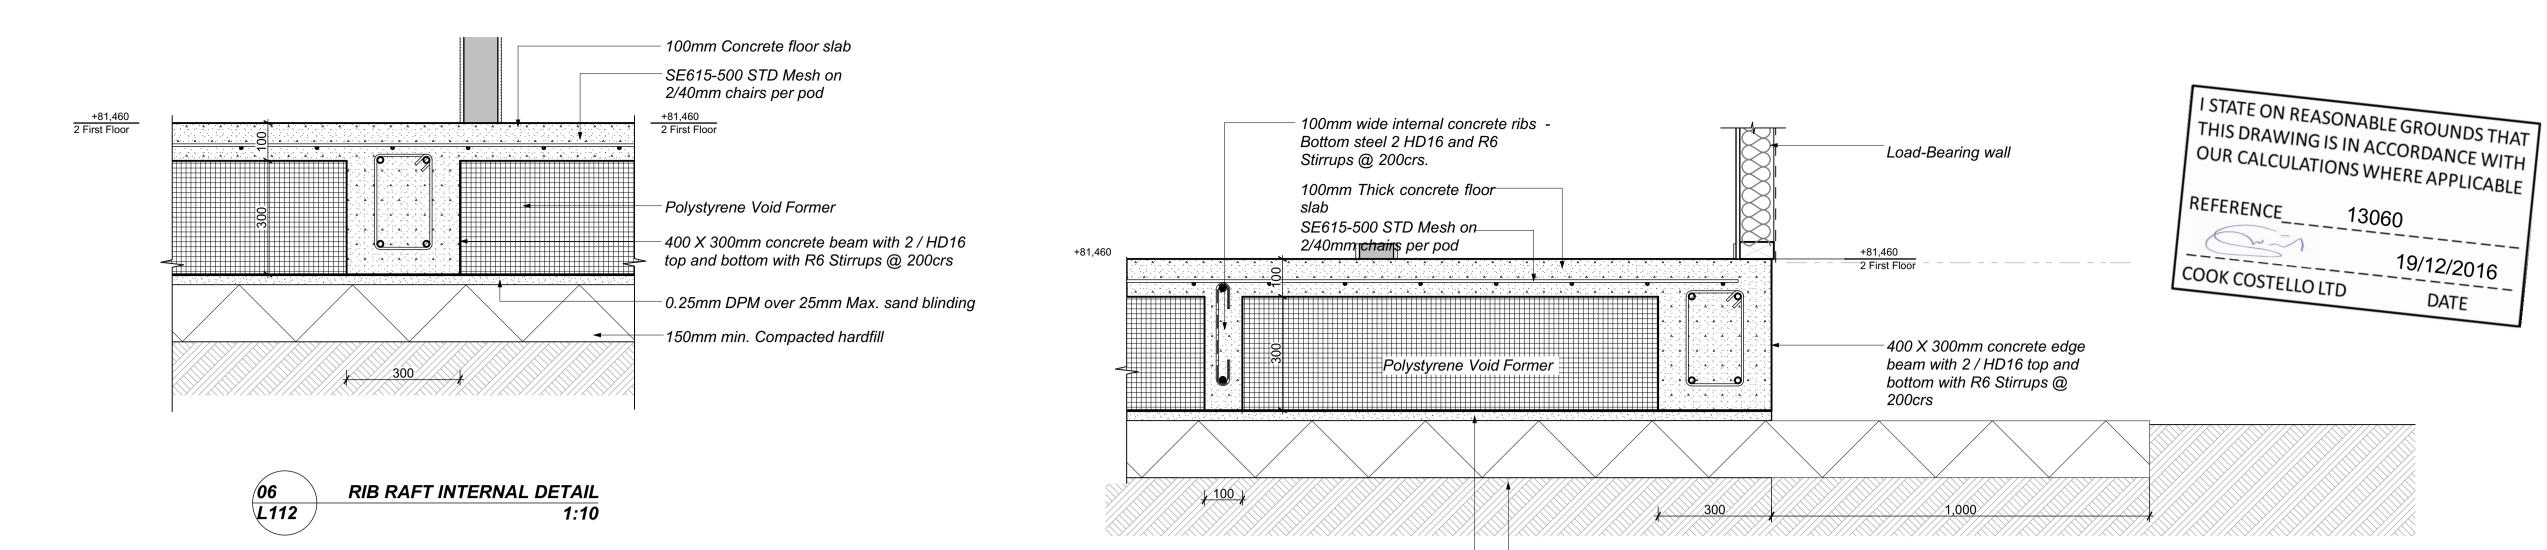



0.25mm DPM over25mm Max.

1.0m past the building perimeter

150mm Compacted hardfill to extend —

sand blinding

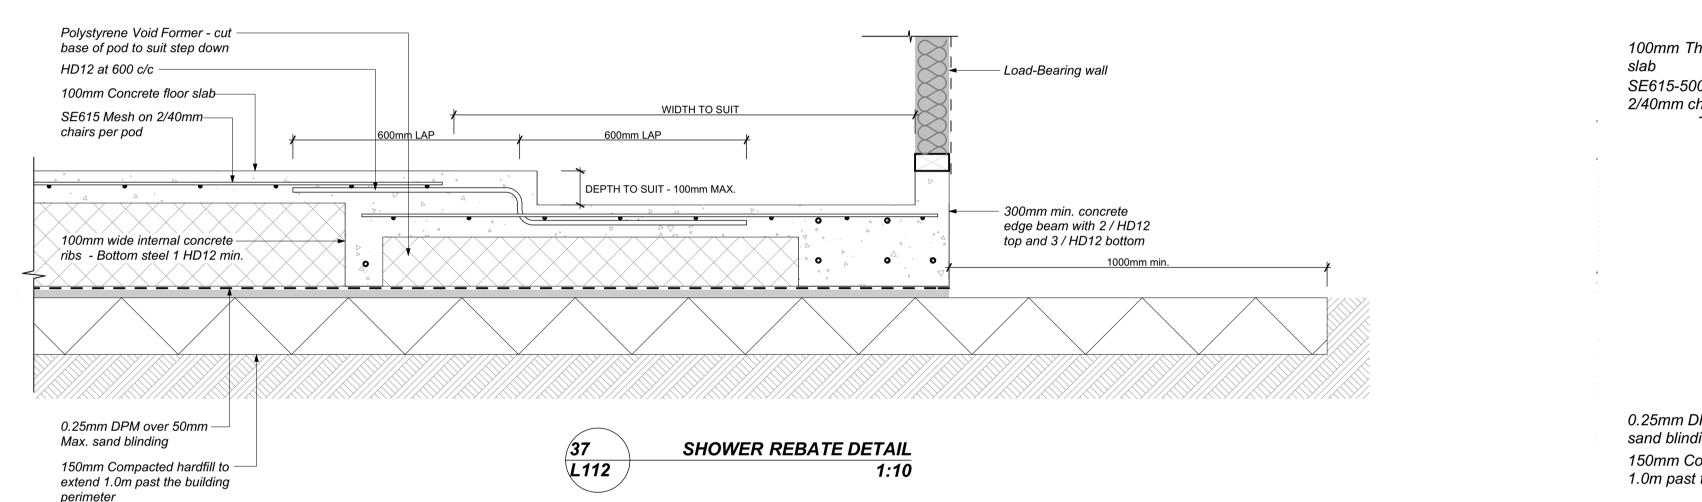

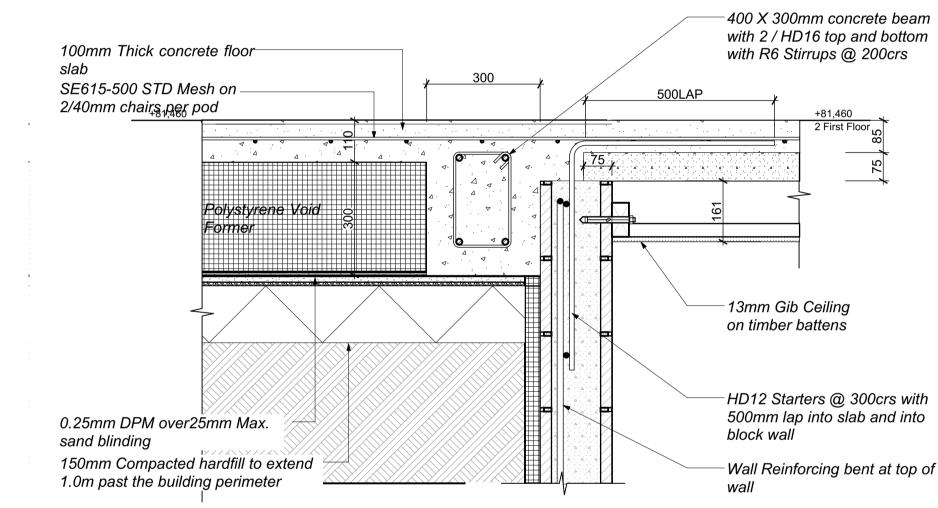

RIB RAFT FOOTING DETAIL

UNI-SPAN TO FOTTING DETAIL

L112

____13060

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ISSUE LOG / REVISION DETAILS

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URQUHARTS HOUSE

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RIB RAFT DETAILS

13060


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19 of 25


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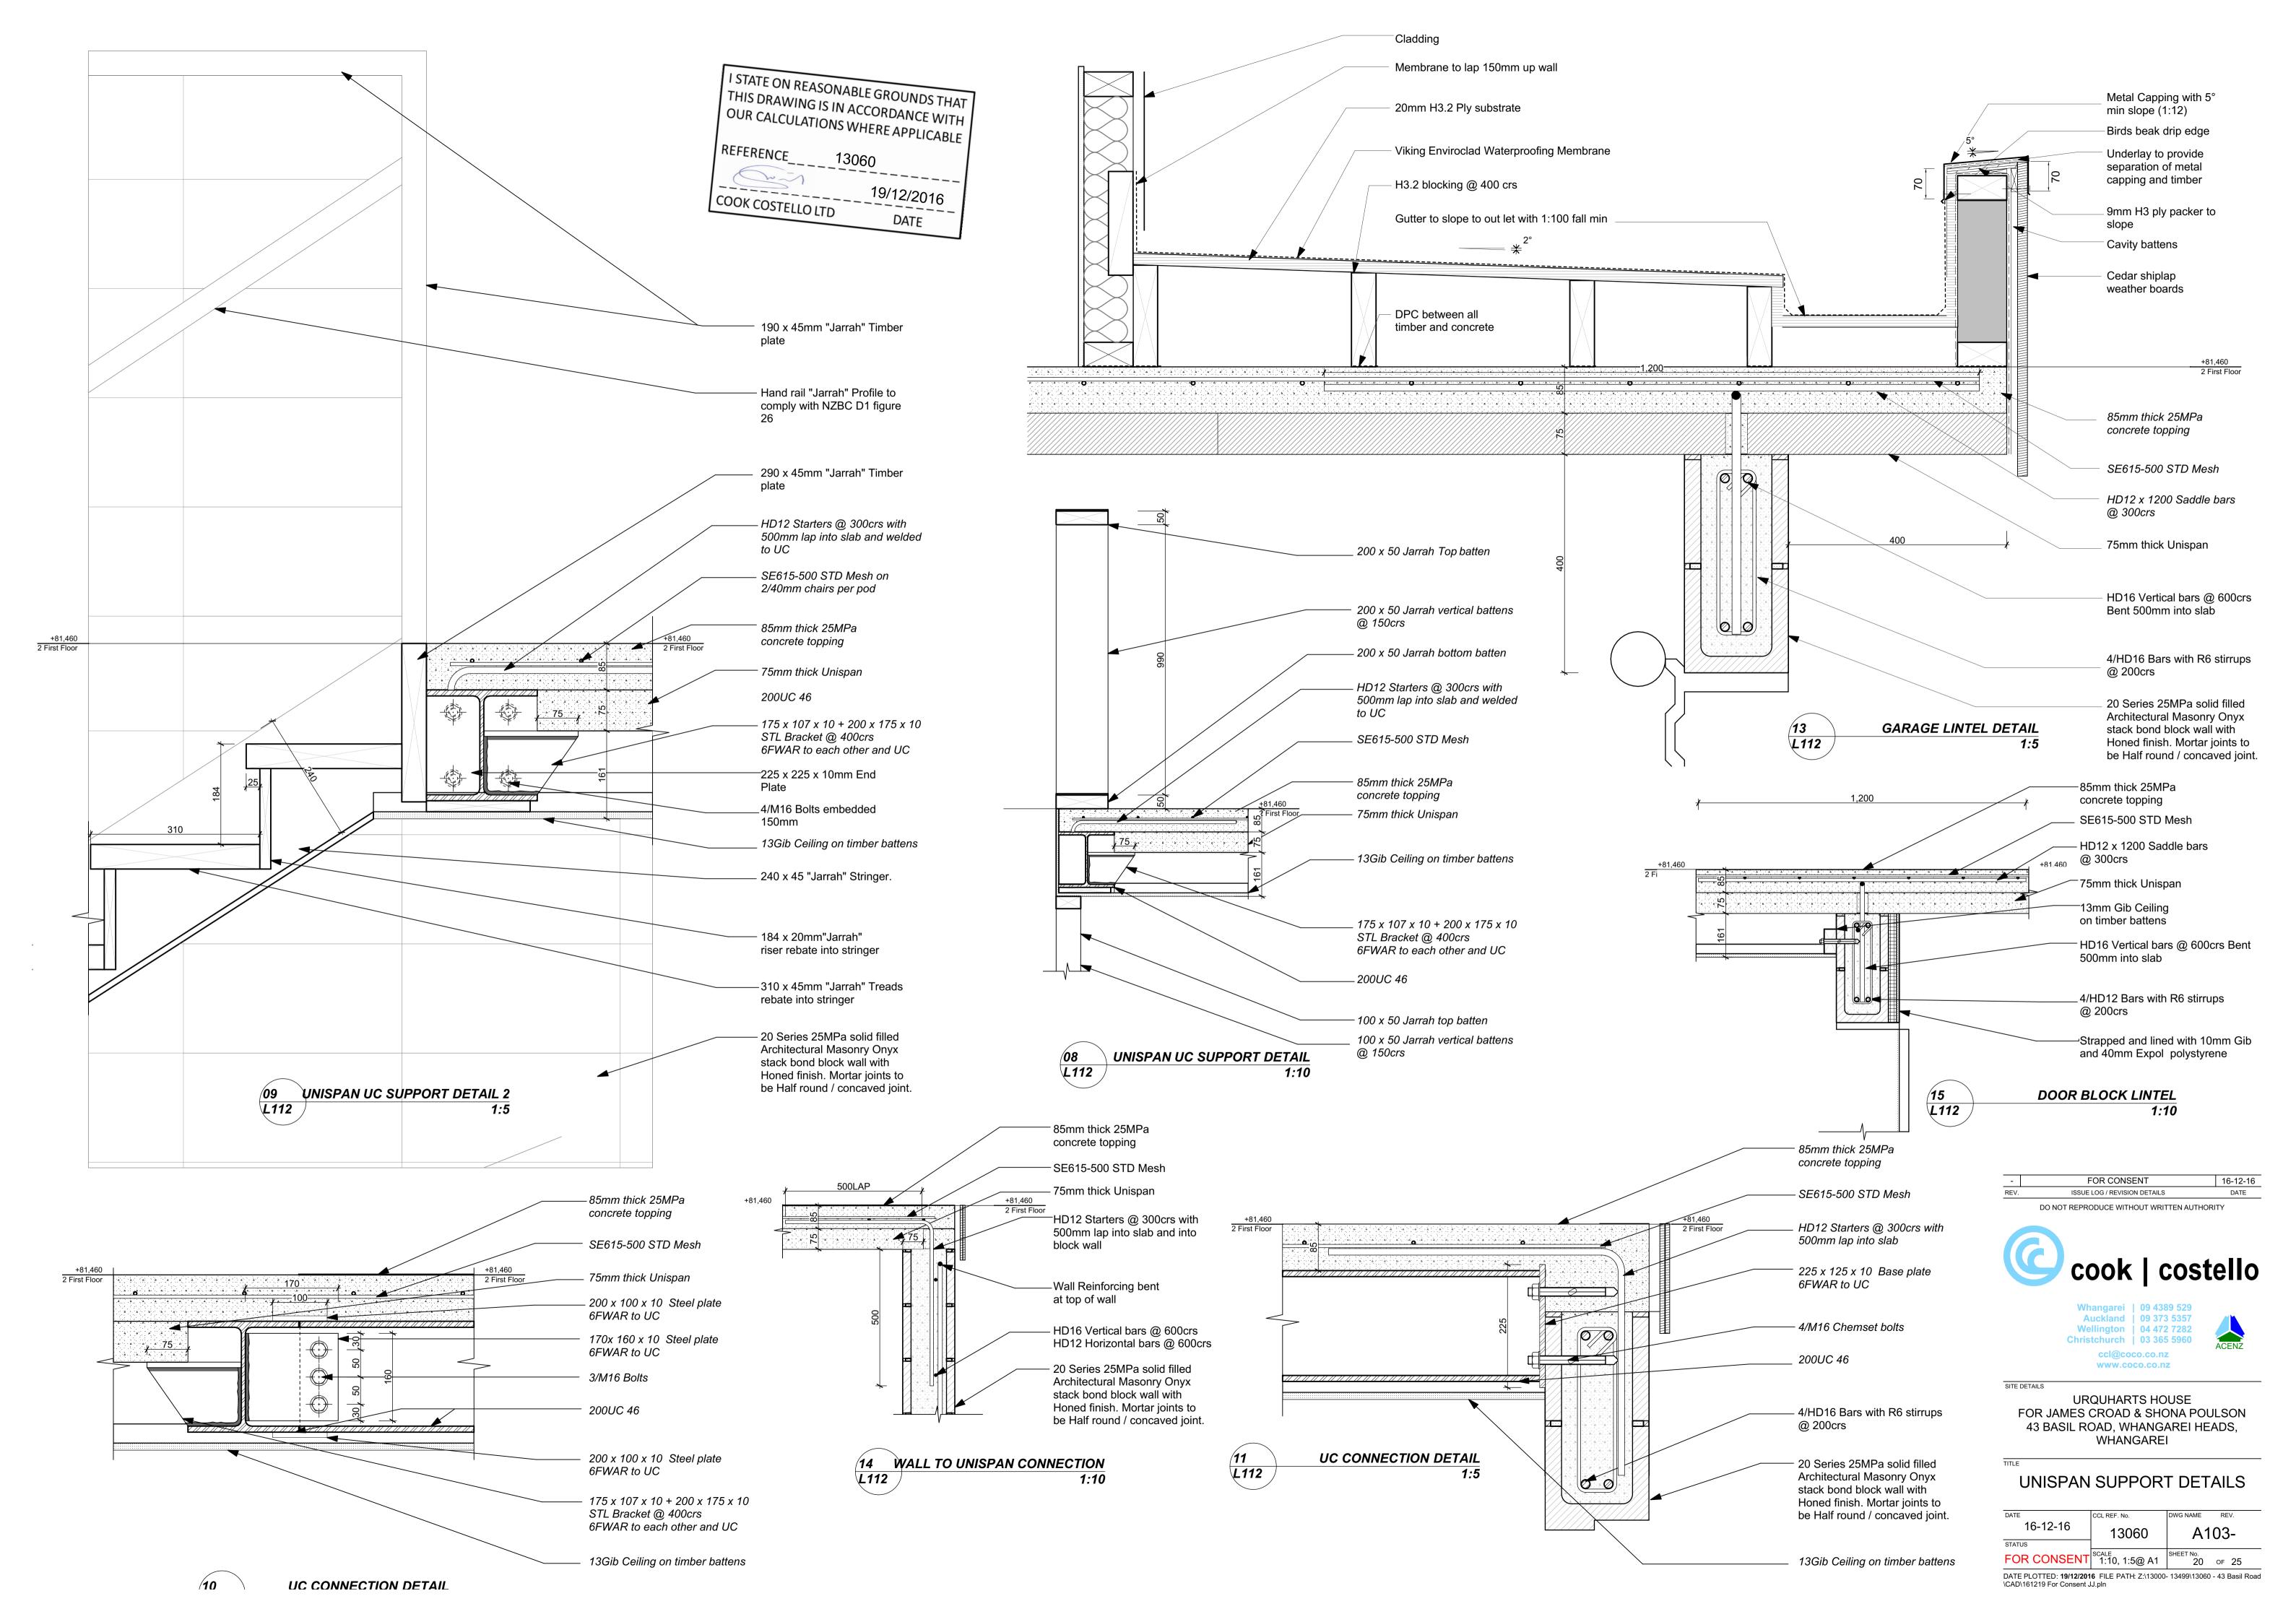
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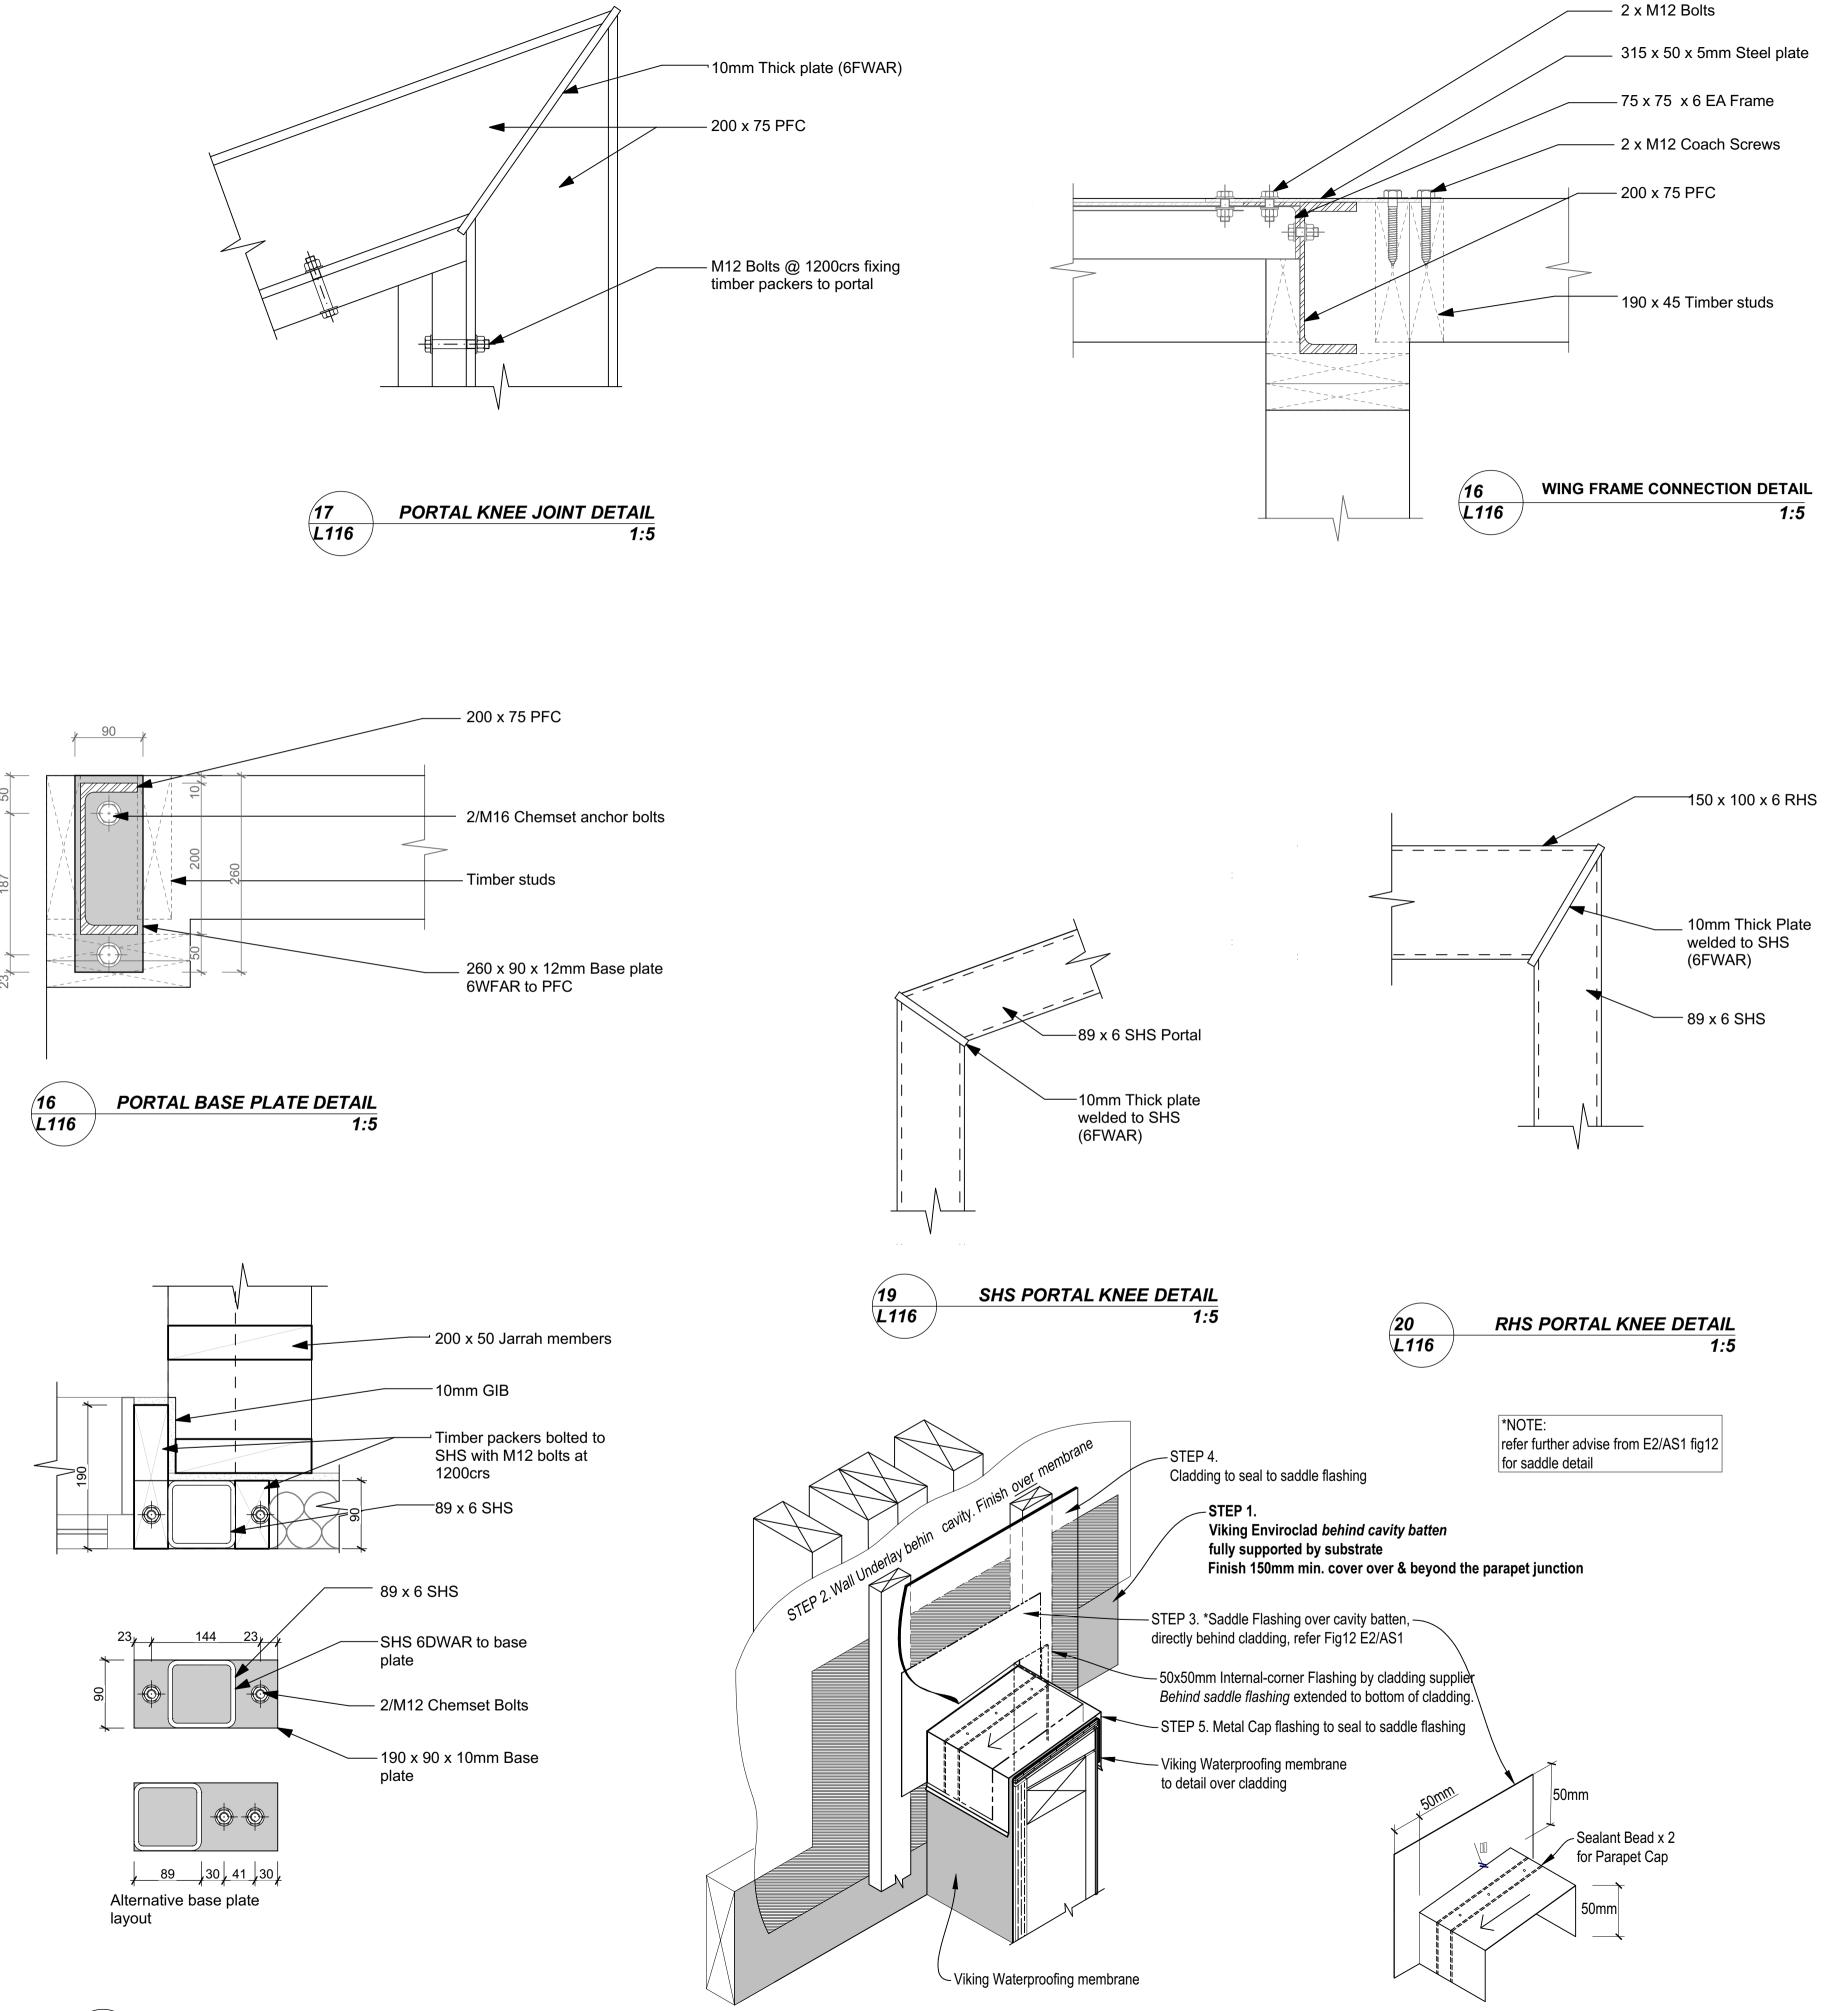
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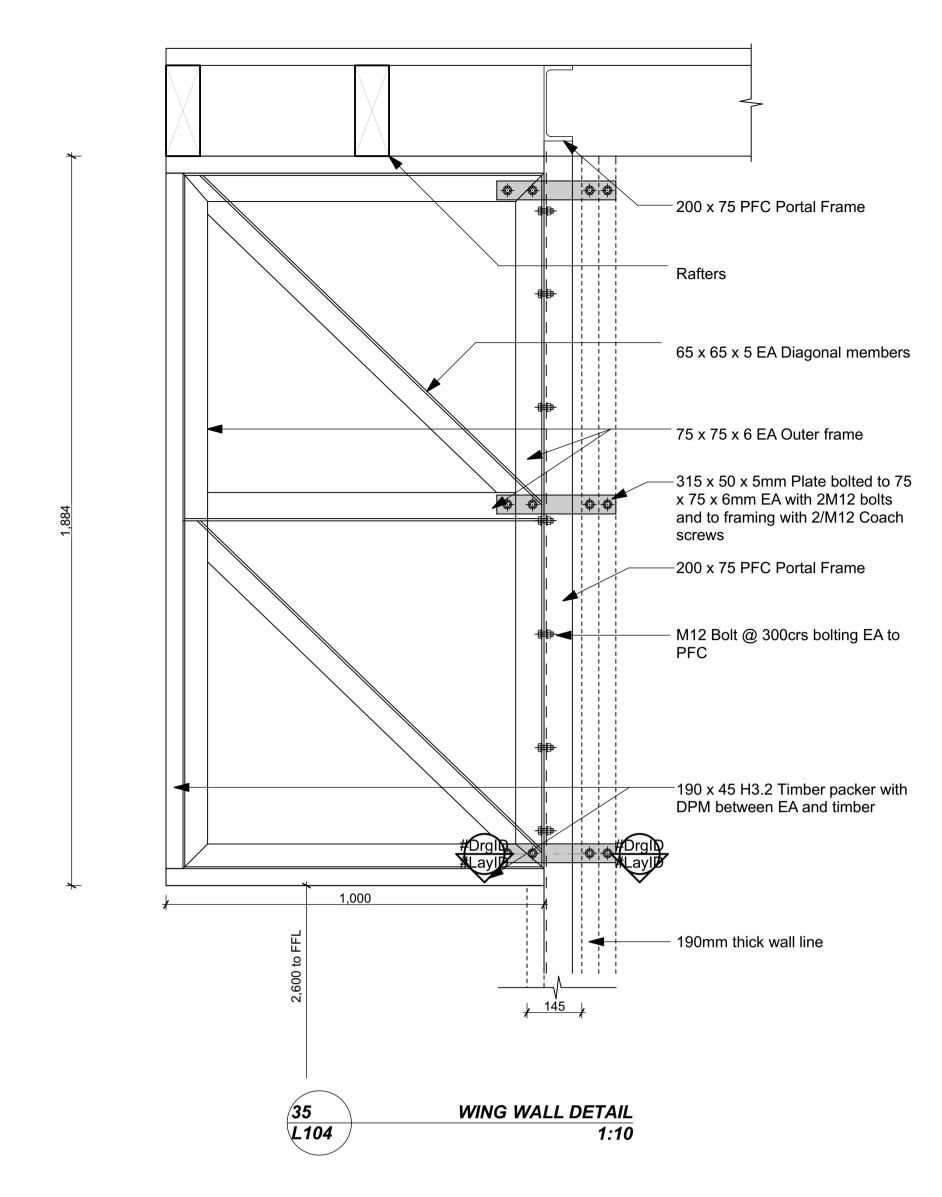










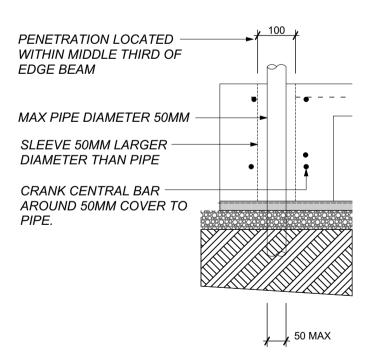

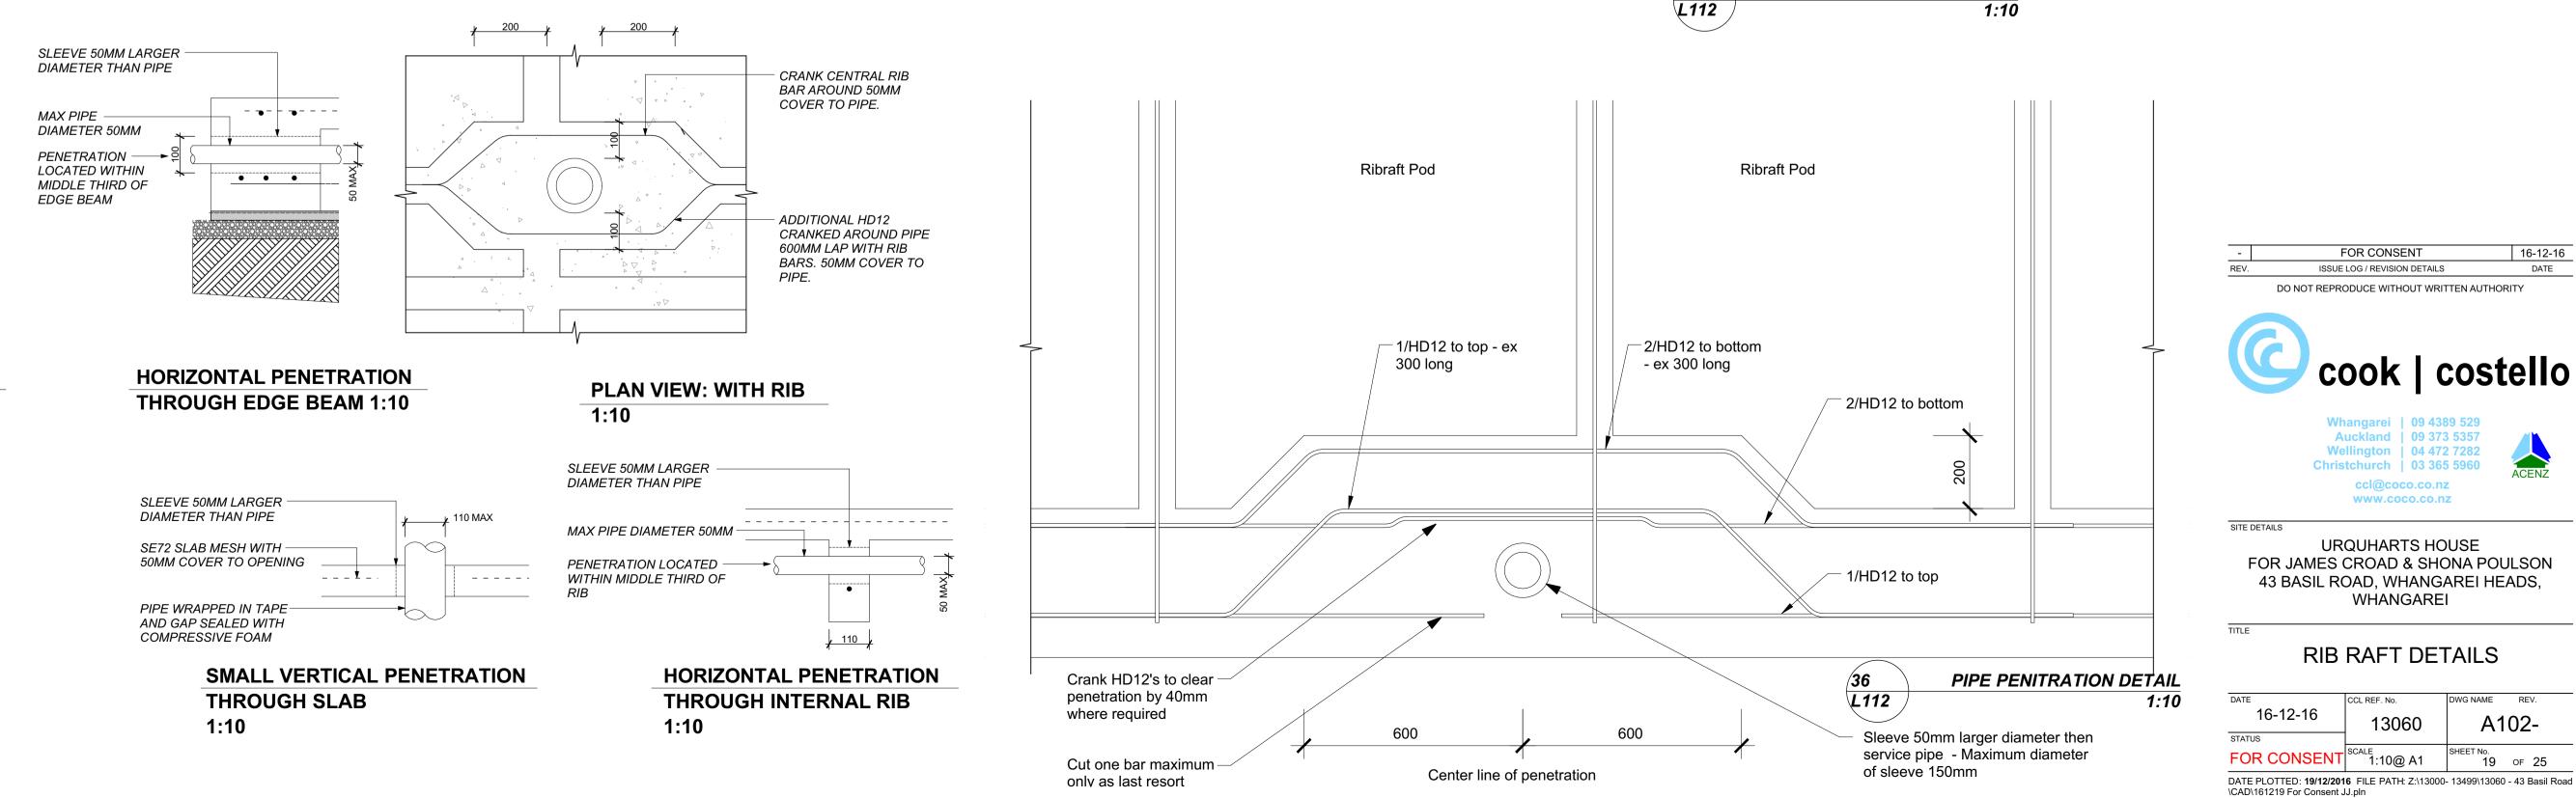

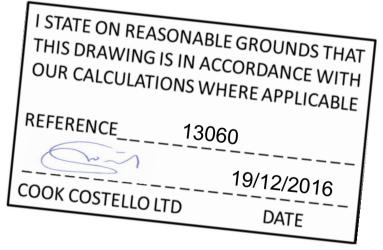

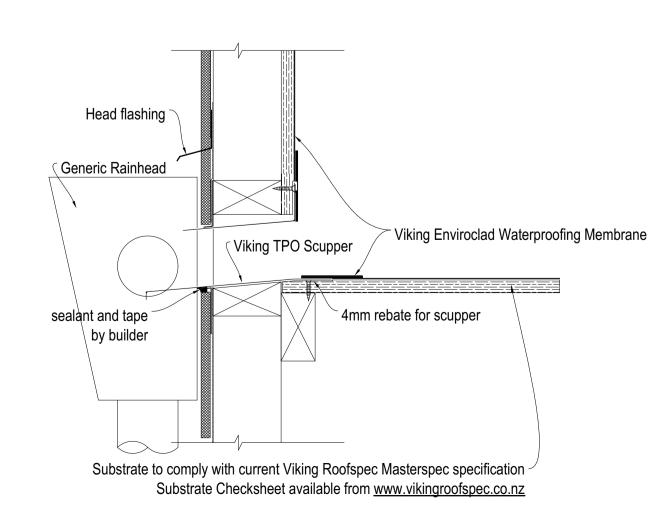




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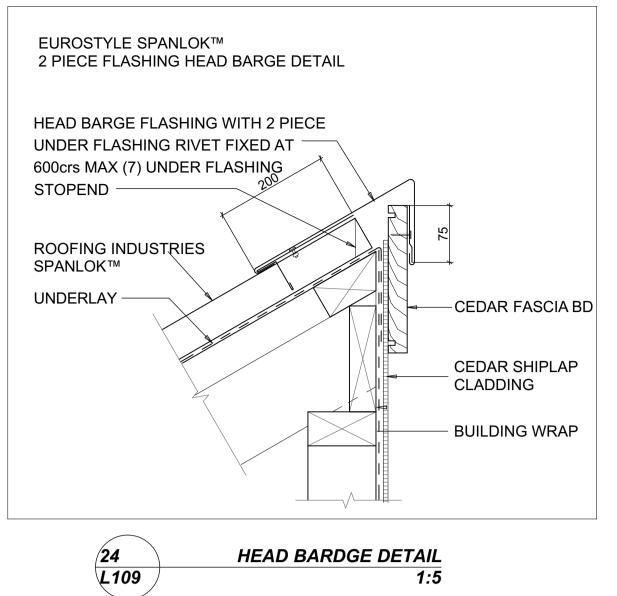
FOR JAMES CROAD & SHONA POULSON


43 BASIL ROAD, WHANGAREI HEADS,


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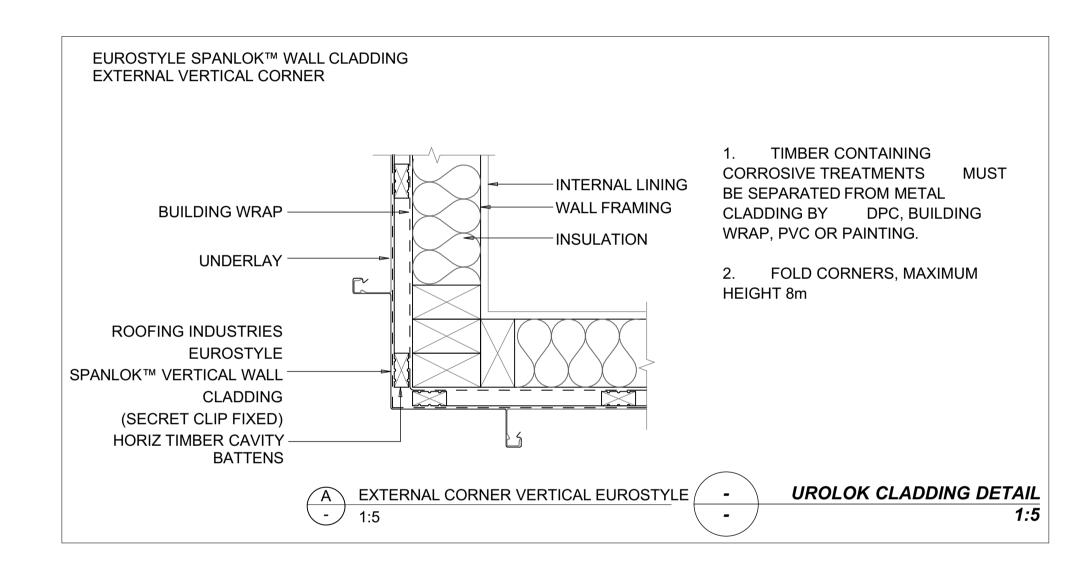





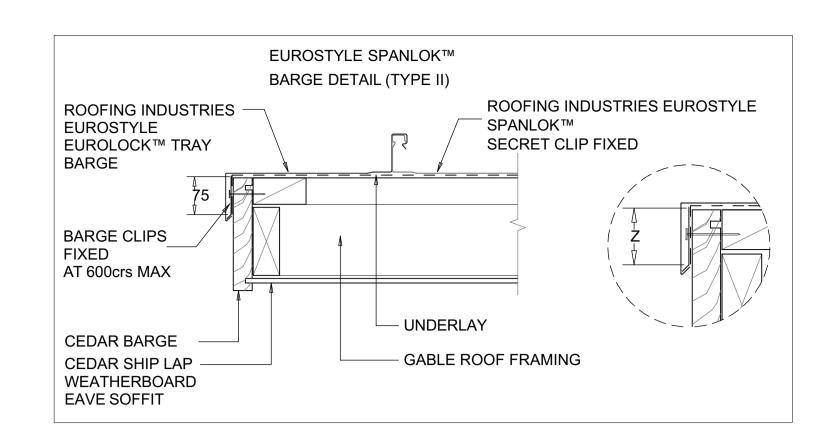



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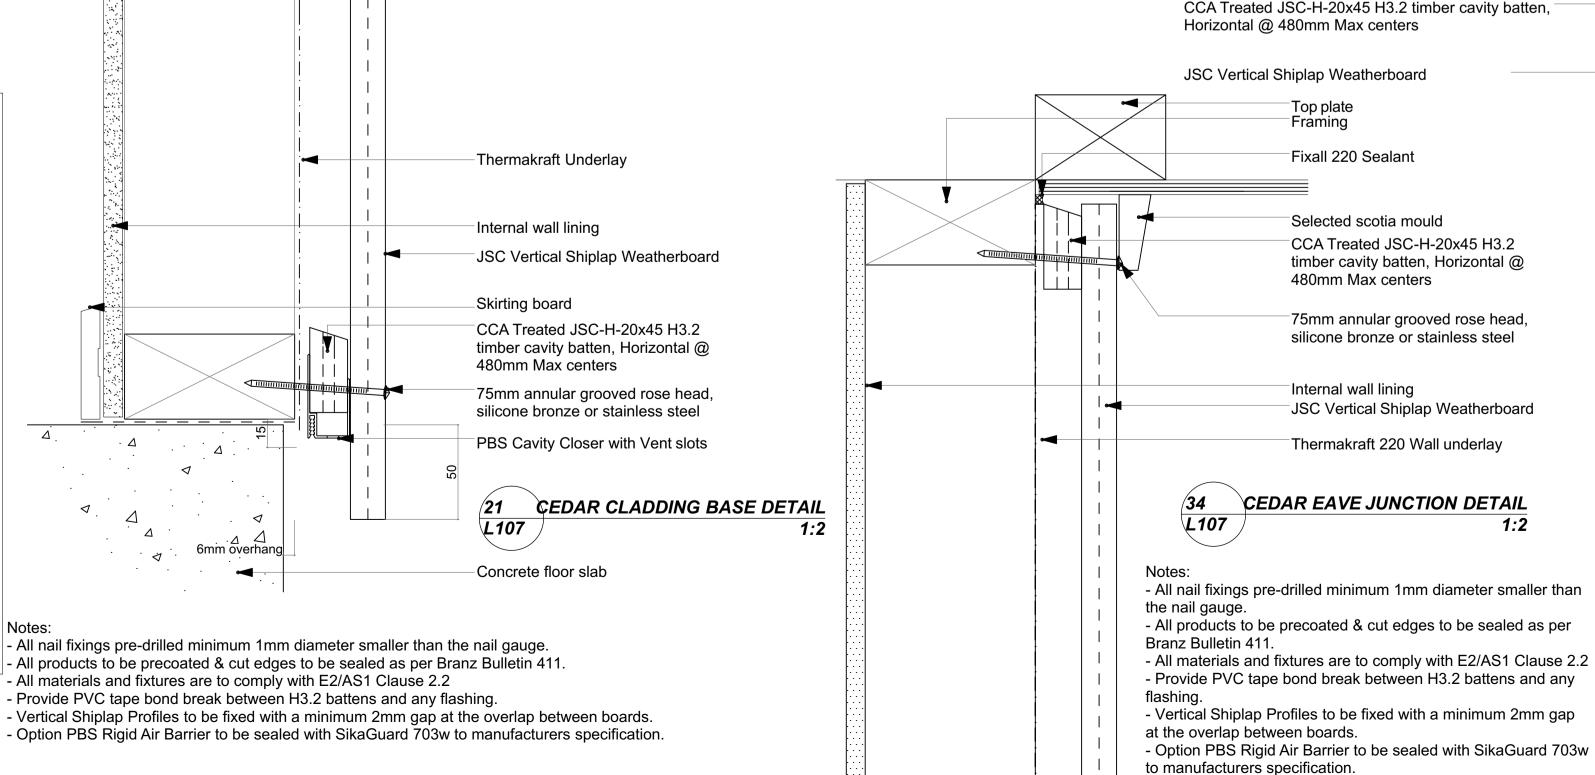


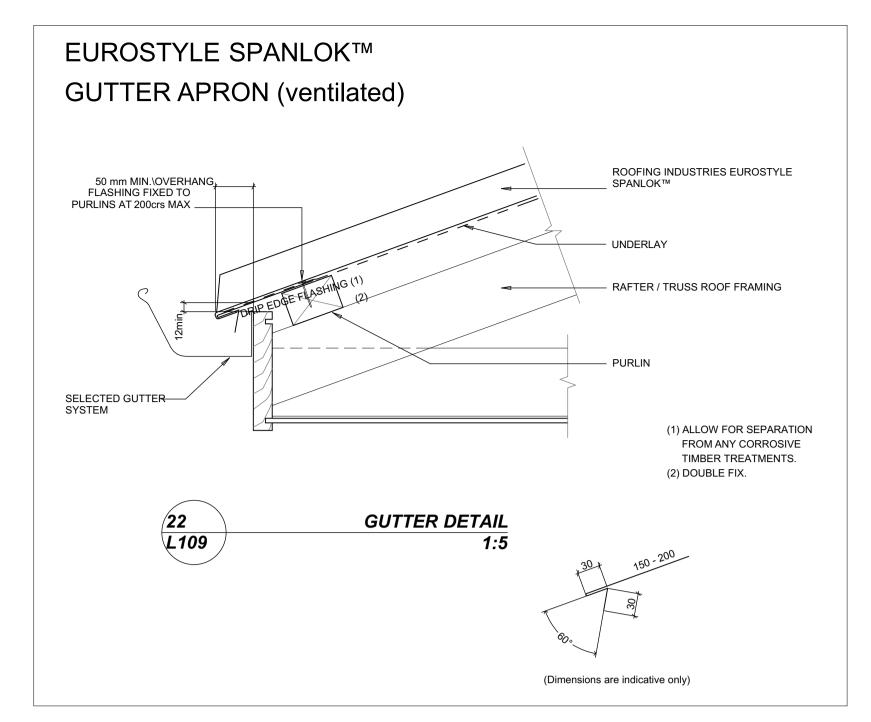

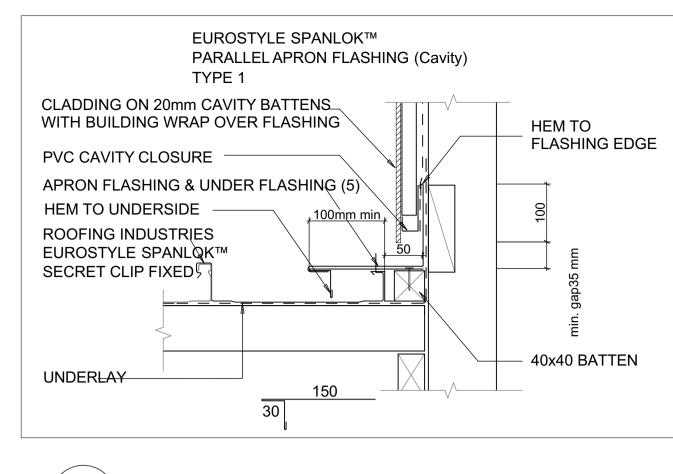

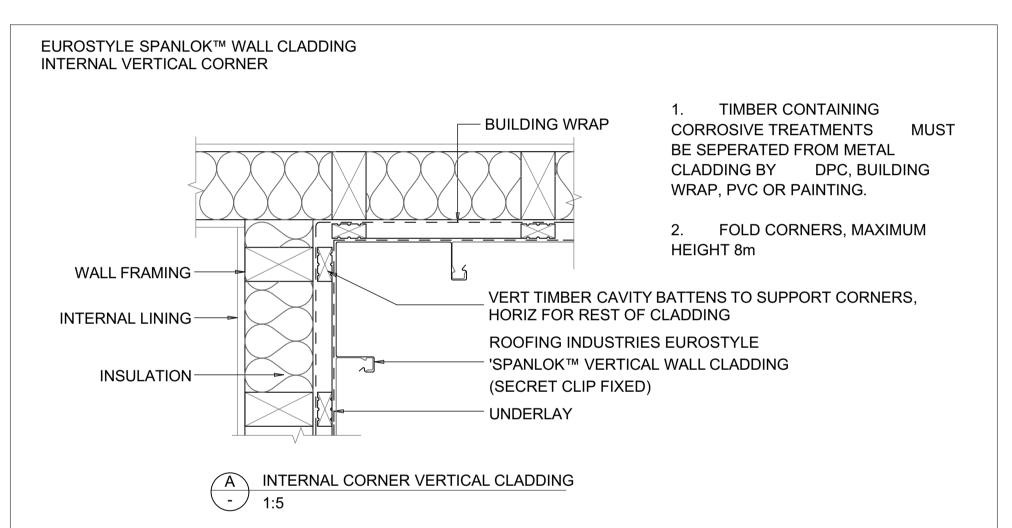

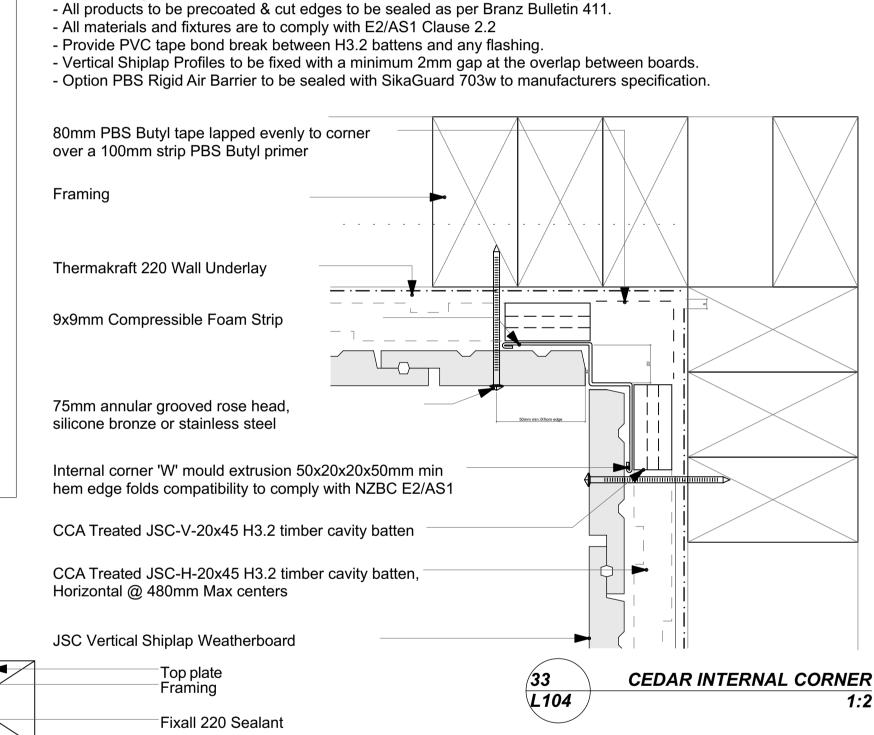

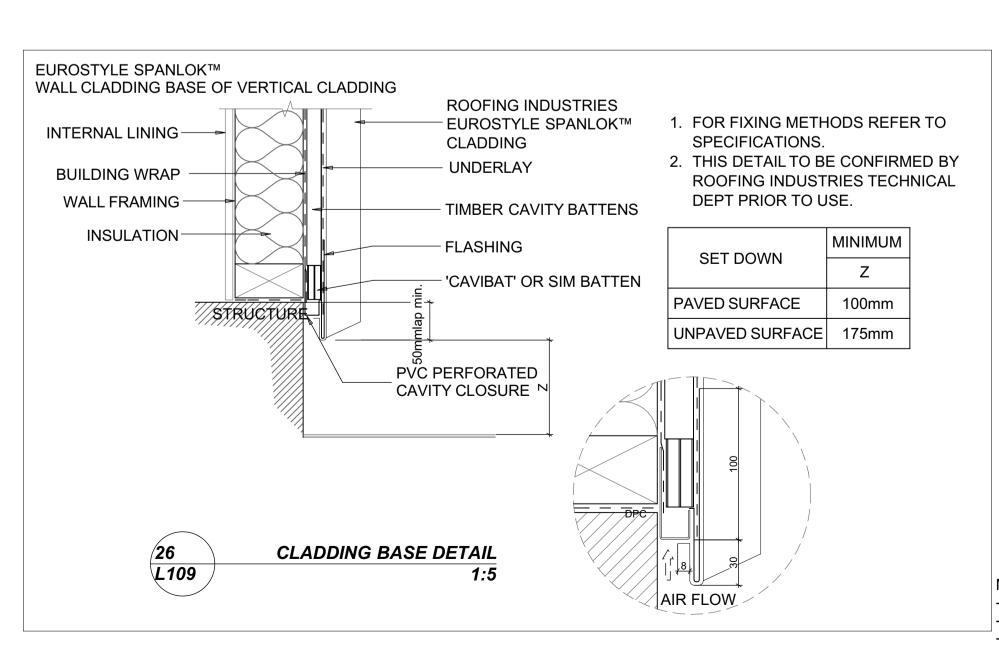

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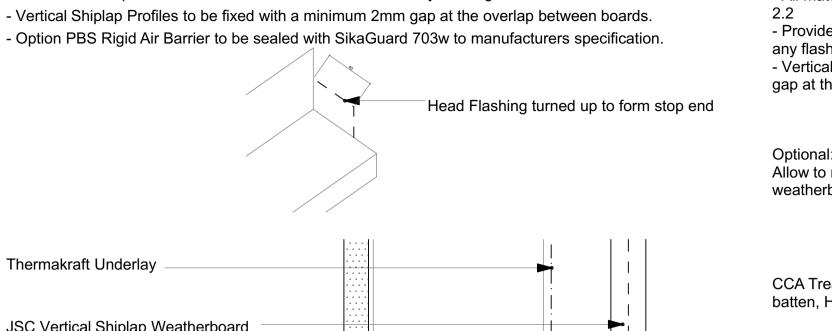
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SITE DETAILS URQUHARTS HOUSE FOR JAMES CROAD & SHONA POULSON 43 BASIL ROAD, WHANGAREI HEADS, WHANGAREI

ROOFING & CLADDING DETAILS

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1:5, 1:2@ A1	SHEET No. 22	OF	25
		_	LE (1:5, 1:2@ A1 SHEET NO. 22 OF LE PATH: Z:\13000- 13499\13060 - 43

- All nail fixings pre-drilled minimum 1mm diameter smaller than the nail gauge.
- All products to be precoated & cut edges to be sealed as per Branz Bulletin 411.
- All materials and fixtures are to comply with E2/AS1 Clause 2.2
- Provide PVC tape bond break between H3.2 battens and any flashing.
- Vertical Shiplap Profiles to be fixed with a minimum 2mm gap at the overlap between boards.



Thermakraft Underlay JSC Vertical Shiplap Weatherboard CCA Treated JSC-H-20x45 H3.2 timber cavity batten, Horizontal @ 480mm Max centers Gib board Flashing tape over head flashing with PBS Butyl tape 75mm annular grooved rose head, silicone bronze or stainless steel PBS Cavity Closer with Vent slots positioned to give 15° drip edge to cladding Stop end at head flashing Head flashing turned up to form stop end Proprietary prefolded head flashing with 15° fall Continuous air seal to perimeter of opening PBS Detail tape. 2 piece with spray tack adhesive P/C aluminium joinery indicative profile CEDAR CLADDING HEAD DETAIL

L108

- All nail fixings pre-drilled minimum 1mm diameter smaller than the nail gauge.

- All products to be precoated & cut edges to be sealed as per Branz Bulletin 411.

- All materials and fixtures are to comply with E2/AS1 Clause - Provide PVC tape bond break between H3.2 battens and

any flashing. - Vertical Shiplap Profiles to be fixed with a minimum 2mm gap at the overlap between boards.

Optional: folded 0.9mm jamb flashing. Allow to return flashing to suit


weatherboard depth

CCA Treated JSC-H-20x45 H3.2 timber cavity batten, Horizontal @ 480mm Max centers Thermakraft building underlay Gib board JSC Vertical Shiplap Weatherboard CCA Treated JSC-V-20x45 H3.2 timber cavity batten 18mm Scriber sealed to Weatherboard Sealant Continuous air seal to perimeter of opening

Alternate Option


PBS Detail tape. 2 piece with spray tack adhesive P/C aluminium joinery indicative profile Compressible foam tape seal Line of head flashing above CEDAR JAMB DETAIL


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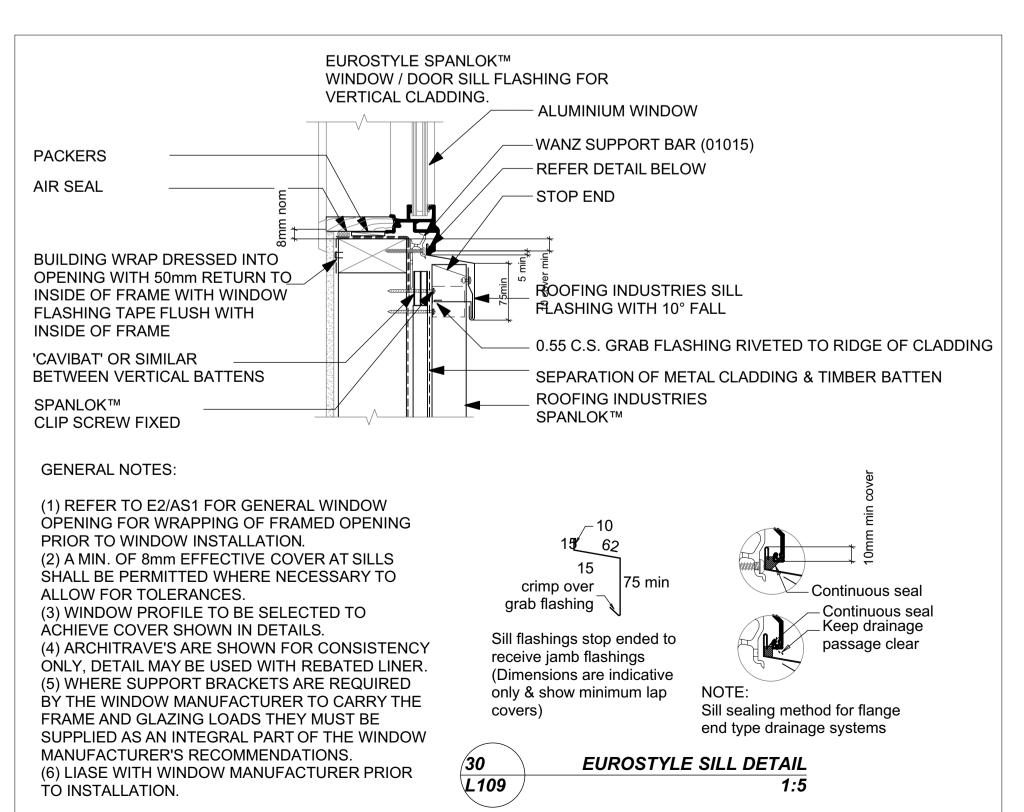


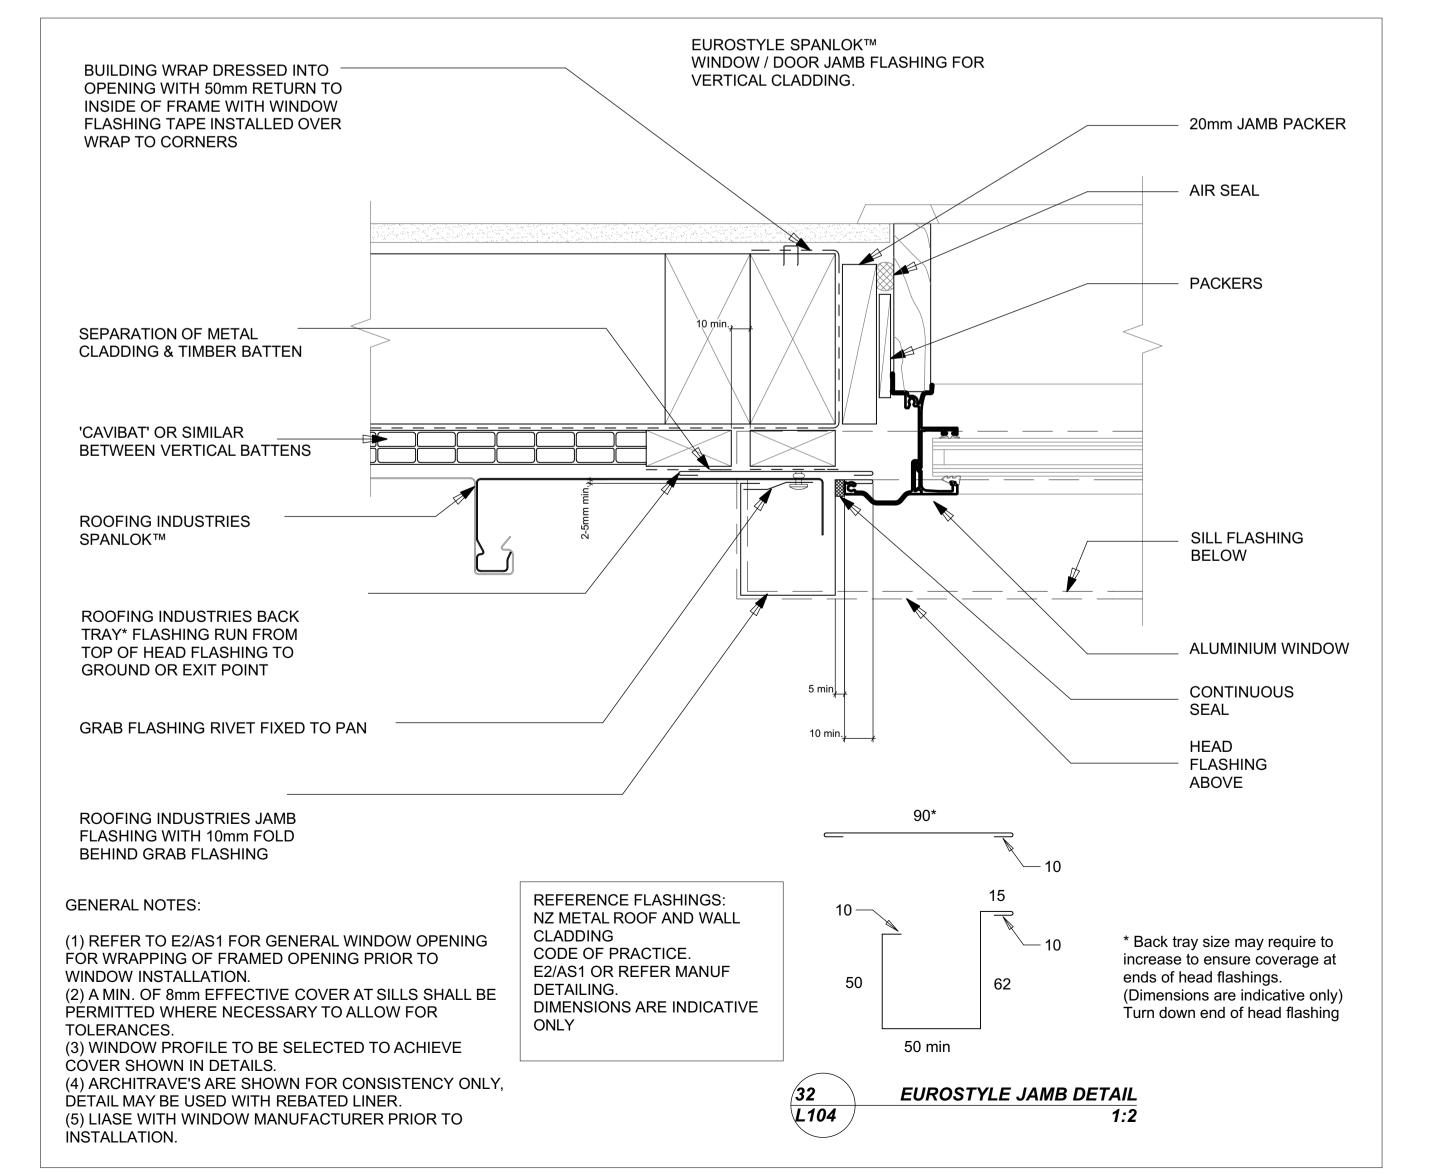1:2

- All nail fixings pre-drilled minimum 1mm diameter smaller than the nail gauge.
- All products to be precoated & cut edges to be sealed as per Branz Bulletin 411.
- All materials and fixtures are to comply with E2/AS1 Clause 2.2
- Provide PVC tape bond break between H3.2 battens and any flashing.
- Vertical Shiplap Profiles to be fixed with a minimum 2mm gap at the overlap between boards.



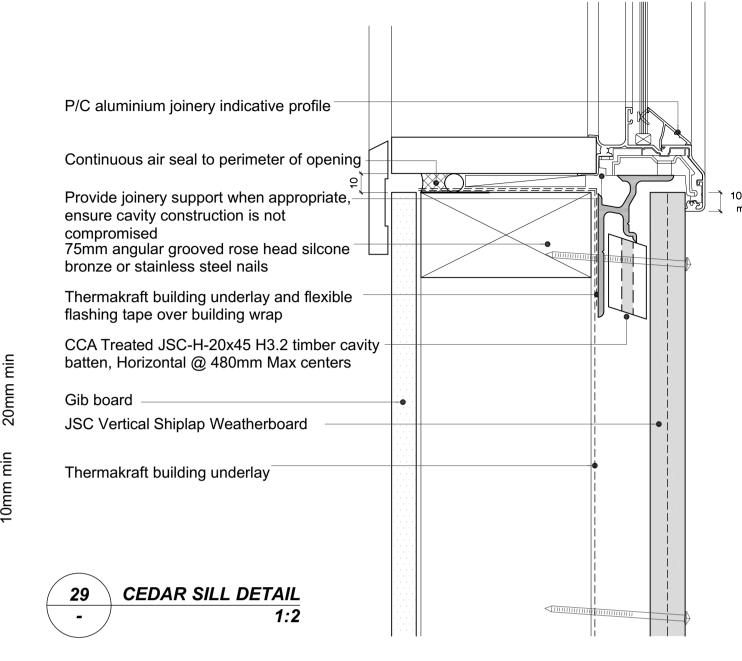

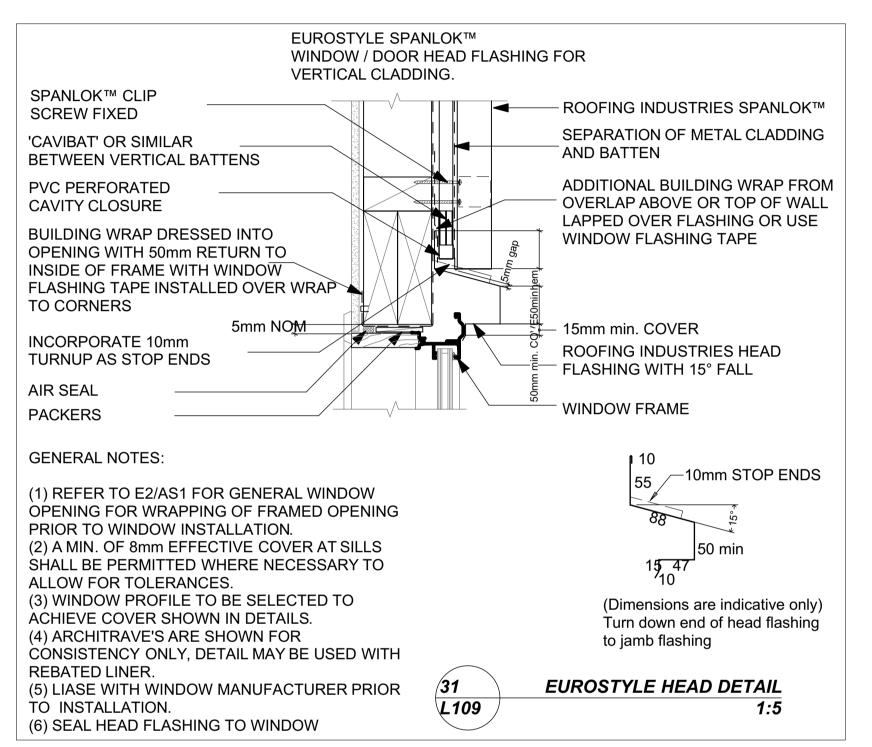




SITE DETAILS **URQUHARTS HOUSE** FOR JAMES CROAD & SHONA POULSON 43 BASIL ROAD, WHANGAREI HEADS. WHANGAREI

16-12-16

JOINERY DETAILS

DATE	CCL REF. No.	DWG NAME	REV.
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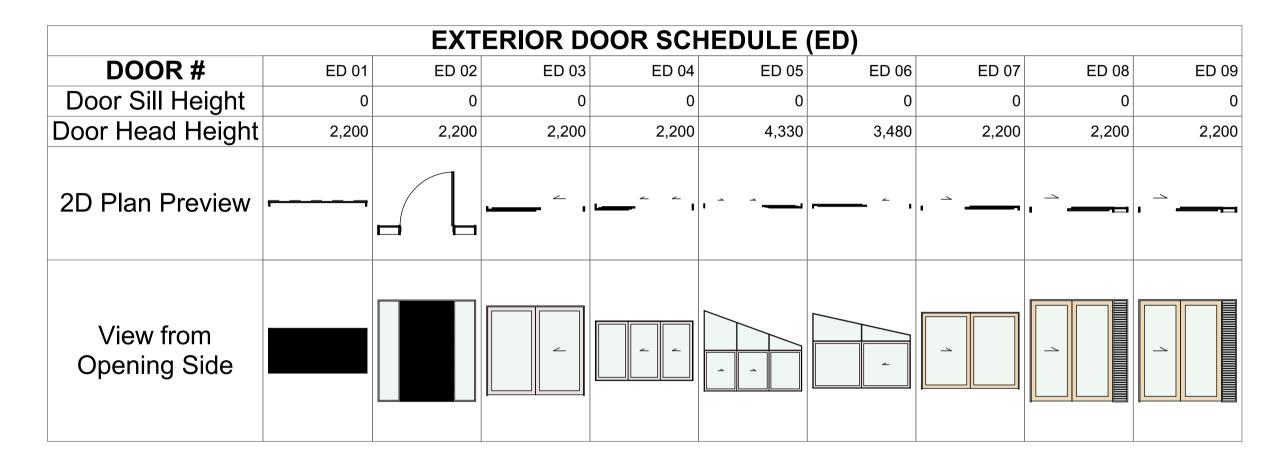
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							WIN	IDOW SC	HEDULE (W)								
Window #	W 01	W 02	W 03	W 04	W 05	W 06	W 07	W 08	W 09	W 10	W 11	W 12	W 13	W 14	W 15	W 16	W 17	W 18
Door Sill Height	1,200	1,200	1,200	600	600	0	2,600	0	0	200	200	200	200	900	1,000	1,600	1,000	1,000
Door Head Height	2,200	2,200	2,200	2,200	2,200	2,200	4,000	2,200	2,200	2,200	2,200	2,200	2,200	2,200	2,200	2,200	2,200	2,200
2D Plan Preview																		
View from Opening Side																		

WINDOW SCHEDULE

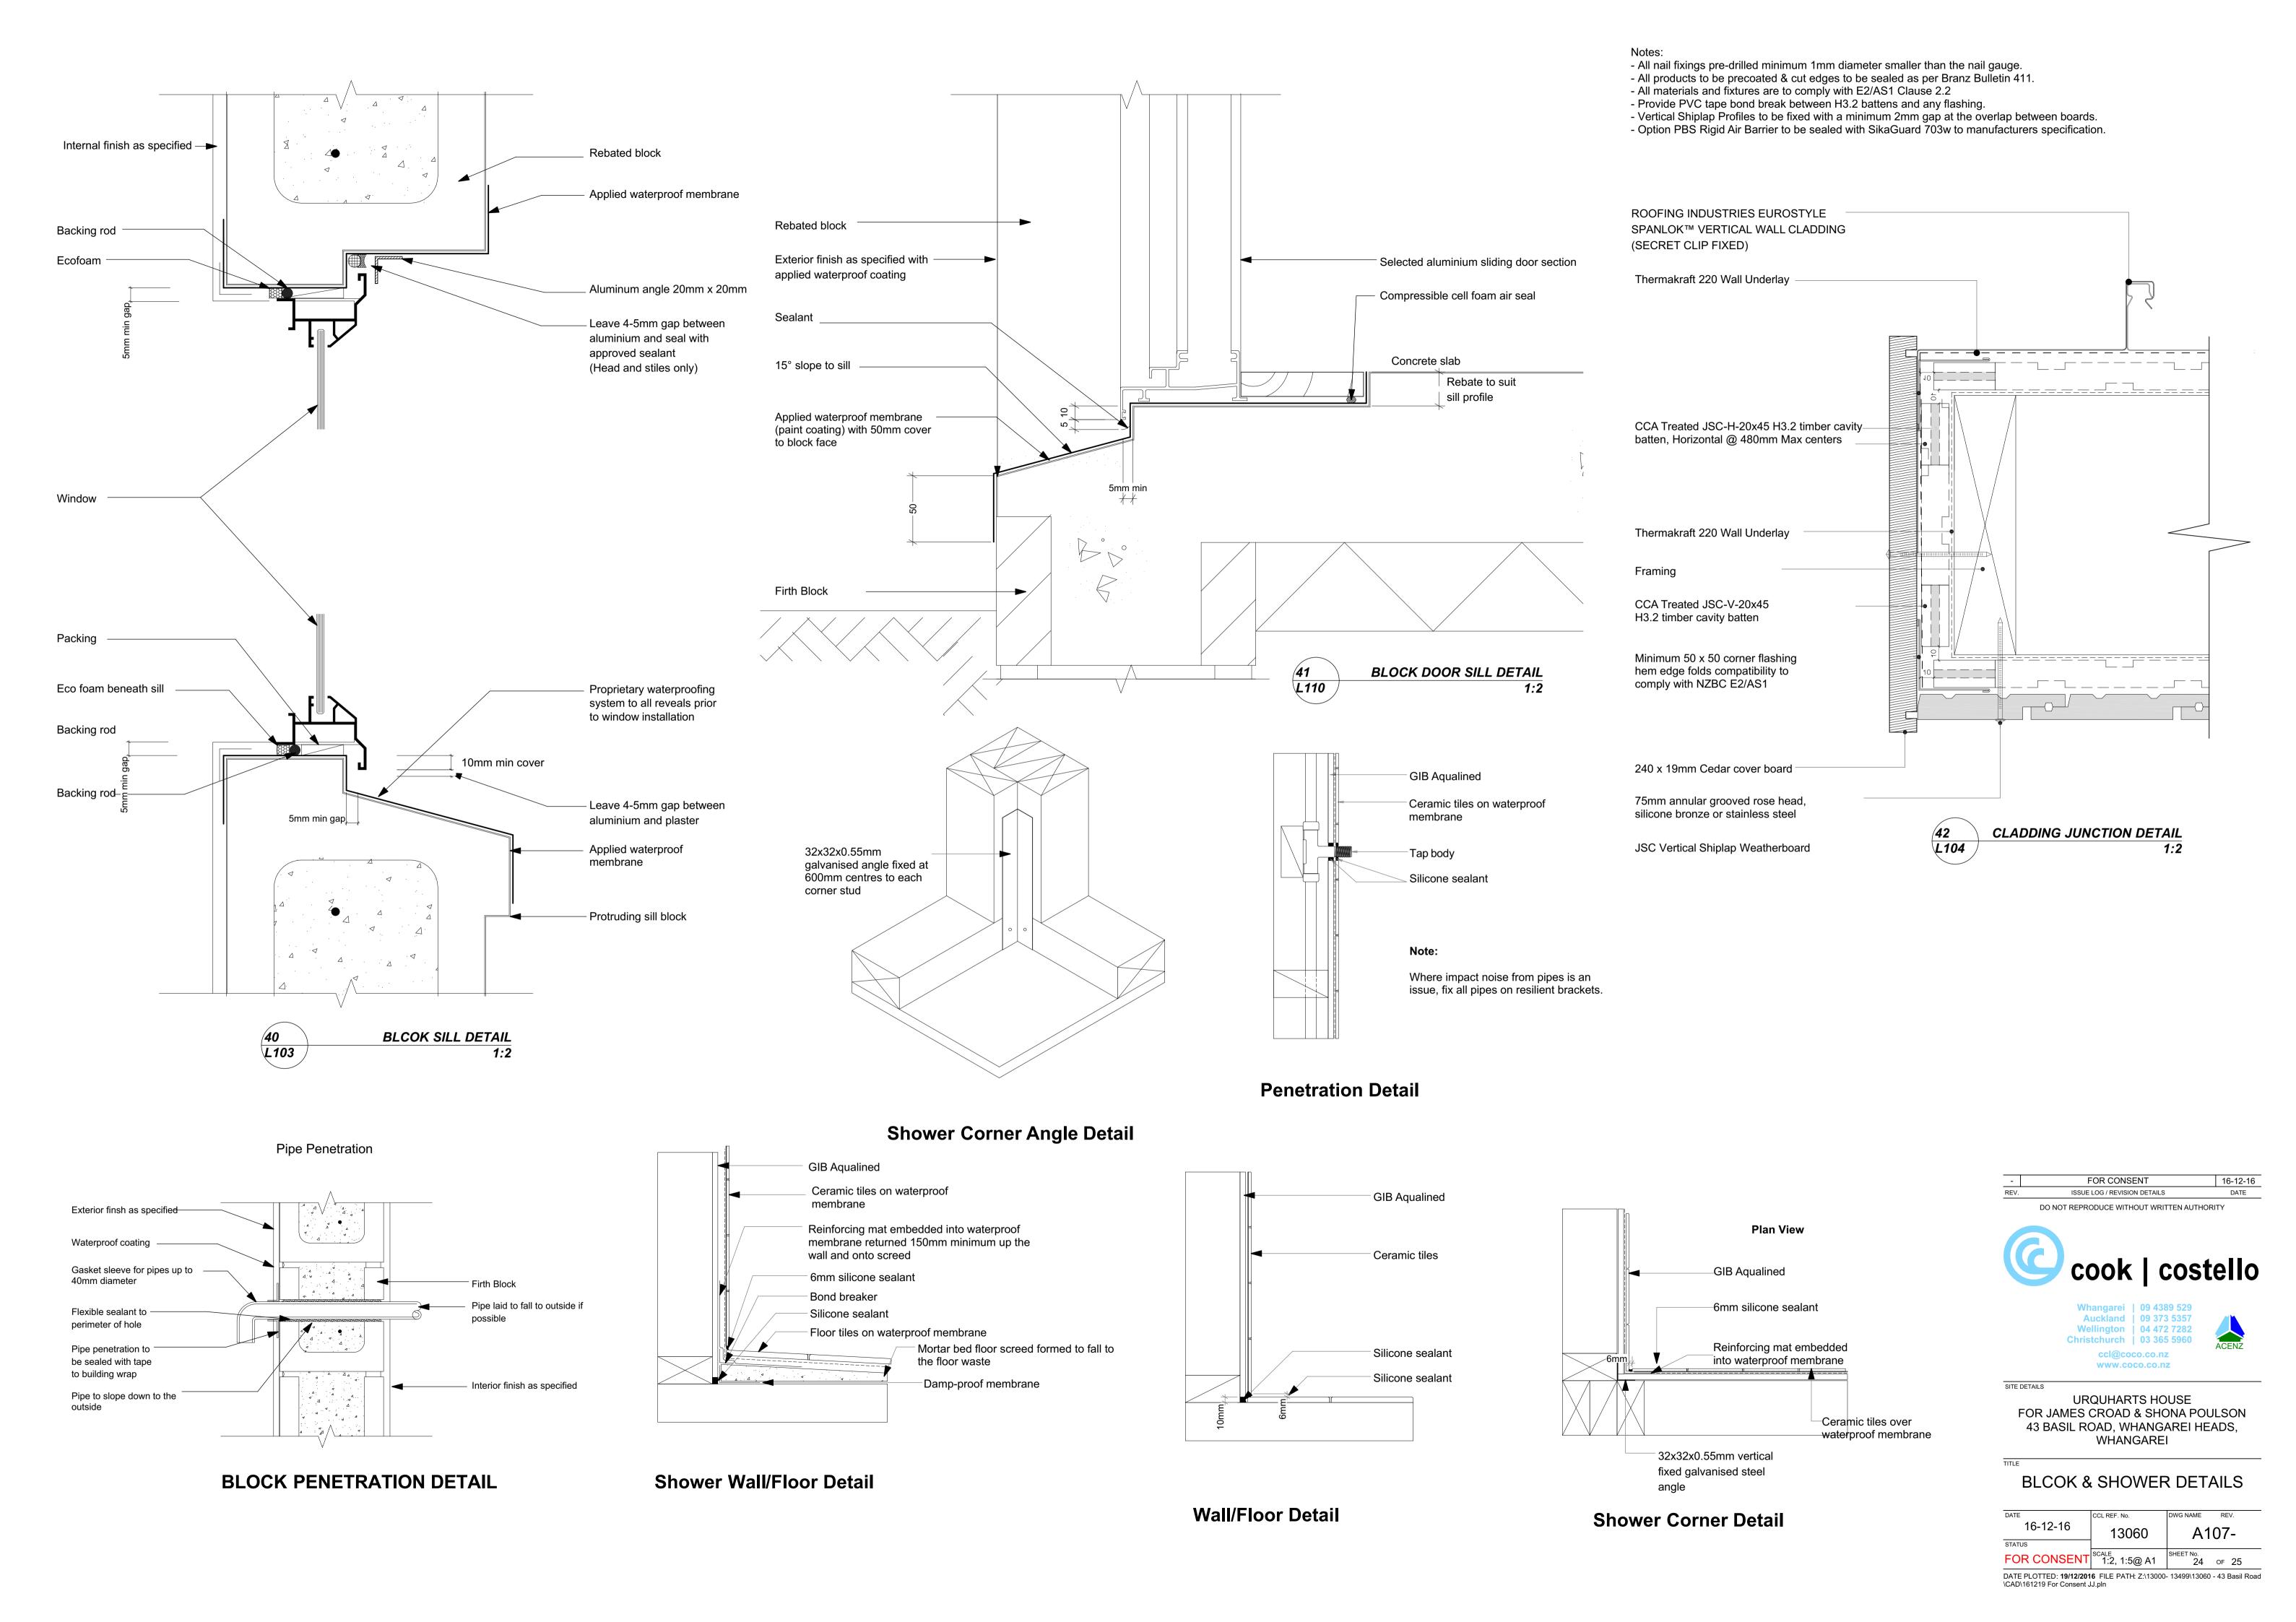1:1



EXTERIOR DOOR SCHEDULE

				INTI	ERIOR D	OOR SC	HEDULE	(ID)						
Door #	ID 01	ID 02	ID 03	ID 04	ID 05	ID 06	ID 07	ID 08	ID 09	ID 10	ID 11	ID 12	ID 13	ID 14
W/D Nominal Sill Height	0	0	0	0	0	0	0	0	0	0	0	0	0	0
W/D Nominal Head Height	2,200	2,025	2,025	2,025	2,025	2,025	2,025	2,025	2,025	2,025	2,025	2,025	2,200	2,200
2D Plan Preview -											8	<u> </u>		I
View from Opening Side														


INTERIOR DOOR SCHEDULE

1:1



- NOTE:
 1. All external joinery to be aluminium powder coated finish colour to be Silver Perl
 2. All Glazing to comply with NZS:4223
 3. All Aluminium to be doubled glazed
 4. Window sills to be aluminium
 5. All windows to be fitted with double

- tongue catches
- 6. All internal doors to be Timber solid
- core doors
 7. All external louvers to be glass

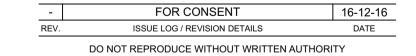



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SITE DETAILS URQUHARTS HOUSE FOR JAMES CROAD & SHONA POULSON 43 BASIL ROAD, WHANGAREI HEADS,

WHANGAREI

WINDOW AND DOOR SCHEDULES

	CCL REF. No.	DWG NAME	REV.
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STATUS			
FOR CONSENT	1:1@ A1	SHEET No. 25	OF 25