
## EROSION AND SEDIMENT CONTROL GENERAL NOTES

- THE CONTRACTOR SHALL NOTIFY MDE AT (410) 537-3510 SEVEN (7) DAYS BEFORE COMMENCING ANY LAND DISTURBING ACTIVITY AND, UNLESS WAIVED BY MDE, SHALL BE REQUIRED TO HOLD A PRE- CONSTRUCTION MEETING BETWEEN PROJECT REPRESENTATIVES AND A REPRESENTATIVE
- THE CONTRACTOR SHALL NOTIFY MDE IN WRITING AND BY TELEPHONE AT THE FOLLOWING POINTS:
- A. THE REQUIRED PRE-CONSTRUCTION MEETING.
- B. FOLLOWING INSTALLATION OF SEDIMENT CONTROL MEASURES.
- C. DURING THE INSTALLATION OF SEDIMENT BASINS (TO BE CONVERTED INTO PERMANENT STORMWATER MANAGEMENT STRUCTURES) AT THE
- D. PRIOR TO REMOVAL OR MODIFICATION OF ANY SEDIMENT CONTROL STRUCTURE(S)
- E. PRIOR TO REMOVAL OF ALL SEDIMENT CONTROL DEVICES.
- THE PLAN APPROVAL LETTER, APPROVED EROSION AND SEDIMENT CONTROL PLANS, DAILY LOG BOOKS, AND TEST REPORTS SHALL BE AVAILABLE AT THE SITE FOR INSPECTION BY DULY AUTHORIZED OFFICIALS OF MDE AND THE AGENCY RESPONSIBLE FOR THE PROJECT.
- THE CONTRACTOR SHALL CONSTRUCT ALL EROSION AND SEDIMENT CONTROL MEASURES PER THE APPROVED PLAN AND CONSTRUCTION SEQUENCE AN SHALL HAVE THEM INSPECTED AND APPROVED BY THE MDE INSPECTOR PRIOR TO BEGINNING ANY OTHER LAND DISTURBANCES. MINOR SEDIMENT CONTROL MEASURE WITHOUT PRIOR PERMISSION FROM MDE INSPECTOR. THE CONTRACTOR SHALL OBTAIN PRIOR AGENCY AND MDE APPROVAL FOR MODIFICATIONS TO THE EROSION AND SEDIMENT CONTROL PLAN AND/OR SEQUENCE OF CONSTRUCTION.
- THE MDE INSPECTOR HAS THE OPTION OF REQUIRING ADDITIONAL SAFETY OR SEDIMENT CONTROL MEASURES, IF DEEMED NECESSARY.
- THE CONTRACTOR SHALL PROTECT ALL POINTS OF CONSTRUCTION INGRESS AND EGRESS TO PREVENT THE DEPOSITION OF MATERIALS ONTO PUBLIC ROADS, ALL MATERIALS DEPOSITED ONTO PUBLIC ROADS SHALL BE REMOVED IMMEDIATELY
- THE CONTRACTOR SHALL INSPECT DAILY AND MAINTAIN CONTINUOUSLY IN AN EFFECTIVE OPERATING CONDITION ALL EROSION AND SEDIMENT CONTROL MEASURES UNTIL SUCH TIME AS THEY ARE REMOVED WITH PRIOR PERMISSION FROM THE MDE INSPECTOR.
- EROSION AND SEDIMENT CONTROL FOR UTILITY CONSTRUCTION SHALL BE PROVIDED IN ACCORDANCE WITH APPROVED PLANS. UTILITY CONSTRUCTION SHALL ONLY BE FOR AREAS WITHIN THE DELINEATED LIMIT OF DISTURBANCE. CALL "MISS UTILITY" AT 1-800-257-7777 48 HOURS
- PRIOR TO THE START OF WORK. WHEN SAME DAY STABILIZATION IS APPROVED A. EXCAVATED TRENCH MATERIAL SHALL BE PLACED ON THE HIGH SIDE OF THE TRENCH.
- B. TRENCHES FOR UTILITY INSTALLATION SHALL BE BACKFILLED, COMPACTED, AND STABILIZED AT THE END OF EACH WORKING DAY. NO MORE
- ALL WATER REMOVED FROM EXCAVATED AREAS SHALL BE PASSED THROUGH AN MDE APPROVED DEWATERING PRACTICE OR PUMPED TO A SEDIMENT TRAP OR BASIN PRIOR TO DISCHARGE TO A FUNCTIONAL STORM DRAIN SYSTEM OR TO STABLE GROUND SURFACE
- 11. CONSTRUCTION ACTIVITIES PRODUCING DUST SHALL IMPLEMENT CONTROL MEASURES TO AVOID THE SUSPENSION OF DUST PARTICLES AND/OR PREVENT
- DUST FROM BLOWING OFF-SITE OR TO AREAS WITHOUT TREATMENT. FOLLOWING INITIAL SOIL DISTURBANCE OR RE-DISTURBANCE, PERMANENT OR TEMPORARY STABILIZATION SHALL BE COMPLETED WITHIN:
- A. THREE (3) CALENDAR DAYS AS TO THE SURFACE OF ALL PERIMETER CONTROLS, DIKES, SWALES, DITCHES, PERIMETER SLOPES, AND ALL SLOPES STEEPER THAN 3 HORIZONTAL TO 1 VERTICAL (3:1); AND
- B. SEVEN (7) CALENDAR DAYS AS TO ALL OTHER DISTURBED OR GRADED AREAS ON THE PROJECT SITE NOT UNDER ACTIVE GRADING. 13. VEGETATIVE STABILIZATION SHALL BE PERFORMED IN ACCORDANCE WITH THE 2011 MARYLAND STANDARDS AND SPECIFICATIONS FOR SOIL EROSION
- 14. WHEN SEEDING, ALL DISTURBED AREAS WITH SLOPES FLATTER THAN 2:1 SHALL BE STABILIZED WITH 4 INCHES OF TOPSOIL, SEED, AND MULCH. ALL DISTURBED AREAS WITH SLOPES 2:1 OR STEEPER SHALL BE STABILIZED WITH MATTING OVER 2 INCHES OF TOPSOIL AND SEED
- 15. ALL SEDIMENT BASINS, TRAP EMBANKMENTS AND SLOPES, PERIMETER DIKES, SWALES AND ALL DISTURBED SLOPES STEEPER OR EQUAL TO 3:1 SHALL BE STABILIZED WITH SEED AND ANCHORED STRAW MULCH, SOD, OR OTHER APPROVED STABILIZATION MEASURES, AS SOON AS POSSIBLE BUT NO LATER THAN THREE (3) CALENDAR DAYS AFTER ESTABLISHMENT. ALL AREAS DISTURBED OUTSIDE OF THE PERIMETER SEDIMENT CONTROL SYSTEM SHALL BI MINIMIZED. MAINTENANCE SHALL BE PERFORMED AS NECESSARY TO ENSURE CONTINUED STABILIZATION
- 16. PERMANENT SWALES OR OTHER POINTS OF CONCENTRATED WATER FLOW SHALL BE STABILIZED WITH SEED AND AN APPROVED EROSION CONTRO MATTING, SOD, RIP-RAP, OR OTHER APPROVED STABILIZATION MEASURES.
- 17. FOR STOCKPILE SLOPES STEEPER THAN 3 HORIZONTAL TO 1 VERTICAL (3:1), THE CONTRACTOR SHALL APPLY SEED AND ANCHORED STRAW MULCH, SOD, OR OTHER APPROVED STABILIZATION MEASURES TO THE FACE OF THE STOCKPILE WITHIN THREE (3) CALENDAR DAYS OF ACTIVITY HAVING CEASED ON THE RESPECTIVE FACE. FOR SLOPES 3:1 OR FLATTER, THE CONTRACTOR SHALL APPLY STABILIZATION MEASURES TO THE FACE OF THE STOCKPILE WITHIN SEVEN (7) CALENDAR DAYS OF ACTIVITY HAVING CEASED ON THE RESPECTIVE FACE, MAINTENANCE SHALL BE PERFORMED AS NECESSARY TO ENSURE CONTINUED STABILIZATION.
- 18. FOR FINISHED GRADING, THE CONTRACTOR SHALL PROVIDE ADEQUATE GRADIENTS TO PREVENT WATER FROM PONDING FOR MORE THAN TWENTY-FOUR (24) HOURS AFTER THE END OF A RAINFALL EVENT, DRAINAGE COURSES AND SWALE FLOW AREAS MAY TAKE AS LONG AS FORTY-EIGHT (48) HOURS AFTER THE END OF A RAINFALL EVENT TO DRAIN. AREAS DESIGNED TO HAVE STANDING WATER SHALL NOT BE REQUIRED TO MEET THIS REQUIREMENT.
- WHERE DEEMED APPROPRIATE BY THE ENGINEER OR INSPECTOR, SEDIMENT BASINS AND TRAPS MAY NEED TO BE SURROUNDED WITH AN APPROVED SAFETY FENCE. THE FENCE MUST CONFORM TO LOCAL ORDINANCES AND REGULATIONS. THE DEVELOPER OR OWNER SHALL CHECK WITH LOCAL BUILDING OFFICIALS ON APPLICABLE SAFETY REQUIREMENTS. WHERE SAFETY FENCE IS DEEMED APPROPRIATE AND LOCAL ORDINANCES DO NOT SPECIFY FENCING SIZES AND TYPES, THE FOLLOWING SHALL BE USED AS A MINIMUM STANDARD: THE SAFETY FENCE SHALL BE MADE OF WELDED WIRE AND AT LEAST 42 INCHES HIGH, HAVE POSTS SPACED NO FARTHER APART THAN 8 FEET, HAVE MESH OPENINGS NO GREATER THAN 2 INCHES IN WIDTH AND 4 INCHES IN HEIGHT WITH A MINIMUM OF 14 GAUGE WIRE. SAFETY FENCE SHALL BE MAINTAINED AND IN GOOD CONDITION AT ALL TIMES.
- 20. ALL SEDIMENT TRAP DEPTH DIMENSIONS ARE RELATIVE TO THE OUTLET ELEVATION, ALL TRAPS SHALL HAVE A STABLE OUTFALL, ALL TRAPS AND BASINS SHALL HAVE STABLE INFLOW POINTS.
- SEDIMENT SHALL BE REMOVED AND THE TRAP OR BASIN RESTORED TO ITS ORIGINAL DIMENSIONS WHEN THE SEDIMENT HAS ACCUMULATED TO ONE OUARTER OF THE TOTAL DEPTH OF THE TRAP OR BASIN. TOTAL DEPTH SHALL BE MEASURED FROM THE TRAP OR BASIN BOTTOM TO THE CREST OF THE OUTLET.
- 22. SEDIMENT REMOVED FROM TRAPS (AND BASINS) SHALL BE PLACED AND STABILIZED IN APPROVED AREAS, BUT NOT WITHIN A FLOODPLAIN, WETLAND OR TREE-SAVE AREA. WHEN PUMPING SEDIMENT LADEN WATER, THE DISCHARGE SHALL BE DIRECTED TO AN MDE APPROVED SEDIMENT TRAPPING DEVICE PRIOR TO RELEASE FROM THE SITE. A SUMP PIT MAY BE USED IF SEDIMENT TRAPS THEMSELVES ARE BEING PUMPED OUT
- 23. PRIOR TO REMOVAL OF SEDIMENT CONTROL MEASURES, THE CONTRACTOR SHALL STABILIZE AND HAVE ESTABLISHED PERMANENT STABILIZATION FOR ALL CONTRIBUTORY DISTURBED AREAS USING SOD OR AN APPROVED PERMANENT SEED MIXTURE WITH REQUIRED SOIL AMENDMENTS AND AN APPROVED ANCHORED MULCH. WOOD FIBER MULCH MAY ONLY BE USED IN SEEDING SEASON WHERE THE SLOPE DOES NOT EXCEED 10% AND GRADING HAS BEEN DONE TO PROMOTE SHEET FLOW DRAINAGE. AREAS BROUGHT TO FINISHED GRADE DURING THE SEEDING SEASON SHALL BE PERMANENTLY STABILIZED AS SOON AS POSSIBLE, BUT NOT LATER THAN THREE (3) CALENDAR DAYS AFTER ESTABLISHMENT FOR SLOPES STEEPER THAN 3 HORIZONTAL TO 1 VERTICAL (3:1) AND SEVEN (7) CALENDAR DAYS FOR FLATTER SLOPES. WHEN PROPERTY IS BROUGHT TO FINISHED GRADE DURING THE MONTHS OF NOVEMBER THROUGH FEBRUARY, AND PERMANENT
- STABILIZATION IS FOUND TO BE IMPRACTICAL, TEMPORARY SEED AND ANCHORED STRAW MULCH SHALL BE APPLIED TO DISTURBED AREAS. THE FINAL PERMANENT STABILIZATION OF SUCH PROPERTY SHALL BE APPLIED BY MARCH 15 OR EARLIER IF GROUND AND WEATHER CONDITIONS ALLOW.
- TEMPORARY SEDIMENT CONTROL DEVICES SHALL BE REMOVED WITH PERMISSION OF THE MDE INSPECTOR WITHIN THIRTY (30) CALENDAR DAYS FOLLOWING ESTABLISHMENT OF PERMANENT STABILIZATION IN ALL CONTRIBUTORY DRAINAGE AREAS. UPON REMOVAL OF SEDIMENT CONTROL DEVICES, THE AREA DISTURBED BY REMOVAL SHALL BE STABILIZED WITH TOPSOIL, SEED, AND MULCH, OR AS SPECIFIED, WITHIN 24 HOURS OF SAID REMOVAL, STORMWATER MANAGEMENT STRUCTURES USED TEMPORARILY FOR SEDIMENT CONTROL SHALL BE CONVERTED TO THE PERMANENT CONFIGURATION WITHIN THIS TIME PERIOD AS WELL.
- 25. OFF-SITE SPOIL OR BORROW AREAS ON STATE OR FEDERAL PROPERTY SHALL HAVE PRIOR APPROVAL BY MDE AND OTHER APPLICABLE STATE, FEDERAL AND LOCAL AGENCIES; OTHERWISE APPROVAL SHALL BE GRANTED BY THE LOCAL AUTHORITIES. ALL WASTE AND BORROW AREAS OFF-SITE SHALL BE PROTECTED BY SEDIMENT CONTROL MEASURES AND STABILIZED.
- 26. SITE INFORMATION:
- A. AREA DISTURBED 0.18 ACRES
- B. TOTAL CUT 1250 CUBIC YARDS
- C. TOTAL FILL 1250 CUBIC YARDS
- D. OFF-SITE WASTE / BORROW AREA LOCATION O

# CPOP REPAIR WEST WHARF CG YARD (FY19)

# AT U.S. COAST GUARD YARD / BALTIMORE, MARYLAND / PROJECT NUMBER - 8617883 MDE PROJECT NO. 18-SF-0000?

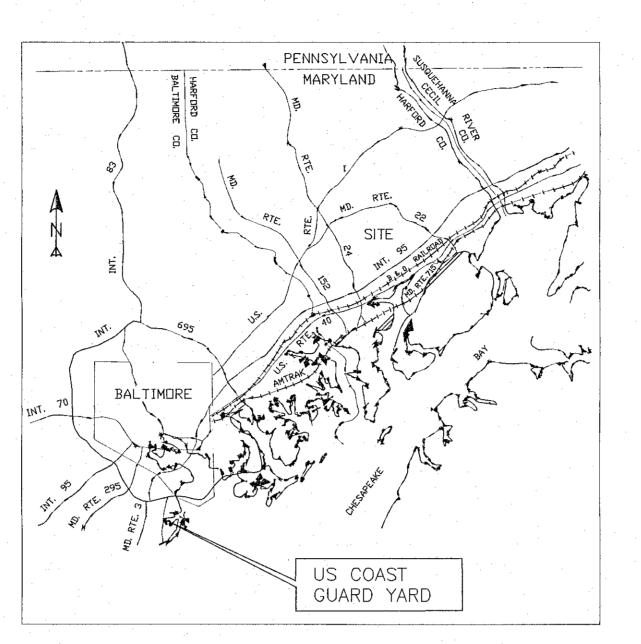

SITE ANALYSIS

LEGEND

TOTAL PROJECT AREA: 41,218 SQ. FT (0.94 ACRES)

NEW SOIL DISTURBANCE: 7,800 SQ. FT (0.30 ACRES)

TOTAL DISTURBED AREA: 0.18 ACRES

VOLUME OF CUT: 1,250 CUBIC YARDS VOLUME OF FILL: 1,250 CUBIC YARDS

VOLUME OF BORROW: O CUBIC YARDS

---- - - PROPERTY LINE

---sf--- SILT FENCE

====== EXISTING PIPELINE

----- EXISTING 100-YEAR

—————— LIMIT OF DISTURBANCE

EXISTING TREE

AGIP (AT GRADE INLET PROTECTION)

EXISTING TREE TO BE REMOVED

APPROXIMATE TREE LINE

—— PROPOSED GRADE

# **VICINITY MAP**

SCALE: N.T.S.

# SEQUENCE OF CONSTRUCTION

THESE PLANS WERE PREPARED IN CONFORMANCE WITH THE REQUIREMENTS OF THE MARYLAND DEPARTMENT OF ENVIRONMENTAL PROTECTION.

- 2. CONTACT THE MARYLAND DEPARTMENT OF THE ENVIRONMENT AT (410) 537-3510 AT LEAST 7 DAYS PRIOR TO COMMENCING LAND DISTURBING ACTIVITY.
- 3. THE CONTRACTOR SHALL NOTIFY THE U.S. COAST GUARD CONTRACTING OFFICE 48 HOURS BEFORE COMMENCING WORK TO CONDUCT A PRE-CONSTRUCTION MEETING ON SITE WITH THE CONTRACTOR, PROJECT ENGINEER, THE U.S. COAST GUARD CONTRACTING OFFICER, AND APPROPRIATE AGENCY PERSONNEL TO REVIEW EROSION AND SEDIMENT CONTROL REQUIREMENTS AND SEQUENCE OF CONSTRUCTION. 1 DAY
- 4. INSPECT THE SITE PRIOR TO CONSTRUCTION TO VERIFY EXISTING SITE CONDITIONS, UNDERGROUND UTILITY LOCATIONS AND PROVIDE A SURVEY AND LAYOUT OF THE LIMITS OF DISTURBANCE. LOD MUST BE FIELD MARKED PRIOR TO CLEARING TREES, INSTALLING SEDIMENT CONTROLS OR OTHER LAND DISTURBING ACTIVITIES. 1 DAY
- 5. INSTALL SEDIMENT CONTROLS AND THE STAGING/LAYDOWN AREAS. MECHANICAL STABILIZATION MAY BE REQUIRED ON THE STAGING/LAYDOWN AREAS AND HEAVY USE AREAS, INCLUDING TRAVEL LANES. WOOD CHIPS MAY BE USED WITH APPROVAL FROM
- 6. ONCE SEDIMENT CONTROLS HAVE BEEN INSTALLED, CONTACT THE INSPECTOR FOR APPROVAL OF SEDIMENT CONTROL INSTALLATION PRIOR TO COMMENCING WORK. INSPECTIONS AND PERMITS MAY REQUIRE THAT AN INSPECTION AND CERTIFICATION OF THE INSTALLATION OF SEDIMENT CONTROL ALSO BE PERFORMED BY A DESIGN PROFESSIONAL PRIOR TO CONSTRUCTION COMMENCING. 2 DAYS.
- 7. EXCAVATE EXISTING WHARF AREAS DOWN TO WOOD PLANK DECKING AND REPAIR STRUCTURE AS SHOWN ON THESE PLÂNS. ALL AREAS OF EXCAVATION MUST BE SEPARATED FROM VEHICULAR AND PEDESTRIAN TRAFFIC USING CONCRETE JERSEY BARRIERS MIN. 5'Lx2'Wx32"H, 2,000LBS.; MAX. 40 DAYS PER EACH AREA. BACKFILL AND COMPACT AS INDICATED. 120 DAYS.
- 8. AFTER AREAS ARE BACKFILLED, REPAIR ROADWAY AS IDENTIFIED IN PAVEMENT DETAIL ON SHEET C-03. IN NON-PAVED AREAS STABILIZE AREA WITH 4" OF CLEAN #57 STONE IN ACCORDANCE WITH EXISTING CONDITIONS. 15 DAYS.
- 9. AFTER THE SITE IS 95% STABILIZED, EITHER VEGETATED OR MECHANICALLY, REMOVE THE SEDIMENT CONTROLS WITH THE APPROVAL OF THE CONTRACTING OFFICER / COR, REMOVE ALL TEMPORARY FACILITIES (I.E., SILT FENCE OR ANY PROTECTIVE MEASURES), RESTORE AND REVEGETATE AS NEEDED. WHEN ALL UPSTREAM AREAS HAVE BEEN STABILIZED AND HAVE BEEN ACCEPTED BY THE CONTRACTING OFFICER OR COR, REMOVE REMAINING PERIMETER CONTROLS AND IMMEDIATELY STABILIZE AREAS DISTURBED BY THE REMOVAL OF THESE CONTROLS. THOROUGHLY CLEAN AND RESTORE SITE TO SATISFACTION OF COR. 7 DAYS.
- 10. CONSTRUCTION ANTICIPATED TO COMMENCE BY 3/1/19 AND CONCLUDE BY 8/15/2019.

DRAWING NUMBER		SHEET NUMBER
1 OF 7	TITLE SHEET	G-01
2 OF 7	CIVIL WORK & PROJECT SITE PLAN	C/01
3 OF 7	SITE PLAN DETAILS	C/02
4 OF 7	PILE REPAIR DETAILS	C/03
5 OF 7	EROSION & SEDIMENT CONTROL PLAN	C/04
6 OF 7	EROSION & SEDIMENT CONTROL DETAILS	C/05
7 OF 7	EROSION & SEDIMENT CONTROL NOTES	C/06

I HEREBY CERTIFY THAT THIS PL MARYLAND STANDARDS AND SP				
2000 MARYLAND STORMWATER	DESIGN MANU	AL, VOLUMES I & I	I INCLUDING SUPPLE	MENTS,
THE ENVIRONMENT ARTICLE SEC				
	ATIONS (COMA	ARA 26 37 AT A NID CA	3MAD 96 17 N9 EMD E1	DESCRIPTION
THE CODE OF MARYLAND REGUL				KOSION
AND SEDIMENT CONTROL AND ST				KOSION
				KOSION
				ROSION

# OWNER'S / DEVELOPER'S CERTIFICATION

I/WE HEREBY CERTIFY THAT ALL CLEARING, GRADING, CONSTRUCTION, AND/OR DEVELOPMENT WILL BE DONE PURSUANT TO THIS PLAN AND THAT ANY RESPONSIBLE PERSONNEL INVOLVED IN THE CONSTRUCTION PROJECT WILL HAVE A CERTIFICATE OF ATTENDANCE AT A MARYLAND DEPARTMENT OF THE ENVIRONMENT APPROVED TRAINING PROGRAM FOR THE CONTROL OF EROSION AND SEDIMENT BEFORE BEGINNING THE PROJECT. I/WE HEREBY AUTHORIZE THE RIGHT OF ENTRY FOR PERIODIC ON-SITE EVALUATION BY APPROPRIATE INSPECTION AND ENFORCEMENT AUTHORITY OR THE STATE OF MARYLAND, DEPARTMENT OF THE ENVIRONMENT. I/WE HEREBY CERTIFY THAT STORMWATER MANAGEMENT FACILITIES WILL BE MAINTAINED IN ACCORDANCE WITH APPROVED

OWNER/DEVELOPER SIGNATURE

PRINTED NAME

RESPONSIBLE PERSONNEL CERTIFICATION NO.

PRINTED NAME AND TITLE


# US COAST GUARD GENERAL NOTES:

- 1. THE EXISTING UTILITIES AND OBSTRUCTION SHOWN ARE FROM THE BEST AVAILABLE RECORDS AND SHALL BE VERIFIED BY THE CONTRACTOR TO HIS SATISFACTION PRIOR TO CONSTRUCTION. NECESSARY PRECAUTIONS SHALL BE TAKEN BY THE CONTRACTOR TO PROTECT EXISTING SERVICES AND MAINS. ANY DAMAGE TO THEM SHALL BE REPAIRED IMMEDIATELY AT HIS OWN EXPENSE
- 3. IT SHALL BE DISTINCTLY UNDERSTOOD THAT FAILURE TO MENTION SPECIFICALLY ANY WORK WHICH WOULD NATURALLY BE REQUIRED TO COMPLETE THE PROJECT SHALL NOT RELIEVE THE CONTRACTOR OF HIS RESPONSIBILITY TO COMPLETE SUCH WORK.
- 4. THE CONTRACTOR SHALL CALL "MISS UTILITY" (1-800-257-7777) A MINIMUM OF 48 HOURS IN ADVANCE OF ANY EXCAVATION, BORING, PILE DRIVING AND/OR DIGGING FOR THE LOCATION OF UTILITY LINES.
- 5. BASE TOPOGRAPHY AND 2 FOOT CONTOURS OBTAINED FROM ANNE ARNDEL COUNTY (BASED ON LIDAR) 6. THE CONTRACTOR MUST CONSULT THE GOVERNMENT CONTRACTING OFFICER (VIA RFI) CONCERNING ANY CONTENT WITHIN THESE DRAWINGS / DOCUMENTS THAT REQUIRE FURTHER CLARIFICATION TO PROCEED WITH THE FIELD WORK. PROCEEDING WITHOUT CLARIFICATION FROM THE CONTRACTING OFFICER WILL RENDER THE
- CONTRACTOR LIABLE FOR ALL WORK PERFORMED INCORRECTLY. 7. REFER TO WRITTEN SPECIFICATIONS FOR ANY INFORMATION NOT INCLUDED IN THESE DRAWINGS; IF INFORMATION IS NOT INCLUDED BY SPECIFICATIONS REFER TO CONTRACTING OFFICER FOR CLARIFICATION.
- 8. ALL WORK PERFORMED MUST BE COMPLETED TO ICC CODE STANDARDS INCLUDING IBC, IMC, AND IPC; IF THERE IS ANY CONFLICT BETWEEN THE DOCUMENTS AND THE CODE STANDARDS. THE CODE STANDARDS SHOULD PREVAIL, HOWEVER THE COR AND CONTRACTING OFFICER SHOULD BE NOTIFIED PRIOR TO PROCEEDING. 9. CONTRACTOR IS RESPONSIBLE TO PATCH / REPAIR ALL ROADWAY, SIDEWALK, CURB / GUTTER OR ANY SURROUNDINGS AREAS DISTURBED OR DAMAGED BY
- CONSTRUCTION WITHIN THE PROJECT PARAMETERS. 10. ALL WORK PERFORMED IS SUBJECT TO APPROVAL INSPECTION BY THE CONTRACTING OFFICER REPRESENTATIVE AND/OR APPOINTED GOVERNMENT PERSONNEL
- FOR WORK TO BE DEEMED CORRECT DURING THE PROCESS OF CONSTRUCTION AND UPON COMPLETION. 11. THE CONTRACTOR IS RESPONSIBLE FOR COORDINATING ROADWAY ACCESS FOR ALL SURROUNDING BUSINESSES / USCG YARD OPERATIONS THROUGH THE DURATION OF THE PROJECT.

CONSULTANTS

TETRA TECH, INC 240 CONTINENTAL DRIVE, SUITE 240 NEWARK, DE 19713

U. S. COAST GUARD YARD FACILITIES ENGINEERING

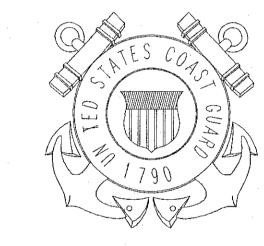

US COAST GUARD YARD 2401 HAWKINS POINT ROAD, MS 10 BALTIMORE, MARYLAND 21226

	·		
		·	
	10/26/18	ISSUED FOR PERMIT	
MARK	DATE	DESCRIPTION	

A/E PROJECT NO: CAD FILE NAME FACILITIES ENGINEERING DRAWN BY: D.T.B. EDITED BY D.T.B. CHECKED BY: D. ANDRESE

SCALE: AS NOTED PLOT SCALE: 1:1

CPOP REPAIR WEST WHARF CG YARD (FY19) WEST BULKHEAD AREA BALTIMORE MARYLAND

GENERAL

REVIEWED BY: REVIEWED BY: LT. P. CONSTANTINO D. ANDRESE PROJECT ENG. DESIGN SUPV.

10/26/18 DATE PROJECT NUMBER DRAWING NUMBER

YWBW8617883G 8617883 DISCIPLINE/SHT NO

# CPOP REPAIR WEST WHARF CONSULTANTS CG YARD (FY19) TETRA TECH, INC 240 CONTINENTAL DRIVE, SUITE 240 NEWARK, DE 19713 STEAM LINES TO BE ABANDONED ..... AT U.S. COAST GUARD YARD / BALTIMORE, MARYLAND CONDENSATE LINES TO BE ABANDONED ..... \_\_\_\_\_\_ **USCG PROJECT NO. 8617883 / MDE PROJECT NO. 18-SF-0000?** LIMIT OF DISTURBANCE (EXCAVATION) ..... **CONSULTANT'S CERTIFICATION** PERVIOUS GRAVEL AREAS THE DEVELOPER'S PLAN TO CONTROL SILT AND EROSION IS ADEQUATE TO CONTAIN THE SILT AND EROSION ON THE PROPERTY COVERED BY THE PLAN. I CERTIFY THAT THIS PLAN OF EROSION AND SEDIMENT CONTROL REPRESENTS A PRACTICAL AND WORKABLE PLAN BASED ON MY PERSONAL KNOWLEDGE OF THIS SITE, AND WAS PREPARED IN ACCORDANCE WITH THE REQUIREMENTS OF THE AASCD PLAN SUBMITTAL GUIDELINES AND THE CURRENT MARYLAND STANDARDS AND SPECIFICATIONS FOR SOIL EROSION AND SEDIMENT CONTROL PLAN WITH U.S. COAST GUARD YARD 2401 HAWKINS POINT RD BALTIMORE, MD 21226 THE OWNER/DEVELOPER. PROJECT SITE MAP LEGEND SCALE: N.T.S. SCALE: 1" = 250' U. S. COAST GUARD YARD FACILITIES ENGINEERING BALTIMORE, MARYLAND US COAST GUARD YARD 2401 HAWKINS POINT ROAD, MS 10 BALTIMORE, MARYLAND 21226 EXISTG. CONCRETE REMOVE EXISTG. PAD 50' X 50' CONDENSATE LINES SEE SHEET C-03 FOR EROSION AND SEDIMENT CONTROLS BOLLARDS AND 3620 SF.) IS FOR REPLACE WITH EXISTG, TIMBER SEA ABANDONED STEAM AND CONDENSATE WALL BELOW MATERIALS AND LINES TO BE CUT AND REMOVED IN ANY JOB SITE USE 10/26/18 ISSUED FOR PERMIT -EXCAVATE ARDUND DATE DESCRIPTION HYDRANTS, ETC. (TYP.) A/E PROJECT NO: CAD FILE NAME: DESIGNED BY: FACILITIES ENGINEERING EDITED BY: D.T.B. CHECKED BY: D. ANDRESE EXCAVATION TO BE EXCAVATION TO BE EXCAVATION TO BE PLOT SCALE: 1:1 SCALE: AS NOTED OPENED AND CLOSED OPENED AND CLOSED OPENED AND CLOSED ONE (APPRX.-10 REPAIRS); (APPROX.-11 REPAIRS) REPAIRS); SEE SHEET CPOP REPAIR WEST WHARF CG YARD (FY19) WEST BULKHEAD AREA BALTIMORE MARYLAND CIVIL PROJECT ENG. DESIGN SUPV. 10/26/18 DATE DRAWING NUMBER PROJECT NUMBER SITE PLAN: ALL AREAS YWBW8617883C0 DISCIPLINE/SHT NO SCALE: 1" = 25'-0"

# ADAMS ST ONCE EXCAVATION IS COMPLETE, INSTALL MARINE GRADE PT 2X12 PLANKS ON TOP OF EXISTING DECK REPLACE ALL EXISTG, 6"X12" DR 6"X6" TIMBER DECK PLANKS WITH VISIBLE SECTION LOSS GREATER THAN 20%; TIMBERS, WITH JUINTS STAGGERED MAXIMUM 125 COMPONENT PCS.) AS INDICATED; PLACE FILTER FABRIC BETWEEN TIMBER LAYERS (TYPICAL FOR ALL AREAS) AREA-D: 1/3 OF TOTAL BASE WORK; SINK HOLE LOCATIONS INDICATE AREAS OF VOID AND CARE SHOULD BE TAKEN DURING EXCAVATION OF THESE AREAS (TYP.) 100'-0" AREA - D SCALE: 1" = 10' - 0" GENERAL SIZE AND LOCATION OF EXISTING SURFACE FAILURE, SIZE PILE LAYOUT BELOW (TYP) SEE SHEET C-03 FOR PILE OF VOIDS IS APPROXIMATE AND REPAIR DETAILS MAY BE LARGER THAN INDICATED - 24" DIA. EXISTG 12X12 -

AREA - C

SCALE: 1" = 10' - 0"

# CPOP REPAIR WEST WHARF CG YARD (FY19)

AT U.S. COAST GUARD YARD / BALTIMORE, MARYLAND USCG PROJECT NO. 8617883 / MDE PROJECT NO. 18-SF-0000?


# CONSULTANT'S CERTIFICATION

THE DEVELOPER'S PLAN TO CONTROL SILT AND EROSION IS ADEQUATE TO CONTAIN THE SILT AND EROSION ON THE PROPERTY COVERED BY THE PLAN. I CERTIFY THAT THIS PLAN OF EROSION AND SEDIMENT CONTROL REPRESENTS A PRACTICAL AND WORKABLE PLAN BASED ON MY PERSONAL KNOWLEDGE OF THIS SITE, AND WAS PREPARED IN ACCORDANCE WITH THE REQUIREMENTS OF THE AASCD PLAN SUBMITTAL GUIDELINES AND THE CURRENT MARYLAND STANDARDS AND SPECIFICATIONS FOR SOIL EROSION AND SEDIMENT CONTROL PLAN WITH THE OWNER/DEVELOPER.

> U.S. COAST GUARD YARD FACILITIES ENGINEERING BALTIMORE, MARYLAND

CONSULTANTS

TETRA TECH, INC 240 CONTINENTAL DRIVE, SUITE 240 NEWARK, DE 19713

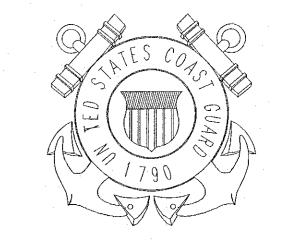

US COAST GUARD YARD 2401 HAWKINS POINT ROAD, MS 10 BALTIMORE, MARYLAND 21226

	10/26/18	ISSUED FOR PERMIT
MARK	DATE	DESCRIPTION

A/E PROJECT NO:

CAD FILE NAME:

DESIGNED BY: FACILITIES ENGINEERING

DRAWN BY: D.T.B.

EDITED BY: D.T.B.

CHECKED BY: D. ANDRESE

SCALE: AS NOTED PLOT SCALE: 1:1

SHEET TITLE

CPOP REPAIR WEST WHARF CG YARD (FY19)
WEST BULKHEAD AREA
BALTIMORE MARYLAN

MORE MARYLAND
04
CIVIL

SITE PLAN DETAILS

REVIEWED BY: REVIEWED BY: REVIEWED BY:

D. ANDRESE LT. P. CONSTANTINO
PROJECT ENG. DESIGN SUPV.

LEDR-JOHN C. ADAMS
APPROVING OFFICER

PROJECT NUMBER

8617883

DISCIPLINE/SHT NO


DRAWING NUMBER
YWBW8617883C02

SHEET 3 OF 7

10/26/18 DATE

AREA - A (STAGING)

SCALE: 1" = 10' - 0"

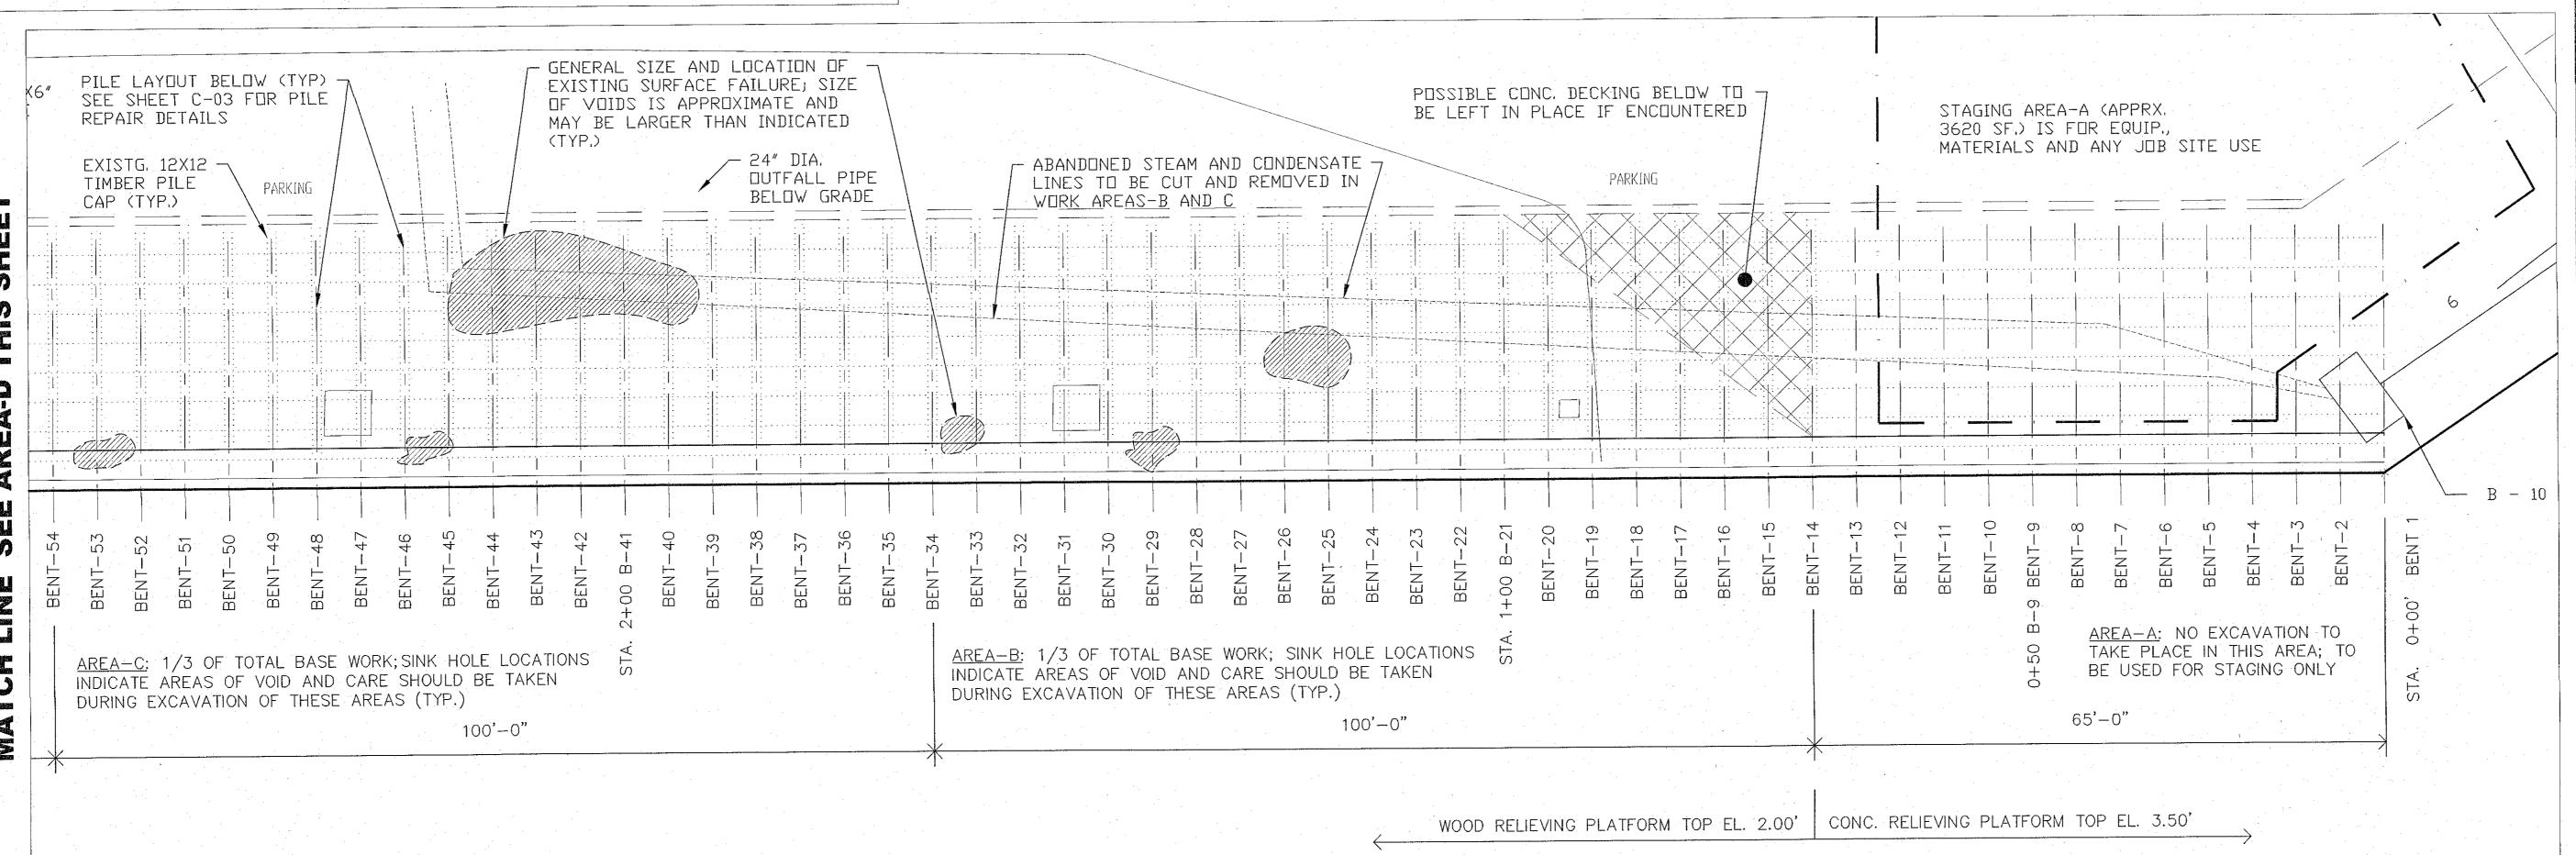

AREA - B

SCALE: 1" = 10' - 0"

# EXISTG. CONCRETE PAD 50' X 50' ADAMS ST - ROAD EDGE AT U.S. COAST GUARD YARD / BALTIMORE, MARYLAND AREA NOT INCLUDED IN CONTRACT: TO BE USED FOR AREA NOT INCLUDED IN CONTRACT; TO BE USED FOR STAGING AND EQUIPMENT ONLY STAGING AND EQUIPMENT ONLY 100'-0" SCALE: 1" = 10' - 0" 128. PILE B, LOSS OF BEARING, 60% LOSS OF BEARING WITH 119. PILE G, NON-BEARING, 100% LOSS OF BEARING WITH 109. PILE D. LOSS OF BEARING, 75% LOSS OF BEARING WITH LIST OF DEFECTS IDENTIFICATION NUMBERS: AREA-B 1-INCH GAP. (REPAIR TYPE #1) 2-INCH GAP. (REPAIR TYPE #1) 1-INCH GAP AND 6-INCH OFF-SET. (REPAIR TYPE #1) 120. PILE G, NON-BEARING, 100% LOSS OF BEARING WITH 129. DECK PLANK, DISCONNECTED, ON SEAWARD SIDE OF 101. PILE A, LOSS OF BEARING, 50% LOSS OF BEARING WITH 110. PILE G. NON-BEARING, 100% LOSS OF BEARING WITH 2-INCH GAP. (REPAIR TYPE #1) LONGITUDINAL BEAM 1 IS DETACHED. (PLANK REPAIR) 2-INCH GAP. (REPAIR TYPE #1) 6-INCH OFF-SET. (REPAIR TYPE #1) 130. PILE CAP, SPLIT, 1/2 IN. W X 12 IN. L. EXTENDS TO 102. PILE A, SECTION LOSS, 8 IN. W X 2 FT. L X 3 IN. D. 111. PILE B. NON-BEARING, 100% LOSS OF BEARING WITH 2-INCH GAP. (REPAIR TYPE #1)

# LIST OF DEFECTS IDENTIFICATION NUMBERS: AREA D

131. PILE B, SHAKE, 12 IN. W X 9 FT. L X 5 IN. D. (REPAIR TYPE #1) 132. PILE C, SHAKE, 12 IN. W X 7 FT. L X 4 IN. D. (REPAIR TYPE #1) 133. PILE CAP, SPLIT, 1/2 IN. W X 12 IN. L. EXTENDS TO THE CENTER OF PILE A. (REPAIR TYPE #1&3)

1/2 -INCH GAP. (REPAIR TYPE #1)

137. PILE CAP, SECTION LOSS, 12 IN. W X 3 IN. L X 3 IN. D.

**CONSULTANT'S CERTIFICATION** 

(REPAIR TYPE #3) 138. PILE A, LOSS OF BEARING, 75% LOSS OF BEARING WITH

3/4 IN. GAP. (REPAIR TYPE #1) 139. PILE B, SPLIT, 1/2 IN. W X 2 IN. L X 12 IN. D. (REPAIR TYPE #2) 140. PILE B. LOSS OF BEARING, 25% LOSS OF BEARING WITH

141. Pile D, LOSS OF BEARING, 60% LOSS OF BEARING WITH 3/4 IN. GAP. (REPAIR TYPE #1)

2-INCH OFF-SET. (REPAIR TYPE #1)

NOTE: FOR DESCRIPTION OF REPAIR TYPES 1,2 AND 3, SEE STATEMENT OF WORK, NEW WORK SECTION 3.2

KNOWLEDGE OF THIS SITE, AND WAS PREPARED IN ACCORDANCE WITH THE REQUIREMENTS OF THE AASCD PLAN SUBMITTAL GUIDELINES AND THE CURRENT MARYLAND STANDARDS AND SPECIFICATIONS FOR SOIL EROSION AND SEDIMENT CONTROL. I HAVE REVIEWED THIS EROSION AND SEDIMENT CONTROL PLAN WITH

**CPOP REPAIR WEST WHARF** 

CG YARD (FY19)

USCG PROJECT NO. 8617883


MDE PROJECT NO. 18-SF-0000?

THE OWNER / DEVELOPER. SIGNATURE FIRM NAME

U. S. COAST GUARD YARD FACILITIES ENGINEERING BALTIMORE, MARYLAND

CONSULTANTS

TETRA TECH, INC 240 CONTINENTAL DRIVE, SUITE 240 NEWARK, DE 19713

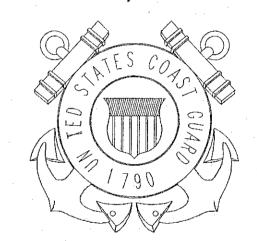

US COAST GUARD YARD 2401 HAWKINS POINT ROAD, MS 10 BALTIMORE, MARYLAND 21226

·		
	10/26/18	ISSUED FOR PERMI
MARK	DATE	DESCRIPTION

ISSUE

A/E PROJECT NO: CAD FILE NAME: DESIGNED BY: FACILITIES ENGINEERING DRAWN BY:

EDITED BY: D.T.B. CHECKED BY: D. ANDRESE

PLOT SCALE: 1:1 SCALE: AS NOTED SHEET TITLE

CPOP REPAIR WEST WHARF CG YARD (FY19)

WEST BULKHEAD AREA **BALTIMORE** 

> 04 CIVIL

MARYLAND

DATE

PILE & PILE CAP REPAIR DETAILS REVIEWED BY: REVIEWED BY: REVIEWED BY: LT. P. CONSTANTINO

PROJECT ENG. DESIGN SUPV.

10/26/18 PROJECT NUMBER DRAWING NUMBER

YWBW8617883C0 8617883 DISCIPLINE/SHT NO

SHEET 4 OF

107. PILE G, 50% LOSS OF BEARING WITH 6-INCH OFF-SET. 2-INCH GAP. (REPAIR TYPE #1) (REPAIR TYPE #1) 108. LONG BEAM 1, LOSS OF BEARING, 50% LOSS OF

112. PILE C. NON-BEARING, 100% LOSS OF BEARING WITH

113. PILE E, LOSS OF BEARING 50% LOSS OF BEARING WITH

6-INCH OFF-SET. (REPAIR TYPE #1)

3-INCH GAP AND 5-INCH OFF-SET. (REPAIR TYPE #1)

(REPAIR TYPE #2)

103. PILE B, DISCONNECTED FROM PILE CAP AND LEANING

"D", BENT 15 FACING BENT 16. (REPAIR TYPE #1)

104. PILE CAP, MISSING SPLICE PLATE, BETWEEN PILE C AND

AGAINST PILE A. (REPAIR TYPE #1)

LIST OF DEFECTS IDENTIFICATION NUMBERS: AREA-C

121. PILE D, NON-BEARING, 100% LOSS OF BEARING WITH 2-INCH GAP. (REPAIR TYPE #1)


122. PILE G, NON-BEARING, 100% LOSS OF BEARING WITH 2-INCH GAP. (REPAIR TYPE #1)


CENTER OF PILE A. (REPAIR TYPE #1&3)

136. PILE A, LOSS OF BEARING, 60% LOSS OF BEARING WITH


105. PILE F, DISCONNECTED FROM PILE CAP AND LEANING 114. PILE F, NON-BEARING, 100% LOSS OF BEARING WITH 123. DECK PLANKS, DEBRIS, TIMBER LODGED BETWEEN AGAINST PILE E. (REPAIR TYPE #1) 2-INCH GAP. (REPAIR TYPE #1) BENT 35, PILE F AND BENT 36, PILE G. (PLANK REPAIR) 106. PILE G, 50% LOSS OF BEARING WITH 1-INCH GAP AND 115. PILE H, LOSS OF BEARING, 30% LOSS OF BEARING WITH 124. PILE CAP, ROT/FUNGAL DECAY, 5 IN. W X 8 IN. H X 6 IN. D. 134. PILE B, LOSS OF BEARING 60% LOSS OF BEARING WITH 3-INCH OFF-SET. (REPAIR TYPE #2) 6-INCH OFF-SET. (REPAIR TYPE #1) 1-INCH GAP. (REPAIR TYPE #1) (REPAIR TYPE #3) 116. PILE G. NON-BEARING, 100% LOSS OF BEARING WITH 125. PILE E, SPLIT, 2 IN W X 4 FT. L X 12 IN. D. (REPAIR TYPE #2) 135. PILE A, LOSS OF BEARING, 50% LOSS OF BEARING WITH 126. PILE CAP, SPLIT, 1/2 IN. W X 12 IN. L. EXTENDS TO 117. PILE G, NON-BEARING, 100% LOSS OF BEARING WITH CENTER OF PILE A. (REPAIR TYPE #1&3) BEARING WITH 1-INCH GAP BETWEEN PILE CAP AND 2-INCH GAP. (REPAIR TYPE #1) 1-INCH GAP. (REPAIR TYPE #1) 127. PILE C. LOSS OF BEARING, 75% LOSS OF BEARING WITH LONGITUDINAL BEAM 1. (REPAIR TYPE #1) 118. PILE F, NON-BEARING, 100% LOSS OF BEARING WITH 4-INCH OFF-SET. (REPAIR TYPE #1) 2-INCH GAP. (REPAIR TYPE #1)


ADAMS ST GENERAL SIZE AND LOCATION OF PILE LAYOUT BELOW (TYP) ONCE EXCAVATION IS COMPLETE; EXISTING SURFACE FAILURE; SIZE SEE SHEET C-03 FOR PILE REPLACE ALL EXISTG, DAMAGED POSSIBLE CONC, DECKING BELOW TO -OF VOIDS IS APPROXIMATE AND REPAIR DETAILS BE LEFT IN PLACE IF ENCOUNTERED 6"X12" OR 6"X6" TIMBER DECK MAY BE LARGER THAN INDICATED PLANKS (WITH VISIBLE GAPS (TYP.) +2"; TYPICAL FOR ALL AREAS) EXISTG. 12X12 -- 24″ DIA. OUTFALL PIPE (105) TIMBER PILE PARKING EXISTG TIMBER SEA WALL CAP (TYP.) BELOW GRADE EXISTG, CONC. QUAY WALL ABOVE AREA-D: 1/3 OF TOTAL BASE WORK; EXCAVATE ENTIRE AREA-C: 1/3 OF TOTAL BASE WORK; EXCAVATE ENTIRE AREA-B: 1/3 OF TOTAL BASE WORK; EXCAVATE ENTIRE AREA AREA DOWN TO TIMBER RELIEF PLANKING (WITH CARE OF AREA DOWN TO TIMBER RELIEF PLANKING (WITH CARE OF DOWN TO TIMBER RELIEF PLANKING (WITH CARE OF EXISTING EXISTING UTILITIES) AND MAKE REPAIRS AS STATED ABOVE EXISTING UTILITIES) AND MAKE REPAIRS AS STATED ABOVE UTILITIES) AND MAKE REPAIRS AS STATED ABOVE WITH WITH REPLACEMENT OF PLANKING AS INDICATED. WITH REPLACEMENT OF PLANKING AS INDICATED. REPLACEMENT OF PLANKING AS INDICATED. AREA - D AREA - C AREA - B 100'-0" 100'-0" 100'-0" SCALE: 1" = 10' - 0"

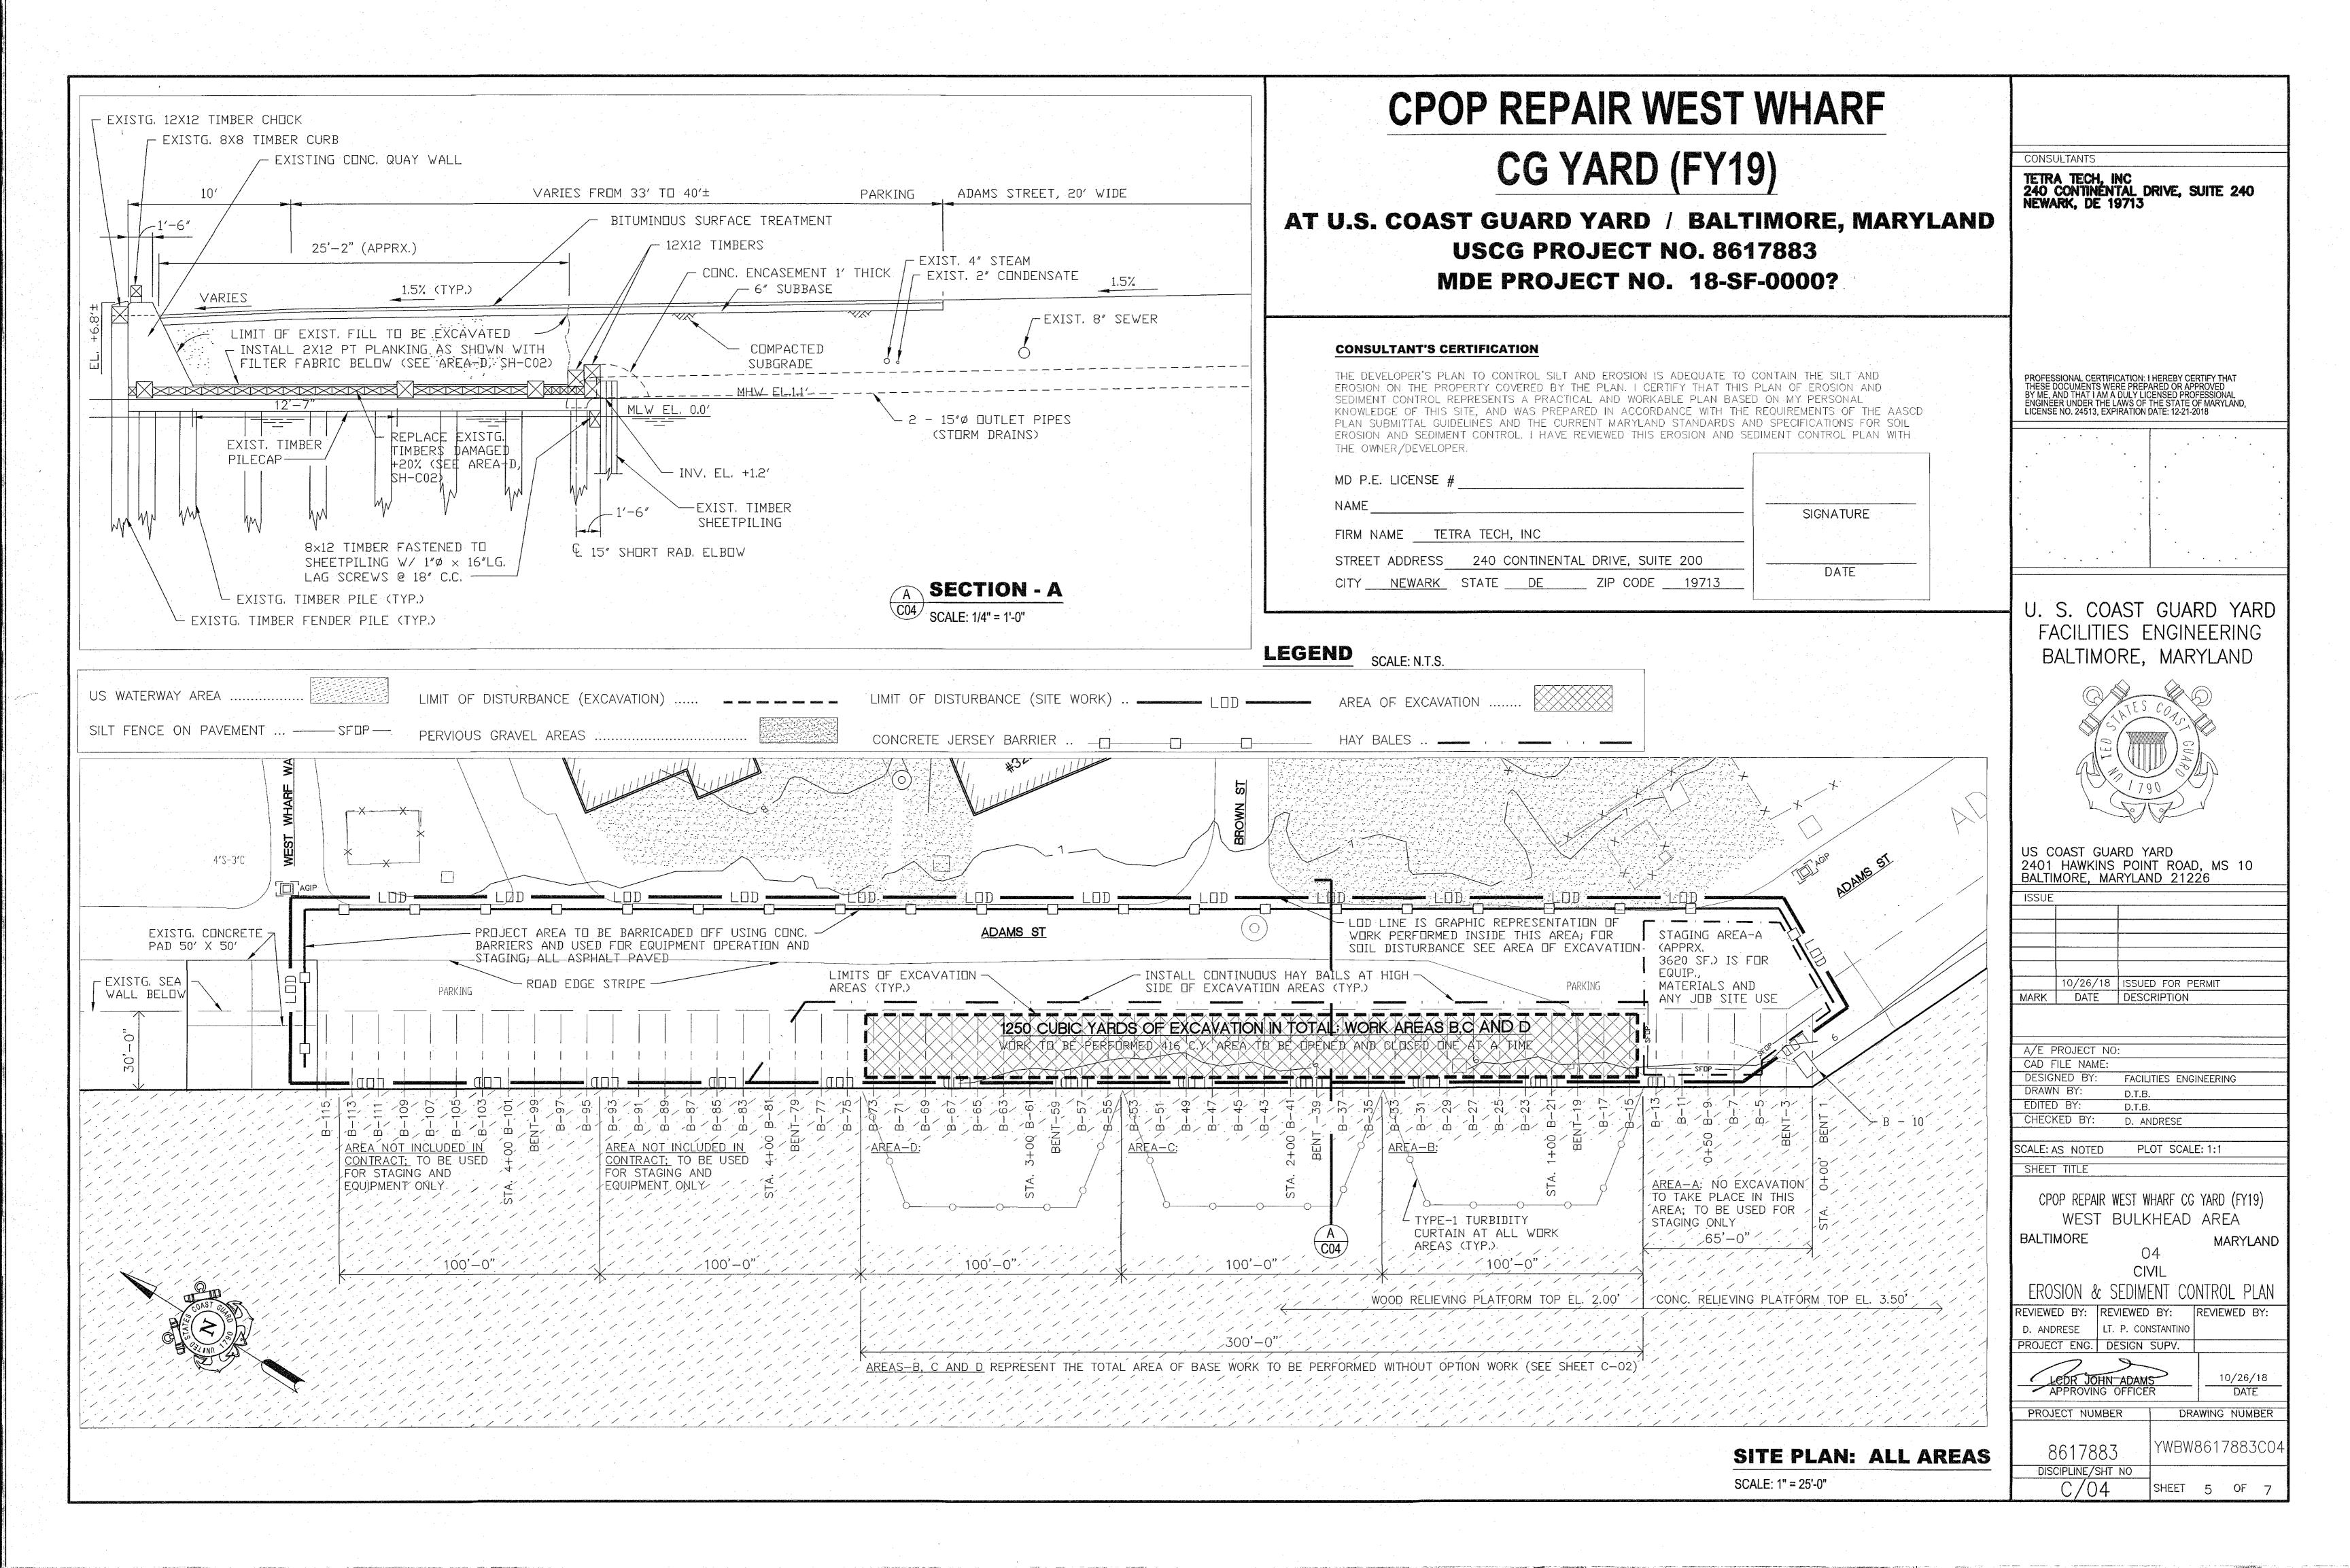

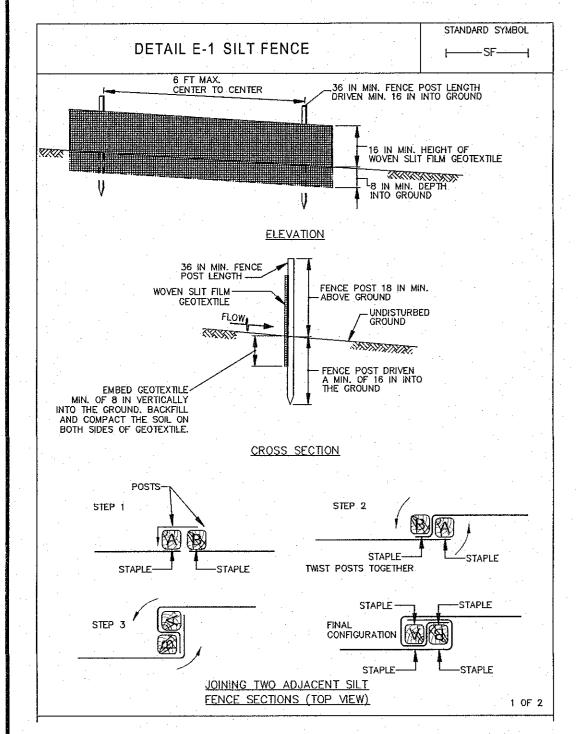

DETAIL: SILT FENCE SCALE: N.T.S.

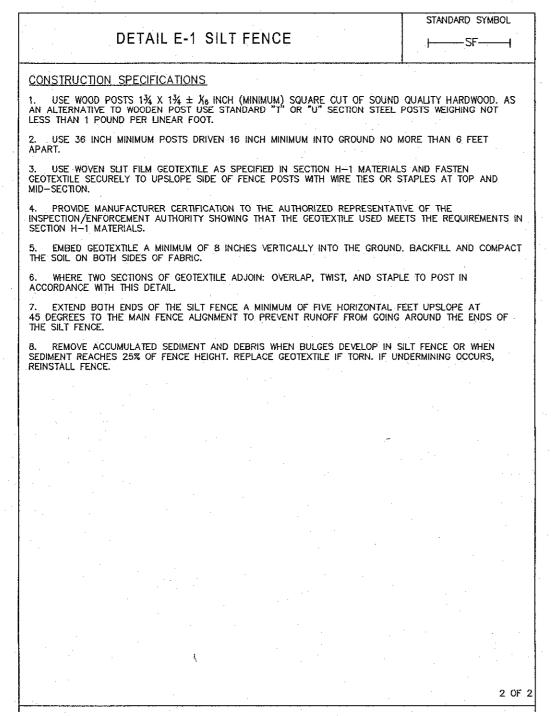

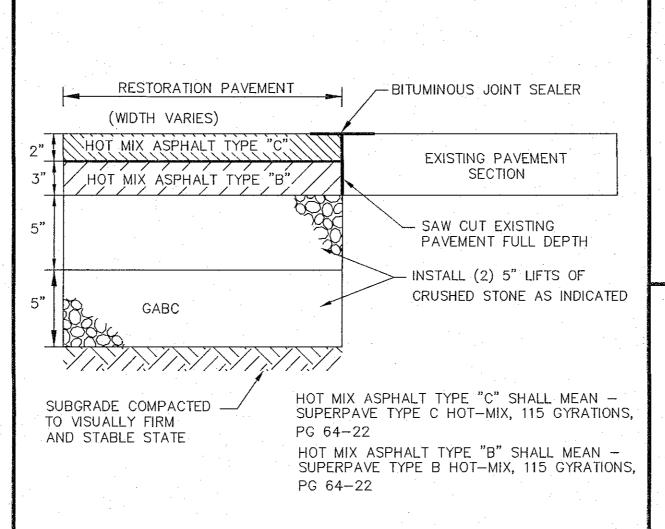

# DETAIL: PAVEMENT RESTORATION

SCALE: N.T.S.

# CPOP REPAIR WEST WHARF CG YARD (FY19)

AT U.S. COAST GUARD YARD / BALTIMORE, MARYLAND USCG PROJECT NO. 8617883
MDE PROJECT NO. 18-SF-000?

# CONSULTANT'S CERTIFICATION

THE DEVELOPER'S PLAN TO CONTROL SILT AND EROSION IS ADEQUATE TO CONTAIN THE SILT AND EROSION ON THE PROPERTY COVERED BY THE PLAN. I CERTIFY THAT THIS PLAN OF EROSION AND SEDIMENT CONTROL REPRESENTS A PRACTICAL AND WORKABLE PLAN BASED ON MY PERSONAL KNOWLEDGE OF THIS SITE, AND WAS PREPARED IN ACCORDANCE WITH THE REQUIREMENTS OF THE AASCD PLAN SUBMITTAL GUIDELINES AND THE CURRENT MARYLAND STANDARDS AND SPECIFICATIONS FOR SOIL EROSION AND SEDIMENT CONTROL. I HAVE REVIEWED THIS EROSION AND SEDIMENT CONTROL PLAN WITH THE OWNER/DEVELOPER.

D P.E. LICENSE #	!					
AME		 		<del></del>		CIONATURE
VIAIT		 · · ·	<u> </u>	<u></u> `	SIGNATURE	
RM NAME		 				
TREET ADDRESS				·		· · · · · · · · · · · · · · · · · · ·
ITY	STATE	7IP COD	)F		DATE	


ANCHOR EACH BALE WITH TWO 2"x2" STAKES DRIVEN MINIMUM 2' INTO GROUND

CONSULTANTS

TETRA TECH, INC 240 CONTINENTAL DRIVE, SUITE 240 NEWARK, DE 19713

PROFESSIONAL CERTIFICATION: I HEREBY CERTIFY THAT THESE DOCUMENTS WERE PREPARED OR APPROVED BY ME, AND THAT I AM A DULY LICENSED PROFESSIONAL ENGINEER UNDER THE LAWS OF THE STATE OF MARYLAND, LICENSE NO. 24513, EXPIRATION DATE: 12-21-2018

U. S. COAST GUARD YAR
FACILITIES ENGINEERING

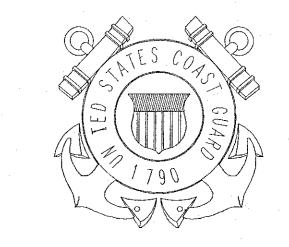

US COAST GUARD YARD 2401 HAWKINS POINT ROAD, MS 10 BALTIMORE, MARYLAND 21226

•			
		10/26/18	ISSUED FOR PERMIT
	MARK	DATE	DESCRIPTION
	·		
		•	
	A/E P	ROJECT NO	:
		ILE NAME:	
		NED BY:	FACILITIES ENGINEERING
₹ .	DRAW		D.T.B.
	EDITED		D.T.B.
	CHECK	(ED BY:	D. ANDRESE
		···	
	SCALE: A	S NOTED	PLOT SCALE: 1:1
	SHEET	TITLE	
	CP(	)P REPAIR W	/EST_WHARF_CG_YARD_(FY19)
		WEST E	BULKHEAD AREA
	BALTII	MORE	MARYLAND
			04
_		•	CIVIL
•	EROSI	ON & SE	DIMENT CONTROL DETAILS

REVIEWED BY: REVIEWED BY:

PROJECT ENG. DESIGN SUPV.

LT. P. CONSTANTING

D. ANDRESE

PROJECT NUMBER

8617883

DISCIPLINE/SHT NO

REVIEWED BY:

10/26/18

DRAWING NUMBER

YWBW8617883C0

SHEET 6 OF 7

DATE


BEGINNING OF EXCAVATION AT —HAY BALE THIS POINT AND OUT TO EXIST. CONCRETE SLAB-ON-GRADE QUAY WALL, WEST TO BE DEMOLISHED AND REMOVED ADAMS ST. **DETAIL: HAY BALES** SCALE: N.T.S. 1. CONTRACTOR SHALL REMOVE EXISTING ASPHALT AS NECESSARY TO INSTALL HAY BALES. 2. CONTRACTOR SHALL SUBMIT HAY BALE LAYOUT PLAN FOR REVIEW AND APPROVAL. 3. HAY BALE SHALL EXTEND A MINIMUM OF 3" BELOW EXISTING GRADE. -WATER SURFACE FOLD TOP AND BOTTOM TO -GET FOUR THICKNESSES OF GROMMETS AT 2' O.C. GROMMET TO CONNECT SECTIONS OR WEIGH


**DETAIL: TYPE-1 TURBIDITY CURTAIN** 

HT T	AS TOP AND BOTTOM FOLD	MOO	
A 10'-0"	MUDLINE - MUDLINE		
LOAD CHAIN OR WEIGHT  NOTE: TYPE 1	ELEVATION VIEW  TURBIDITY BARRIER TO FIT EXISTING	3" GALVANIZED  DETAIL - 1  2" GALVANIZED PI  STABILIZATION PO EMBEDDED SUFFICE	IPE TIDAL &
CONDITIC	ON AS APPROVED BY THE ENGINEER.	PLAN VIEW	ELVIL 1
(4) "4" ADA ON CO MANIA	3%" DIA. ALUM. ROD	-2"	GALVANIZED PIPE  COTTER PIN LOCATION ABOVE  RECORD STORM TIDE
(1)—#4" NYLON OR MANILA ROPE TO BE SLACK IN— FINAL POSITION	COTTER PIN THRU ROD  PLASTIC SHEET OR ALTERNATE  BRASS GROMENT	3" GALVANIZEDRING	
SLIPKNOT TOP & BOTTOM	HOOK (CLOSE TO PREVENT LOSS)		UDLINE
	WEIGHT  SECTION B-B		
	NATE MAY BE FASTENED TO STAKES DRIVE IN IN LIEU OF FLOATS AND WEIGHTS.	N <u>DETAIL - 1</u>	

SCALE: N.T.S.

# STANDARD SYMBOL DETAIL E-2 SILT FENCE ON PAVEMENT ├---SF0P-----BEWTWEEN 2 IN x 4 IN ACROSS TOP OF STONE FRAME -WOVEN SLIT FILM GEOTEXTILE SILT FENCE JOINING ADJACENT SECTIONS 2 IN x 4 IN— GEOTEXTILE -MASTIC SEAL CONSTRUCTION SPECIFICATIONS SECTION A-A 1. USE NOMINAL 2 INCH X 4 INCH LUMBER. 2. USE WOVEN SLIT FILM GEOTEXTILE, AS SPECIFIED IN SECTION H-1 MATERIALS. PROVIDE MANUFACTURER CERTIFICATION TO THE AUTHORIZED REPRESENTATIVE OF THE INSPECTION/ENFORCEMENT AUTHORITY SHOWING THAT THE GEOTEXTILE USED MEETS THE REQUIREMENTS IN SECTION H-1 MATERIALS. 4. SPACE UPRIGHT SUPPORTS NO MORE THAN 10 FEET APART. 5. PROVIDE A TWO FOOT OPENING BETWEEN EVERY SET OF SUPPORTS AND PLACE STONE IN THE OPENING OVER GEOTEXTILE. 6. KEEP SILT FENCE TAUT AND SECURELY STAPLE TO THE UPSLOPE SIDE OF UPRIGHT SUPPORTS. EXTEND GEOTEXTILE UNDER 2x4. WHERE TWO SECTIONS OF GEOTEXTILE ADJOIN: OVERLAP, FOLD, AND STAPLE TO POST IN ACCORDANCE WITH THIS DETAIL. ATTACH LATHE. PROVIDE A MASTIC SEAL BETWEEN PAVEMENT, GEOTEXTILE, AND 2×4 TO PREVENT SEDIMENT-LADEN WATER FROM ESCAPING BENEATH SILT FENCE INSTALLATION. 9. SECURE BOARDS TO PAVEMENT WITH 40D 5 INCH MINIMUM LENGTH NAILS. 10. REMOVE ACCUMULATED SEDIMENT AND DEBRIS WHEN BULGES DEVELOP IN SILT FENCE OR WHEN SEDIMENT REACHES 25% OF FENCE HEIGHT. REPLACE GEOTEXTILE IF TORN, MAINTAIN WATER TIGHT SEAL ALONG BOTTOM. REPLACE STONE IF DISPLACED.

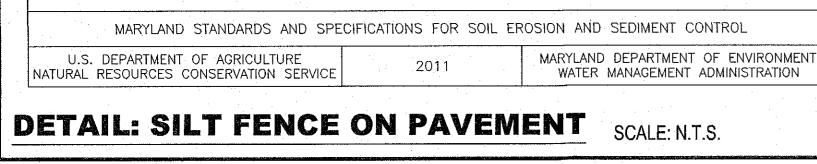

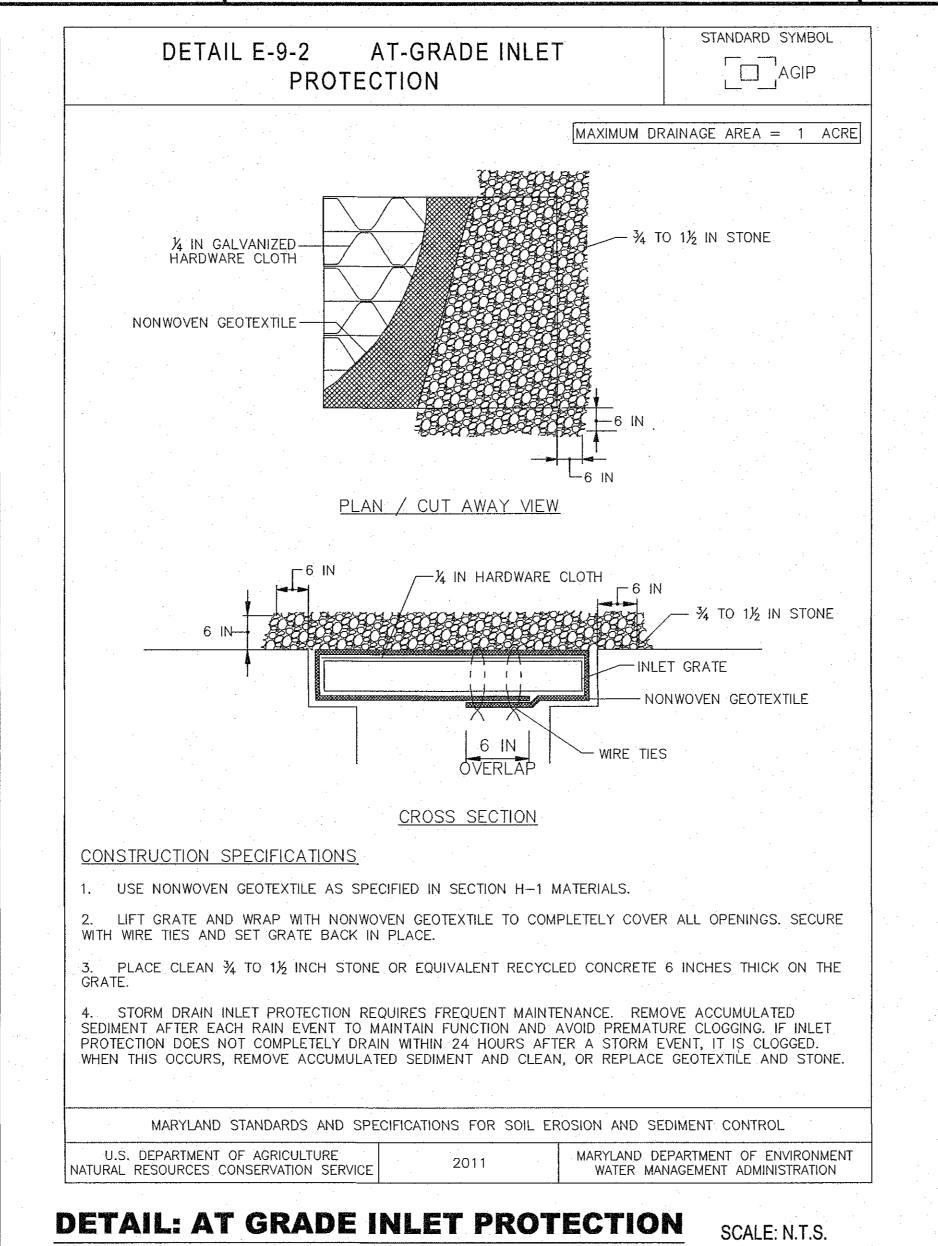

# STANDARD RESPONSIBILITY NOTES

1. I (WE) CERTIFY THAT:

a. ALL DEVELOPMENT AND CONSTRUCTION WILL BE DONE IN ACCORDANCE WITH THIS CONTROL PLAN, AND FURTHER, AUTHORIZE THE RIGHT OF ON-SITE EVALUATION BY THE ANNE ARUNDEL SOIL (AASCD) BOARD OF SUPERVISORS OR THEIR AUTHORIZED AGENTS.

b. ANY RESPONSIBLE PERSONNEL INVOLVED IN THE CONSTRUCTION PROJECT WILL HAVE A OF ATTENDANCE FROM THE MARYLAND DEPARTMENT OF THE ENVIRONMENT'S APPROVED TRAINING PROGRAM FOR THE CONTROL OF EROSION AND SEDIMENT BEFORE BEGINNING THE PROJECT.

RESPONSIBLE PERSONNEL ON SITE: \_\_\_\_DERRICK JOSEY \_RPC009205\_\_\_

CIF APPLICABLE, THE APPROPRIATE ENCLOSURE WILL BE CONSTRUCTED AND MAINTAINED ON SEDIMENT BASIN(S) INCLUDED IN THIS PLAN. SUCH STRUCTURE(S) WILL BE IN COMPLIANCE WITH THE ANNE ARUNDEL COUNTY CODE.

2. THE DEVELOPER IS RESPONSIBLE FOR THE ACQUISITION OF ALL EASEMENTS, RIGHT, AND/OR RIGHTS-OF-WAY THAT MAY BE REQUIRED FOR THE EROSION AND SEDIMENT CONTROL PRACTICES, STORM WATER MANAGEMENT PRACTICES AND THE DISCHARGE OF STORM WATER ONTO OR ACROSS ADJACENT OR DOWNSTREAM PROPERTIES INCLUDED IN

3.FOR INITIAL SOIL DISTURBANCE OR RE-DISTURBANCE, PERMANENT AND/OR TEMPORARY STABILIZATION PER THE AASCD VEGETATIVE ESTABLISHMENT SHALL BE COMPLETED WITHIN THREE CALENDAR DAYS FOR THE SURFACE OF ALL CONTROLS, DIKES, SWALES, DITCHES, PERIMETER SLOPES AND ALL SLOPES GREATER THAN 3 HORIZONTAL TO 1 VERTICAL (3:1); AND SEVEN DAYS FOR ALL OTHER DISTURBED OR GRADED AREAS ON THE PROJECT SITE. 4. THE GRADING AND SEDIMENT CONTROL APPROVAL ON THIS PLAN EXTENDS ONLY TO

THOSE AREAS WITHIN THE LIMITS OF DISTURBANCE

5. THE APPROVAL OF THIS PLAN FOR EROSION AND SEDIMENT CONTROL DOES NOT RELIEVE THE DEVELOPER/CONSULTANT FROM COMPLYING WITH FEDERAL, STATE OR COUNTY REQUIREMENTS PÉRTAINING TO ENVIRONMENTAL ISSUES

6. THE DEVELOPER MUST REQUEST THAT THE EROSION AND SEDIMENT CONTROL INSPECTOR APPROVE WORK COMPLETED IN ACCORDANCE WITH THE APPROVED EROSION AND SEDIMENT CONTROL PLAN, THE GRADING OR BUILDING PERMIT, AND THE ORDINANCE

7. ALL MATERIAL SHALL BE TAKEN TO A SITE WITH AN APPROVED EROSION AND SEDIMENT CONTROL PLAN.

AND SEDIMENT CONTROLS PRIOR TO PROCEEDING WITH ANY OTHER EARTH DISTURBANCE OR GRADING. OTHER BUILDING OR GRADING INSPECTION APPROVALS MAY NOT BE INSPECTOR IS GIVEN. INSPECTION AND PERMITS MAY ALSO REQUIRE THAT AN INSPECTION AND CERTIFICATION OF THE INSTALLATION OF SEDIMENT CONTROL ALSO BE PERFORMED BY A DESIGN PROFESSIONAL PRIOR TO CONSTRUCTION COMMENCING.

9.APPROVAL FROM THE INSPECTOR MUST BE REQUESTED ON FINAL STABILIZATION OF ALL

SITES PRIOR TO REMOVAL OF EROSION AND SEDIMENT CONTROLS.

10. EXISTING TOPOGRAPHY MUST BE FIELD VERIFIED BY RESPONSIBLE PERSONNEL TO THE SATISFACTION OF THE SEDIMENT CONTROL INSPECTOR PRIOR TO COMMENCING WORK.

	10/26/18
SIGNATURE OF DEVELOPER/OWNER	DATE
NAME:JOHN ADAMS	
TITLE: FACILITY ENGINEER	
AFFILIATION: USCG YARD	
ADDRESS: 2401 HAWKINS POINT ROAD; CURTIS E	BAY, MD 21226; BLDG-4
TELEPHONE NUMBER: 410-636-4097	
FMAIL ADDRESS JOHN.C.ADAMS2@USCG.MIL	

# STANDARD STABILIZATION NOTE

FOLLOWING INITIAL SOIL DISTURBANCE OR REDISTURBANCE, PERMANENT OR TEMPORARY STABILIZATION SHALL BE COMPLETED WITHIN THREE (3) CALENDAR DAYS AS TO THE SURFACE OF ALL PERIMETER CONTROLS, DIKES, SWALES, DITCHES, PERIMETER SLOPES, AND ALL SLOPES STEEPER THAN 3 HORIZONTAL TO 1 VERTICAL (3:1); AND SEVEN (7) DAYS AS TO ALL OTHER DISTURBED OR GRADED AREAS ON THE PROJECT SITE NOT UNDER ACTIVE GRADING.

# NOTES:

1. CONTRACTOR IS RESPONSIBLE TO ENSURE THAT ALL MD. DEPT. OF THE ENVIRONMENT AND OSHA. REGULATIONS ARE MET WITH RESPECT TO TRENCHING SIZE RATIOS, SAFETY AND **ENVIRONMENTAL PROTECTION MEASURES:** PROTECT ALL STORM WATER INLETS AND/OR CATCH BASINS WITHIN 60' OF ANY EARTH DISTURBANCE.

- 2. TOTAL VOLUME OF EARTH TO BE DISTURBED IN ALL WORK AREA-A WILL BE APPROXIMATELY 2330 CUBIC YARDS BASED ON (5) AREAS 500'X26'X4.5'D
- 3. TOTAL VOLUME OF EARTH TO BE DISTURBED IN EACH WORK AREA WILL BE APPROXIMATELY 466 CUBIC YARDS BASED ON EXCAVATION 100'X26'X4.5'
- 4. SEE SITE ANALYSIS CALCULATIONS ON SHEET T-01 FOR TOTAL SITE DISTURBANCE VOLUMES.

# CPOP REPAIR WEST WHARF CG YARD (FY19)

AT U.S. COAST GUARD YARD / BALTIMORE, MARYLAND USCG PROJECT NO. 8617883 MDE PROJECT NO. 18-SF-000?

# **CONSULTANT'S CERTIFICATION**


E DEVELOPER'S PLAN TO CONTROL SILT AND EROSION IS ADEQUATE TO CONTAIN THE SILT AND EROSION ON THE PROPERTY COVERED BY THE PLAN. I CERTIFY THAT THIS PLAN OF EROSION AND SEDIMENT CONTROL REPRESENTS A PRACTICAL AND WORKABLE PLAN BASED ON MY PERSONAL KNOWLEDGE OF THIS SITE, AND WAS PREPARED IN ACCORDANCE WITH THE REQUIREMENTS OF THE AASCD PLAN SUBMITTAL GUIDELINES AND THE CURRENT MARYLAND STANDARDS AND SPECIFICATIONS FOR SOIL EROSION AND SEDIMENT CONTROL I HAVE REVIEWED THIS EROSION AND SEDIMENT CONTROL PLAN WITH THE OWNER / DEVELOPER.

MD P.E. LICENSE #	#		
NAME			SIGNATURE
FIRM NAME			
STREET ADDRESS_			DATE
CITY	STATE	ZIP CODE	

# U. S. COAST GUARD YARD FACILITIES ENGINEERING BALTIMORE, MARYLAND

CONSULTANTS

TETRA TECH, INC 240 CONTINENTAL DRIVE, SUITE 240 NEWARK, DE 19713

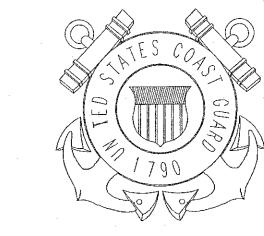

US COAST GUARD YARD 2401 HAWKINS POINT ROAD, MS 10

1
ISSUED FOR PERMIT
DESCRIPTION
DECOMM HON
):
FACILITIES ENGINEERING
D.T.B.
D.T.B.
D. ANDRESE
PLOT SCALE: 1:1
WEST WHARF CG YARD (FY
WHARF AREA

MARYLAND

**BALTIMORE** 

CIVIL & SEDIMENT CONTROL NOTES REVIEWED BY: REVIEWED BY: REVIEWED BY:

04

D. ANDRESE LT. P. CONSTANTINO PROJECT ENG. DESIGN SUPV. \_\_\_\_ 0

LCDR_JOHN_ADAMS		10/26/18
LCDR JOHN ADAMS APPROVING OFFICE	₹	DATE
PROJECT NUMBER	DRA	WING NUMBER

YWBW8617883C06 8617883 DISCIPLINE/SHT NO SHEET 7 OF 7

# STANDARD NOTES FOR WORKING IN NONTIDAL, WETLAND BUFFERS, WATERWAYS AND 100 YEAR FLOODPLAINS

NO EXCESS FILL, CONSTRUCTION MATERIAL, OR DEBRIS SHALL BE STOCKPILED OR STORED IN NONTIDAL WETLANDS, NONTIDAL WETLAND BUFFERS, WATERWAYS, OR THE 100-YEAR FLOODPLAIN.

2) PLACE MATERIALS IN A LOCATION AND MANNER WHICH DOES NOT ADVERSELY IMPACT SURFACE OR SUBSURFACE WATER FLOW INTO OR OUT OF NONTIDAL WETLANDS, NONTIDAL WETLAND BUFFERS, WATERWAYS, OR THE 100-YEAR FLOODPLAIN.

DO NOT USE THE EXCAVATED MATERIAL AS BACKFILL IF IT CONTAINS WASTE METAL PRODUCTS, UNSIGHTLY DEBRIS, TOXIC MATERIAL, OR ANY OTHER DELETERIOUS SUBSTANCE. IF ADDITIONAL BACKFILL IS REQUIRED, USE CLEAN MATERIAL FREE OF WASTE METAL PRODUCTS, UNSIGHTLY DEBRIS, TOXIC MATERIAL, OR ANY OTHER DELETERIOUS SUBSTANCE.

PLACE HEAVY EQUIPMENT ON MATS OR SUITABLY OPERATE THE EQUIPMENT TO PREVENT DAMAGE TO NONTIDAL WETLANDS, NONTIDAL WETLAND BUFFERS, WATERWAYS, OR THE 100-YEAR FLOODPLAIN.

REPAIR AND MAINTAIN ANY SERVICEABLE STRUCTURE OR FILL SO THERE IS NO PERMANENT LOSS OF NONTIDAL WETLANDS, NONTIDAL WETLAND BUFFERS, OR WATERWAYS, OR PERMANENT MODIFICATION OF THE 100-YEAR FLOODPLAIN IN EXCESS OF THAT LOST UNDER THE ORIGINALLY AUTHORIZED STRUCTURE OR

RECTIFY ANY NONTIDAL WETLANDS, WETLAND BUFFERS, WATERWAYS, OR 100-YEAR FLOODPLAIN TEMPORARILY IMPACTED BY ANY CONSTRUCTION.

ALL STABILIZATION IN THE NONTIDAL WETLAND AND NONTIDAL WETLAND BUFFER SHALL CONSIST OF THE FOLLOWING SPECIES: ANNUAL RYEGRASS (LOLIUM MULTIFLORUM), MILLET (SETARIA ITALICA), BARLEY (HORDEUM SP.), OATS (UNIOLA SP.), AND/OR RYE (SECALE CEREALE). THESE SPÈCIES WILL ALLOW FOR THE STABILIZATION OF THE SITE WHILE ALSO ALLOWING FOR THE VOLUNTARY REVEGETATION OF NATURAL WETLAND SPECIES. OTHER NON-PERSISTENT VEGETATION MAY BE ACCEPTABLE, BUT MUST BE APPROVED BY THE NONTIDAL WETLANDS AND WATERWAYS DIVISION. KENTUCKY 31 FESCUE SHALL NOT BE UTILIZED IN WETLAND OR BUFFER AREAS. THE AREA SHOULD BE SEEDED AND MULCHED TO REDUCE EROSION AFTER CONSTRUCTION ACTIVITIES HAVE BEEN COMPLETED.

AFTER INSTALLATION HAS BEEN COMPLETED, MAKE POST-CONSTRUCTION GRADES AND ELEVATIONS THE SAME AS THE ORIGINAL GRADES AND ELEVATIONS IN TEMPORARILY IMPACTED AREAS.

9) TO PROTECT AQUATIC SPECIES, IN-STREAM WORK IS PROHIBITED AS DETERMINED BY THE **CLASSIFICATION OF THE STREAM:** 

USE I WATERS: IN-STREAM WORK SHALL NOT BE CONDUCTED DURING THE PERIOD MARCH 1 THROUGH JUNE 15, INCLUSIVE, DURING ANY YEAR.

USE III WATERS: IN-STREAM WORK SHALL NOT BE CONDUCTED DURING THE PERIOD OCTOBER 1 THROUGH APRIL 30, INCLUSIVE, DURING ANY YEAR.

USE IV WATERS: IN-STREAM WORK SHALL NOT BE CONDUCTED DURING THE PERIOD MARCH 1 THROUGH MAY 31, INCLUSIVE, DURING ANY YEAR.

10) STORMWATER RUNOFF FROM IMPERVIOUS SURFACES SHALL BE CONTROLLED TO PREVENT THE WASHING OF DEBRIS INTO THE WATERWAY.

11) CULVERTS SHALL BE CONSTRUCTED AND ANY RIPRAP PLACED SO AS NOT TO OBSTRUCT THE MOVEMENT OF AQUATIC SPECIES, UNLESS THE PURPOSE OF THE ACTIVITY IS TO IMPOUND WATER.