

MUNRO HALL 2ND FLOOR RENOVATION

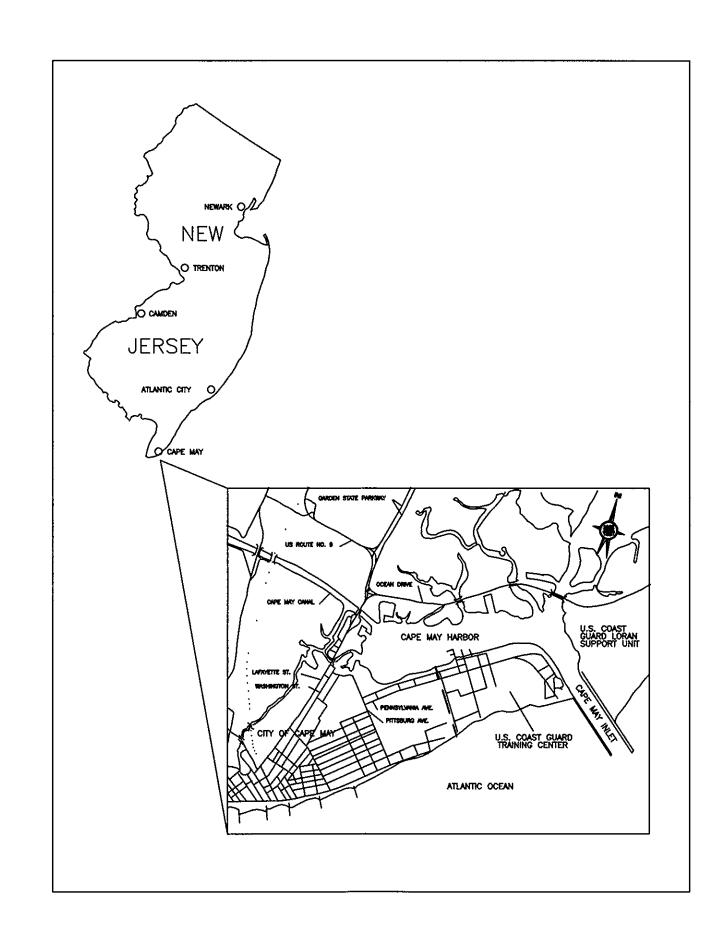

GENERAL NOTES:

- 1. THE INFORMATION PROVIDED ON THE CONTRACT DRAWINGS IS BELIEVED TO BE CORRECT. HOWEVER, THE CONTRACTOR SHALL FIELD VERIFY ALL INFORMATION.
- 2. ALL WORK INCLUDING PUNCH LIST ITEMS SHALL BE COMPLETED AND ACCEPTED PRIOR TO MAY 31, 2007.
- THE ENTIRE BUILDING EXCEPT SQUAD BAY 2W AND 2S WILL REMAIN IN OPERATION DURING CONSTRUCTION. CONTRACTOR TO MAINTAIN HVAC, PLUMBING, ELECTRICAL POWER, LIGHTING, AND TELECOMMUNICATIONS TO ENTIRE BUILDING.
- 4. CONTRACTOR SHALL COMPLY WITH ALL REQUIREMENTS OF THE NEWLY IMPLEMENTED RAPID GATE SECURITY SYSTEM. REFER TO SPECIFICATION SECTION 01305 FOR DETAILS.
- 5. ALL WORK IN SQUAD BAY 2S SHALL BE COMPLETED PRIOR TO STARTING WORK IN SQUAD BAY 2W. THE SQUAD BAY NOT CURRENTLY BEING WORKED ON BECOMES THE STORAGE AREA FOR THE RACKS AND MISCELLANEOUS ITEMS FROM THE ACTIVE SQUAD BAY. THE CONTRACTOR IS RESPONSIBLE FOR MOVING ALL RACKS AND MISCELLANEOUS ITEMS (I.E. BULLETIN BOARDS, ETC) BACK AND FORTH BETWEEN THE SQUAD BAYS.

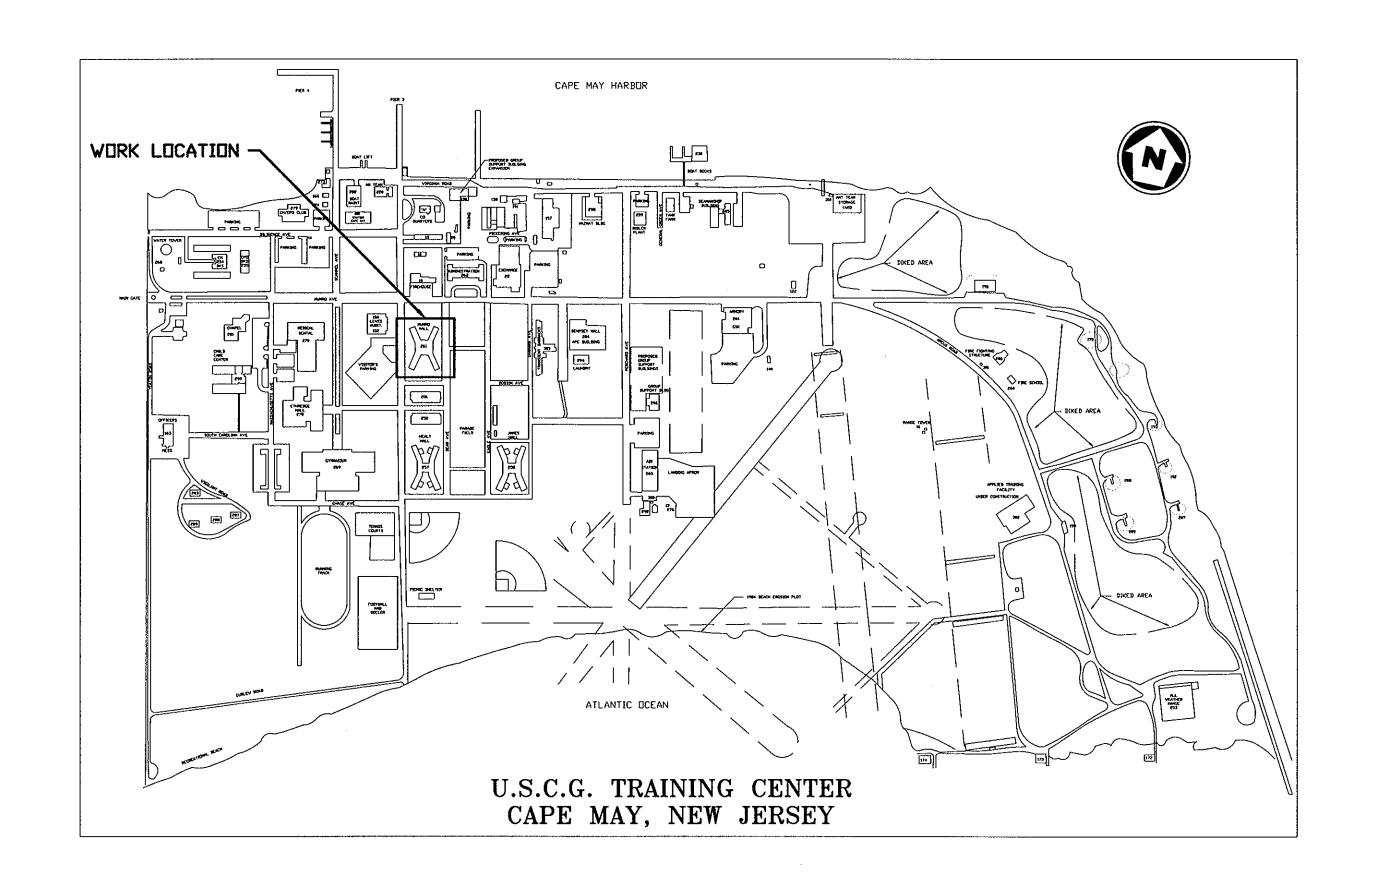

DRAWING LIST:

- CS COVER SHEET
- A1 DEMOLITION PLAN
 A2 ARCHITECTURAL FLOOR PLAN
- A3 DETAILS
- A4 ELEVATIONS
- A5 REFLECTED CEILING PLAN
- P1 PLUMBING FLOOR PLAN E1 ELECTRIC FLOOR PLAN
- E2 PANEL SCHEDULE

U. S. COAST GUARD
TRAINING CENTER
CAPE MAY



USCG, TRACEN CAPE MAY 1 MUNRO AVE. CAPE MAY, NJ 08204-5092

ISSUE

SHEET TITLE

MARK	DATE	DESCRIPTION	
,	ROJECT NO:	CMS-1130	
	ILE NAME:		
	NED BY:	SCM	
DRAWN	N BY:	SCM	
EDITED	BY:		
CHECK	ED BY:		
SCALE:	AS SHOWN	PLOT SCALE:	


MUNRO HALL 2ND FL RENOVATION TRACEN

BUILDING #261
MISCELLANEOUS
COVER SHEET

REVIEWED BY:	REVIEWED	BY:	REVIEWED BY:
S MCKAIG	KK SHIL	LING	
PROJECT ENG.	BRANCH	CHIEF	
	NG, CDF	₹	1/5/07 DATE
PROJECT NUI	MBER	DR	AWING NUMBER
T-050)10	T-:	5672-ZD
DISCIPLINE/S	SHT NO		

2

.

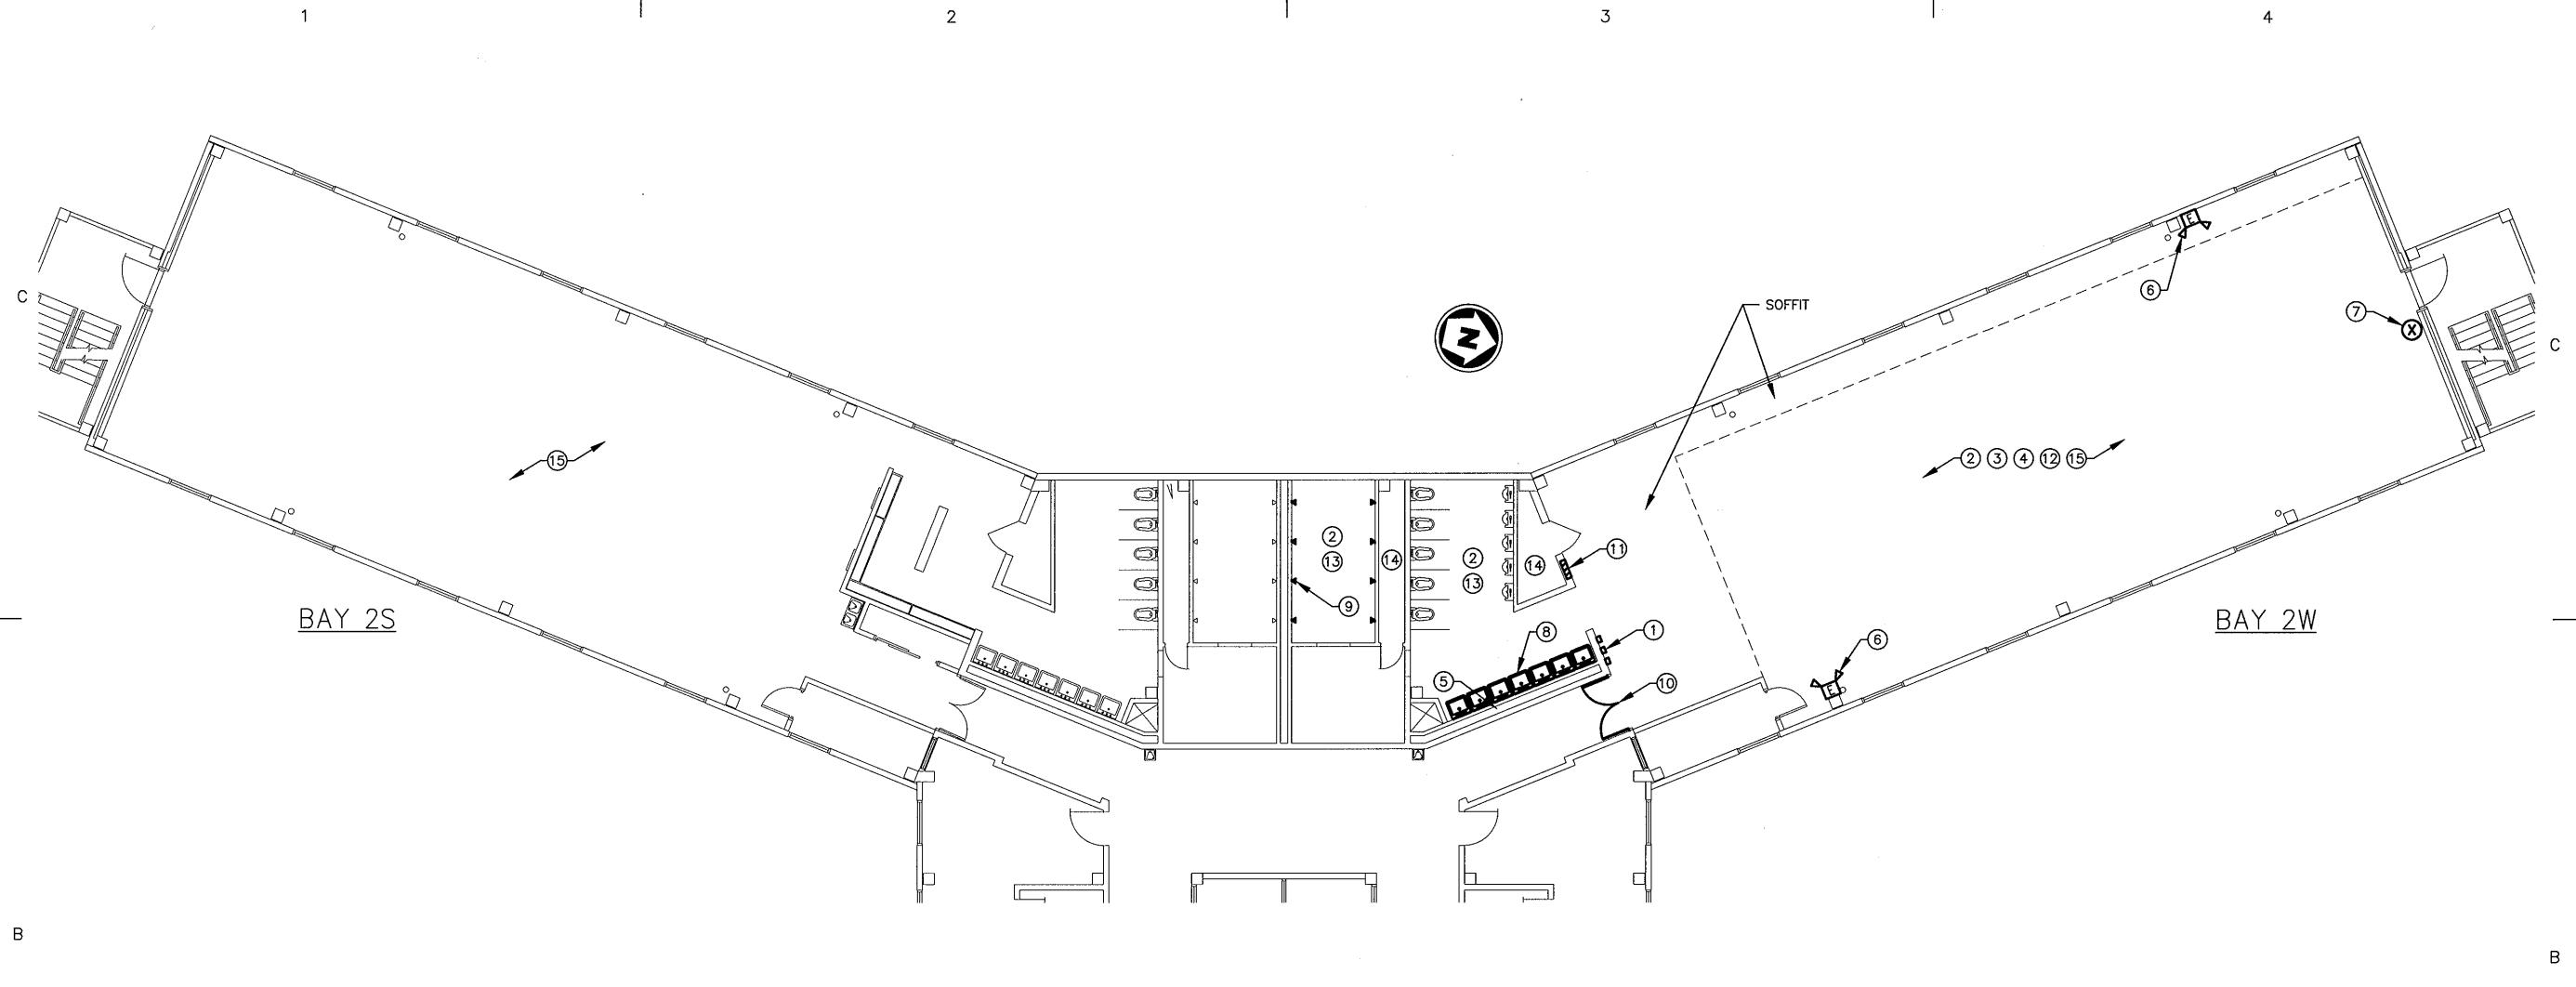

MUNRO HALL, 2ND FLOOR, DEMOLITION PLAN

SCALE: 1/8" = 1'-0"

DEMOLITION NOTES:

- (1) DISCONNECT AND REMOVE THREE TEMPERATURE AND HUMIDITY SENSORS. EXISTING SENSORS TO BE REINSTALLED ON NEW WALL. WIRING SHALL BE COMPLETELY REMOVED BACK TO SOURCE. EXISTING CONDUIT MAY BE REUSED/EXTENDED AS NECESSARY TO REACH NEW LOCATION.
- (2) DEMOLISH ALL LIGHT FIXTURES THROUGHOUT ENTIRE SQUAD BAY INCLUDING BATHROOM AND SHOWER AREAS. THERE ARE APPROXIMATELY 33 TOTAL FIXTURES. WIRING SHALL BE COMPLETELY REMOVED BACK THROUGH THE WALL LIGHT SWITCHES TO THE ELECTRICAL PANEL. EXISTING CIRCUIT BREAKERS SHALL BE LEFT AS SPARES. DEMOLISH ALL EXISTING LIGHT SWITCHES. EXISTING ELECTRICAL BOXES TO REMAIN.
- (3) DEMOLISH TWO CEILING MOUNTED SPEAKERS. SPEAKER WIRING AND CONDUIT SHALL BE COMPLETELY REMOVED BACK TO SOURCE.
- 4 DEMOLISH TWO SMOKE DETECTORS AND BASES. DETECTOR WIRING SHALL BE REMOVED BACK TO CLOSEST REMAINING SMOKE OR HEAT DETECTOR LOCATED ON RESPECTIVE FIRE ALARM ZONE.
- (5) DEMOLISH FOUR GFI RECEPTACLES LOCATED ABOVE LAVATORIES. WIRING SHALL BE COMPLETELY REMOVED BACK TO PANEL. EXISTING CIRCUIT BREAKERS SHALL BE LEFT AS SPARES. EXISTING ELECTRICAL BOXES TO REMAIN.
- (6) DEMOLISH TWO PLUG & CORD TYPE EMERGENCY LIGHTS.
- (7) DEMOLISH ONE PLUG & CORD TYPE EXIT SIGN.
- 8 DEMOLISH SEVEN SETS OF LAVATORIES, FAUCETS, P-TRAPS, SHUT OFF VALVES, PIPING (BACK TO EXISTING WALL), ETC.
- (9) DEMOLISH EIGHT SETS OF SHOWER HEADS, VALVES, FITTINGS, PIPING AND METAL COVER. COORDINATE WITH NEW SHOWER HEADS, PIPING AND FITTINGS BEING INSTALLED. PATCH AND REPAIR SHOWER WALLS (WHERE PIPE COVER REMOVED) WITH TILES TO MATCH EXISTING. REPAIR AND PATCH PIPING HOLES IN CEILING.
- (10) DEMOLISH EXISTING ENTRANCE DOORS AND HARDWARE.
- (11) DEMOLISH ONE EXISTING FIRE HOSE CABINET. INFILL OPENING TO MATCH EXISTING ADJACENT WALLS.
- 12 DEMOLISH EXISTING CEILING GRID AND TILES IN SQUAD BAY INCLUDING SOFFIT. EXISTING HVAC REGISTERS TO BE REINSTALLED IN NEW CEILING.
- (13) DEMOLISH EXISTING PLASTER/GWB CEILING IN BATHROOM AND SHOWER.
- (14) DEMOLISH EXISTING COLD WATER PIPING INSULATION ON PIPES SUPPLYING URINALS AND TOILETS. SOME INSULATION MAY CONTAIN ASBESTOS.
- (15) DEMOLISH EXISTING ASBESTOS FLOOR TILES AND VINYL COVE BASE THROUGHOUT SQUAD BAYS 2W & 2S. FLOORING IN BATHROOM AND SHOWER AREAS TO REMAIN. ABATE AND PROPERLY DISPOSE OF ALL ASBESTOS MATERIAL IN ACCORDANCE WITH CURRENT REGULATIONS.

GENERAL NOTES:

- 1. CONTRACTOR SHALL PATCH, REPAIR AND REFINISH AS REQUIRED ANY EXISTING SURFACES DAMAGED BY DEMOLITION WORK.
- 2. WHERE DEMOLITION EXPOSES AN UNFINISHED SURFACE, PATCH SURFACE TO MATCH THE ADJACENT SURFACE. PATCH SURFACE TO ELIMINATE EVIDENCE OF PATCHING OPERATION.
- 3. REPAIR ALL SLAB PENETRATIONS LEFT BY THE REMOVAL OF WALLS. FLOOR-MOUNTED POWER RECEPTACLES, FASTENINGS FOR WALLS AND PIPING WITH NON-SHRINK GROUT. HOLES EXTENDING TO THE FULL DEPTH OF THE SLAB SHALL BE PATCHED TO THE FULL DEPTH OF THE SLAB.
- 4. DURING THE ENTIRE PERIOD OF DEMOLITION AND CONSTRUCTION, MAINTAIN IN OPERATING CONDITION ALL EXISTING EXITS, EXIT LIGHTING, FIRE PROTECTION DEVICES AND ALARMS AS PER CODE. COORDINATE WITH BUILDING MANAGER.
- 5. PROTECT ALL EXISTING WALLS, CORE ELEMENTS, OVERHEAD HVAC, AND PLUMBING EQUIPMENT SCHEDULED TO REMAIN.
- 6. PROVIDE TEMPORARY SHORING AS REQUIRED OR ANY OTHER PROVISIONS TO INSURE THE SAFETY OF PERSONNEL, EXISTING STRUCTURE AND UTILITIES DURING CONSTRUCTION.
- 7. PROTECT ALL AREAS ADJACENT TO THE PROJECT AREA FROM DIRT, DUST DAMAGE,
- 8. THE ENTIRE BUILDING EXCEPT SQUAD BAYS 2W AND 2S WILL REMAIN IN OPERATION DURING CONSTRUCTION. CONTRACTOR TO MAINTAIN HVAC, PLUMBING. ELECTRICAL POWER, LIGHTING, AND TELECOMMUNICATIONS TO ENTIRE BUILDING.

GRAPHICAL SCALE: 1/8" = 1'

U. S. COAST GUARD TRAINING CENTER CAPE MAY

CONSULTANTS



USCG, TRACEN CAPE MAY 1 MUNRO AVE. CAPE MAY, NJ 08204-5092

ISSUE MARK DATE DESCRIPTION

A/E PROJECT NO: CMS-1130 CAD FILE NAME: DESIGNED BY: SCM DRAWN BY: SCM EDITED BY: CHECKED BY:

SCALE: AS SHOWN PLOT SCALE:

SHEET TITLE


MUNRO HALL 2ND FL RENOVATIONS TRACEN


CAPE MAY **NEW JERSEY** BUILDING #261 **ARCHITECTÜRAL** DEMOLITION PLAN

REVIEWED BY: REVIEWED BY S MCKAIG K SHILLING PROJECT ENG. BRANCH CHIEF J POLING, CDR 1/5/07 APPROVING OFFICER DATE

PROJECT NUMBER DRAWING NUMBER T-5673-AD DISCIPLINE/SHT NO

SHEET 2 OF 9

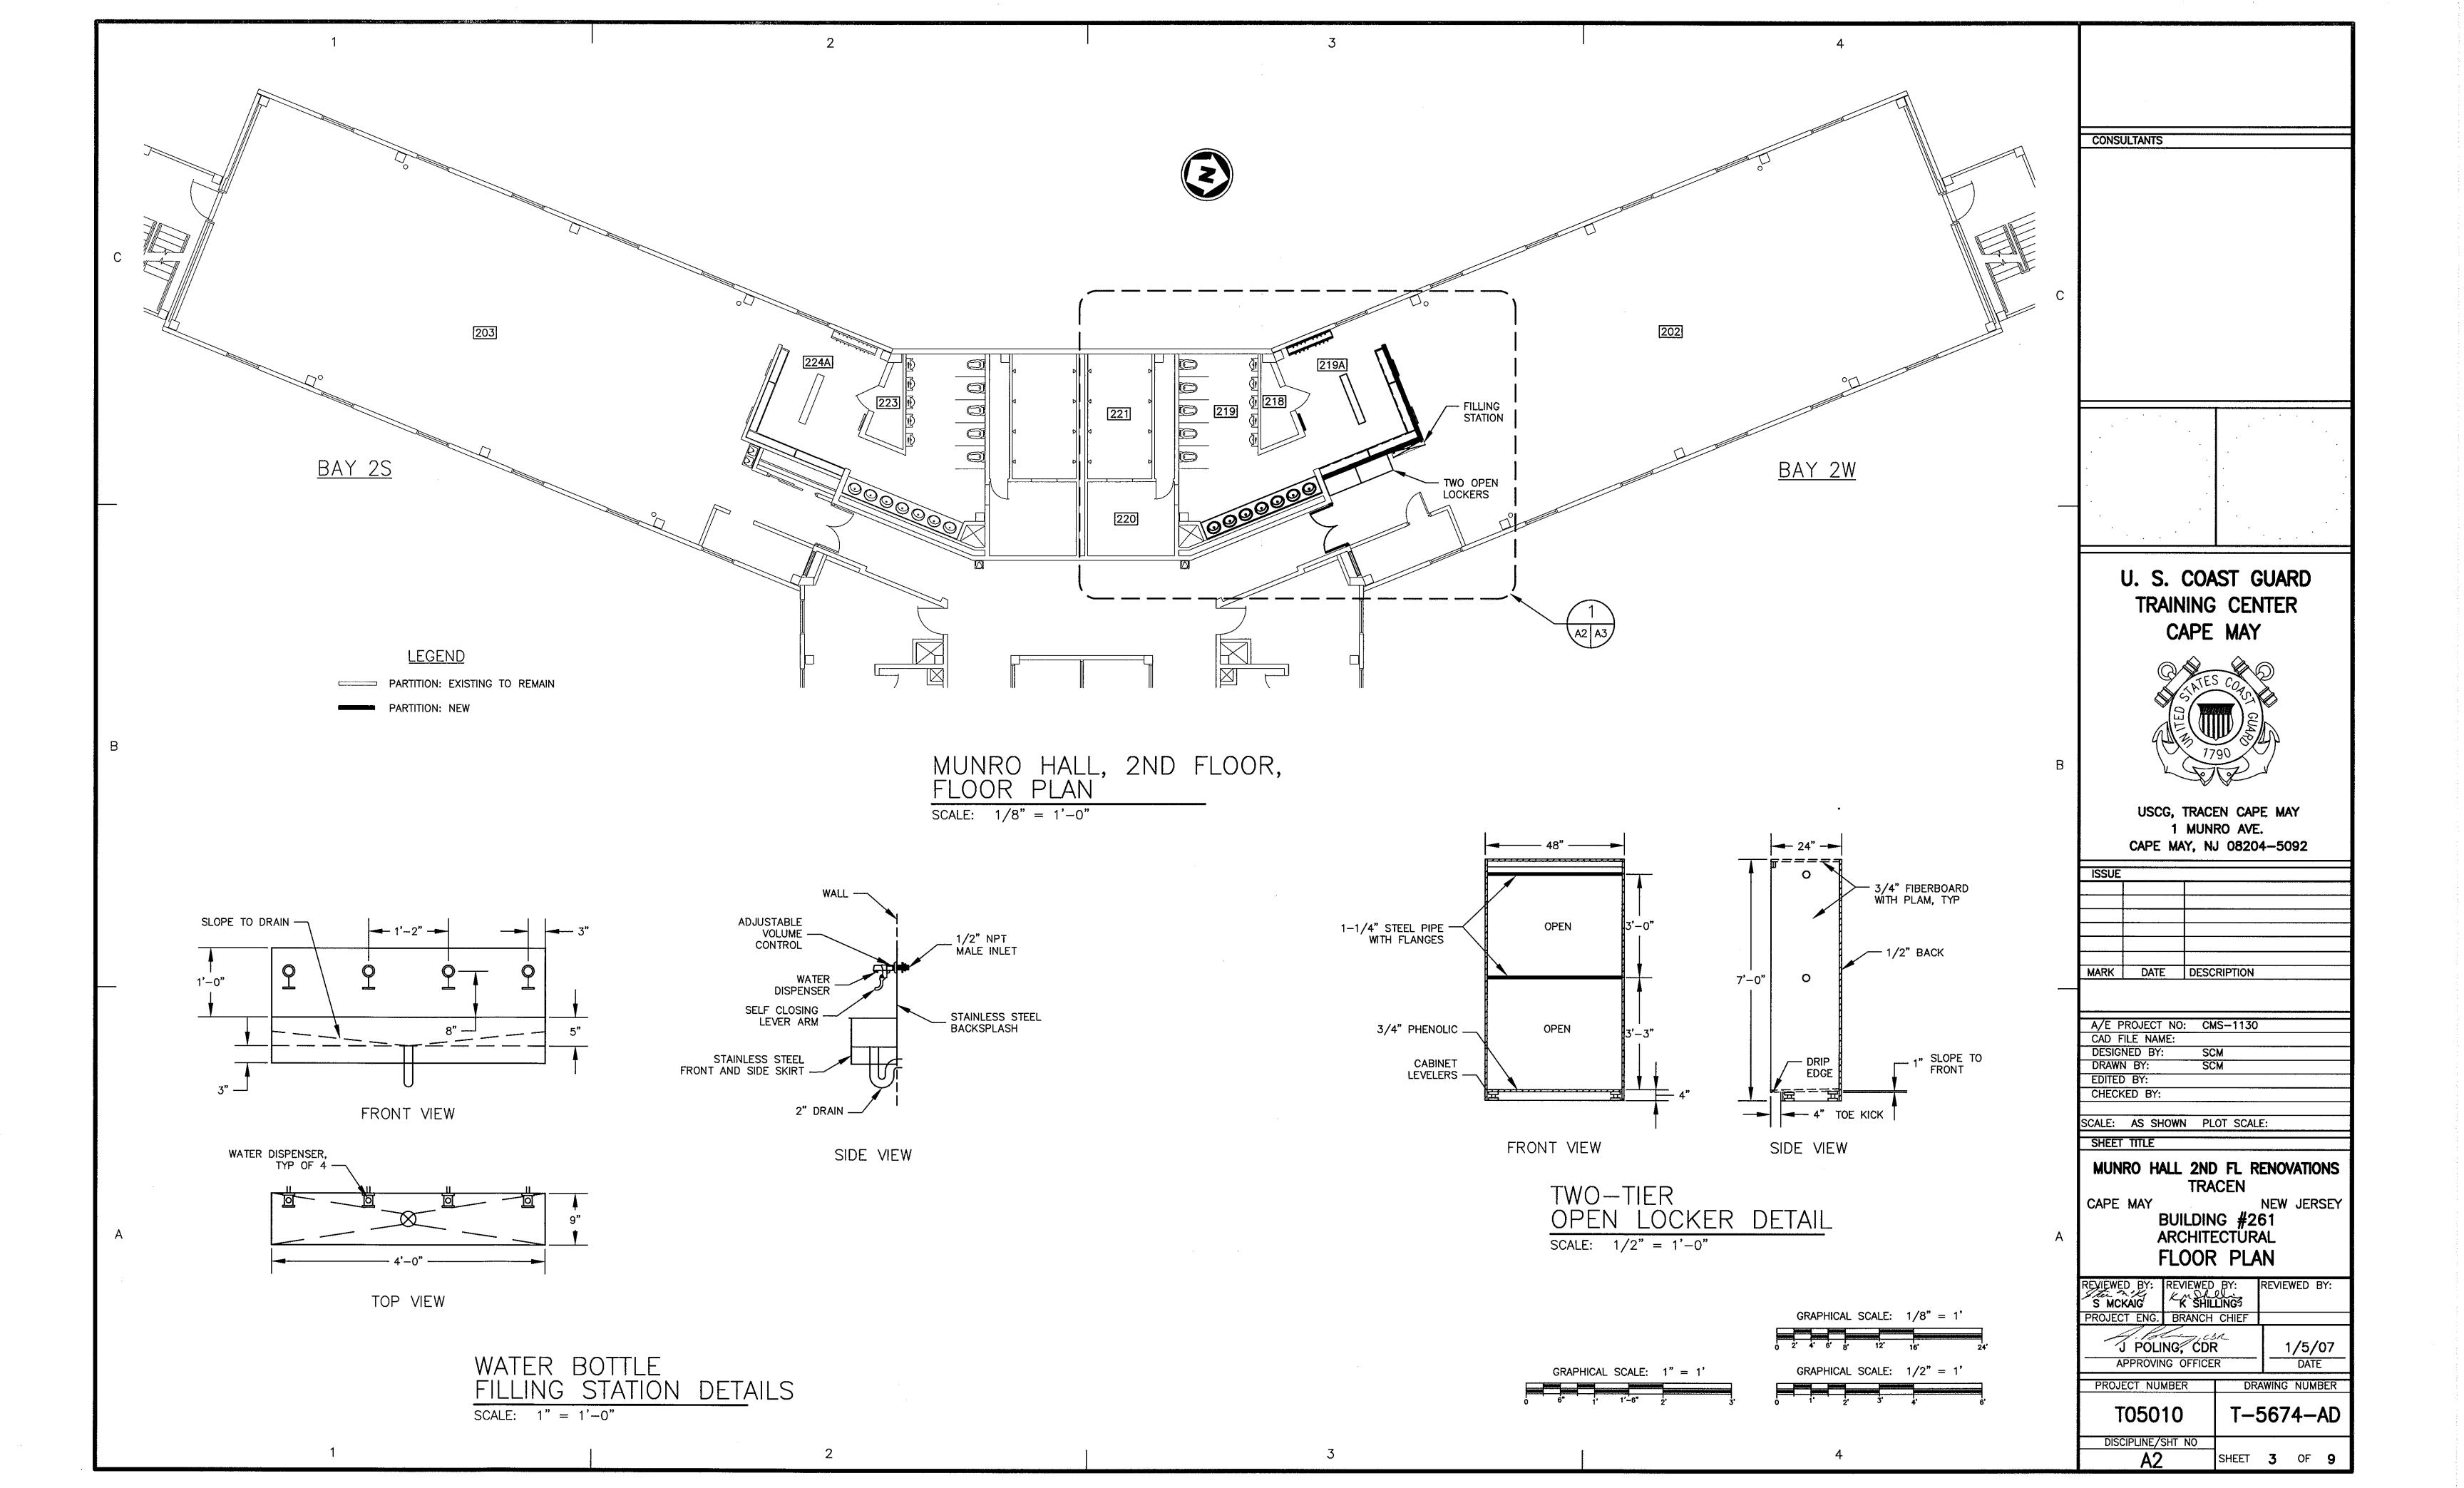

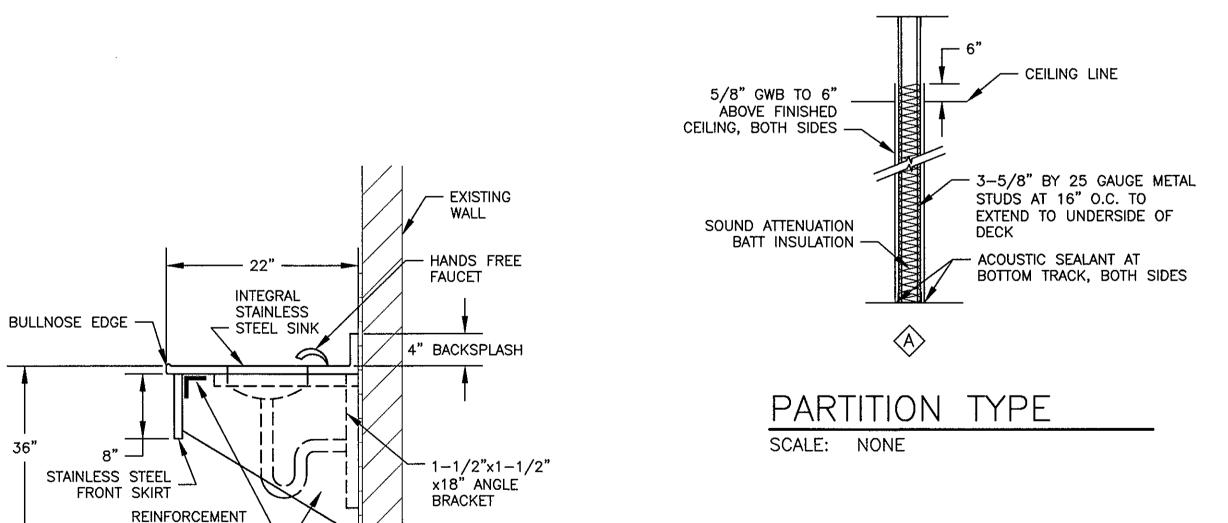

ANGLE AS REQUIRED

STAINLESS STEEL SIDE SKIRT

SCALE: NONE

LAVATORY DETAIL

GENERAL NOTES:

- 1. THE CONTRACTOR SHALL INSPECT THE JOB SITE PRIOR TO THE START OF WORK. VERIFY ALL SITE CONDITIONS, DIMENSIONS, QUANTITIES, BUILDING RULES AND OTHER LIMITATIONS. NO SUBSEQUENT EXTRAS WILL BE ALLOWED FOR ANY CLAIM DUE TO LACK OF KNOWLEDGE OF DISCERNIBLE CONDITIONS.
- 2. THE CONTRACTOR SHALL SECURE THE PROJECT AREA FROM NON-CONSTRUCTION PERSONNEL.
- 3. PROTECT ALL WORK, NEW AND EXISTING, FROM EXPOSURE TO WEATHER OR SUBSEQUENT CONSTRUCTION ACTIVITIES.
- 4. DIMENSIONS ARE GIVEN AS GUIDES TO ESTABLISH THE LAYOUT WHICH IS BASED ON THE GIVEN CONFIGURATION AND FEATURES OF THE EXISTING STRUCTURE. THE CONTRACTOR SHALL ASSURE PROPER FIT OF THE NEW WORK WITH PROPER RELATIONSHIP TO THE EXISTING FEATURES. THE CONTRACTOR SHALL BE RESPONSIBLE FOR CONFORMING ALL DIMENSIONS BEFORE ORDERING EQUIPMENT AND MILLWORK.
- 5. AT THE COMPLETION OF THE WORK, CLEAN ALL EXPOSED SURFACES AND LEAVE PROJECT CLEAN AND READY FOR OCCUPANCY. EMPLOY EXPERIENCED WORKMEN OR PROFESSIONAL CLEANERS FOR FINAL CLEANING. REMOVE GREASE, DUST, DIRT, STAINS, LABELS (EXCEPT FROM RATED DOORS), FINGERPRINTS AND OTHER FOREIGN MATERIALS FROM EXPOSED SURFACES. POLISH, PATCH AND TOUCHUP MARRED SURFACES TO SPECIFIED FINISH. CLEAN ELECTRICAL WORK INCLUDING LIGHT FIXTURES.
- 6. SEE REFLECTED CEILING PLAN FOR CEILING DETAILS.


WALL AND CEILING FINISH NOTES:

- 1. ALL WALLS SHALL BE PROPERLY PREPARED (SPACKLED, SANDED AND FILLED) IN ACCORDANCE WITH MANUFACTURER'S SPECIFICATIONS.
- 2. ALL PAINTS SHALL BE APPLIED IN ACCORDANCE WITH MANUFACTURER'S SPECIFICATIONS.
- 3. FINISHING AT GWB TO BE ONE COAT OF INTERIOR LATEX BASE PRIMER COAT AND MINIMUM TWO COATS OF INTERIOR LATEX PAINT. PRIME COAT TO BE TINTED SIMILAR TO FINISH COAT. PROVIDE ADDITIONAL COATS AS REQUIRED TO PROVIDE COLOR AND FINISH UNIFORMITY THROUGHOUT. PRIME ALL WALLS TO RECEIVE WALL COVERING.
- 4. FINISH PAINTED WALLS WITH EGG SHELL FINISH.
- 5. FINISHING AT PAINTED DOORS, FRAMES, AND OTHER METAL TRIM TO BE ONE COAT OF INTERIOR UNDERCOAT AND TWO COATS OF ODORLESS INTERIOR ALKYD SEMI-GLOSS ENAMEL. PROVIDE ADDITIONAL PRIMER COATS AS REQUIRED TO CONCEAL EXISTING FINISHES. PAINT AIR GRILLS, ACCESS PANELS, ETC. SET INTO WALL OR CEILING TO MATCH ADJACENT SURFACE.
- 6. REFER TO DOOR SCHEDULE FOR FINISH OF ALL DOORS AND
- 7. REFER TO ELEVATIONS, DETAILS AND SCHEDULES FOR ADDITIONAL INFORMATION REGARDING LOCATION OF WALL FINISHES AND FOR SPECIFIC WALL FINISH DESCRIPTIONS.
- 8. LOCKING CLIPS ARE REQUIRED FOR ALL CEILING TILES INSTALLED IN SQUAD BAY, CHANGING ROOMS AND BATHROOMS.
- 9. PROVIDE THREE, 4' HIGH, PLASTIC WALL CORNER GUARDS TO BE LOCATED ON NEW WALL AT EACH EXPOSED OUTSIDE

			FIN	NSH S	CHEDI	JLE	
NO.	IO. ROOM NAME	FLOOR	BASE	WALLS	CEILING		DEMARKS
NO.		ROOM NAME	CODE	CODE	CODE	CODE	HGT. REMARKS
202	SQUAD BAY 2W	EPX-1	VB-1	P-1	ACT-1	8'-0"	INCLUDES SOFFIT AREA
218	PIPE CHASE, 2W	EPX-1	-	_	_	-	
219	BATHROOM, 2W	_	1	-	ACT-2	8'-0"	
219A	CHANGING ROOM, 2W	EPX-1	VB-1	P-1	ACT-1	7'-4"	
221	SHOWER, 2W	_	_	-	GWB-1	7'-4"	
203	SQUAD BAY 2S	EPX-1	VB-1	_	_	-	INCLUDES FLOOR IN COAT CLOSET
223	PIPE CHASE, 2S	EPX-1	_	<u>-</u>	_	_	
224A	CHANGING ROOM, 2S	EPX-1	VB-1	_	_		

;					DOO	R SC	HEDL	JLE			, , , , , , , , , , , , , , , , , , , ,
			DOOR						FRAME		
ROOM	DESCRIPTION	NOM	NAL SIZE					HARDW.	RATING	MAT.	REMARKS
	į.	WIDTH	HT.	THICK.	MAT.	TYPE	FINISH	SET#		MAI.	
202	SQUAD BAY	(2) 2'-6"	6'-8"	1-3/8"	НМ	E-1	FACT	1	1 HR	-	INSTALL ON EXISTING FRAME

DOOR HARDWARE

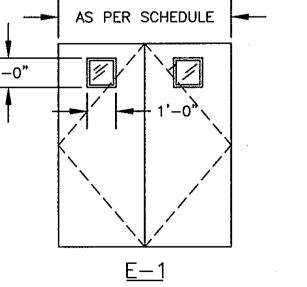

HARDWARE SET #1 (FRP DOUBLE DOORS SQUAD BAY): 6 EA MORTISE HINGES 2 EA SVR EXIT DEVICE 9827L-F X 06 LEVER (ED-1) VON DUPRIN (CY-1) BEST LOCK CORP 626 RIM CYLINDERS 1E74 X GMK 351-P9 (PAR. ARM MOUNT) 689 (CL-1) SARGENT CLOSERS DOOR CLOSERS (KP-1) ROCKWOOD MFG KICK PLATES 8 X 29 WALL BUMPERS 630 (ST-1) ROCKWOOD MFG GRAY (SI-1) CONSTRUCTION DOOR SILENCERS 2 EA METAL BUMPER

DOOR TYPE SCALE: NONE

GRAPHICAL SCALE: 1/4" = 1'

U. S. COAST GUARD TRAINING CENTER CAPE MAY

CONSULTÂNTS



USCG, TRACEN CAPE MAY 1 MUNRO AVE. CAPE MAY, NJ 08204-5092

MARK	DATE	DESCRIPTION
A/E F	PROJECT NO:	: CMS-1130
CAD F	ILE NAME:	
DESIG	NED BY:	SCM
DRAW	V BY:	SCM
EDITE	BY:	
CHECK	KED BY:	

SCALE: AS SHOWN PLOT SCALE:

SHEET TITLE

ISSUE


MUNRO HALL 2ND FL RENOVATIONS TRACEN


NEW JERSEY CAPE MAY

BUILDING #261 ARCHITECTÜRAL **DETAILS**

S MCKAIG	K SHILLING	RÉVIEWED BY:
PROJECT ENG.	BRANCH CHIEF	
	NG, CDR	1/5/07
APPROVIN	IG OFFICER	DATE

PROJECT NUMBER DRAWING NUMBER T-5675-AD T05010 DISCIPLINE/SHT NO SHEET 4 OF 9

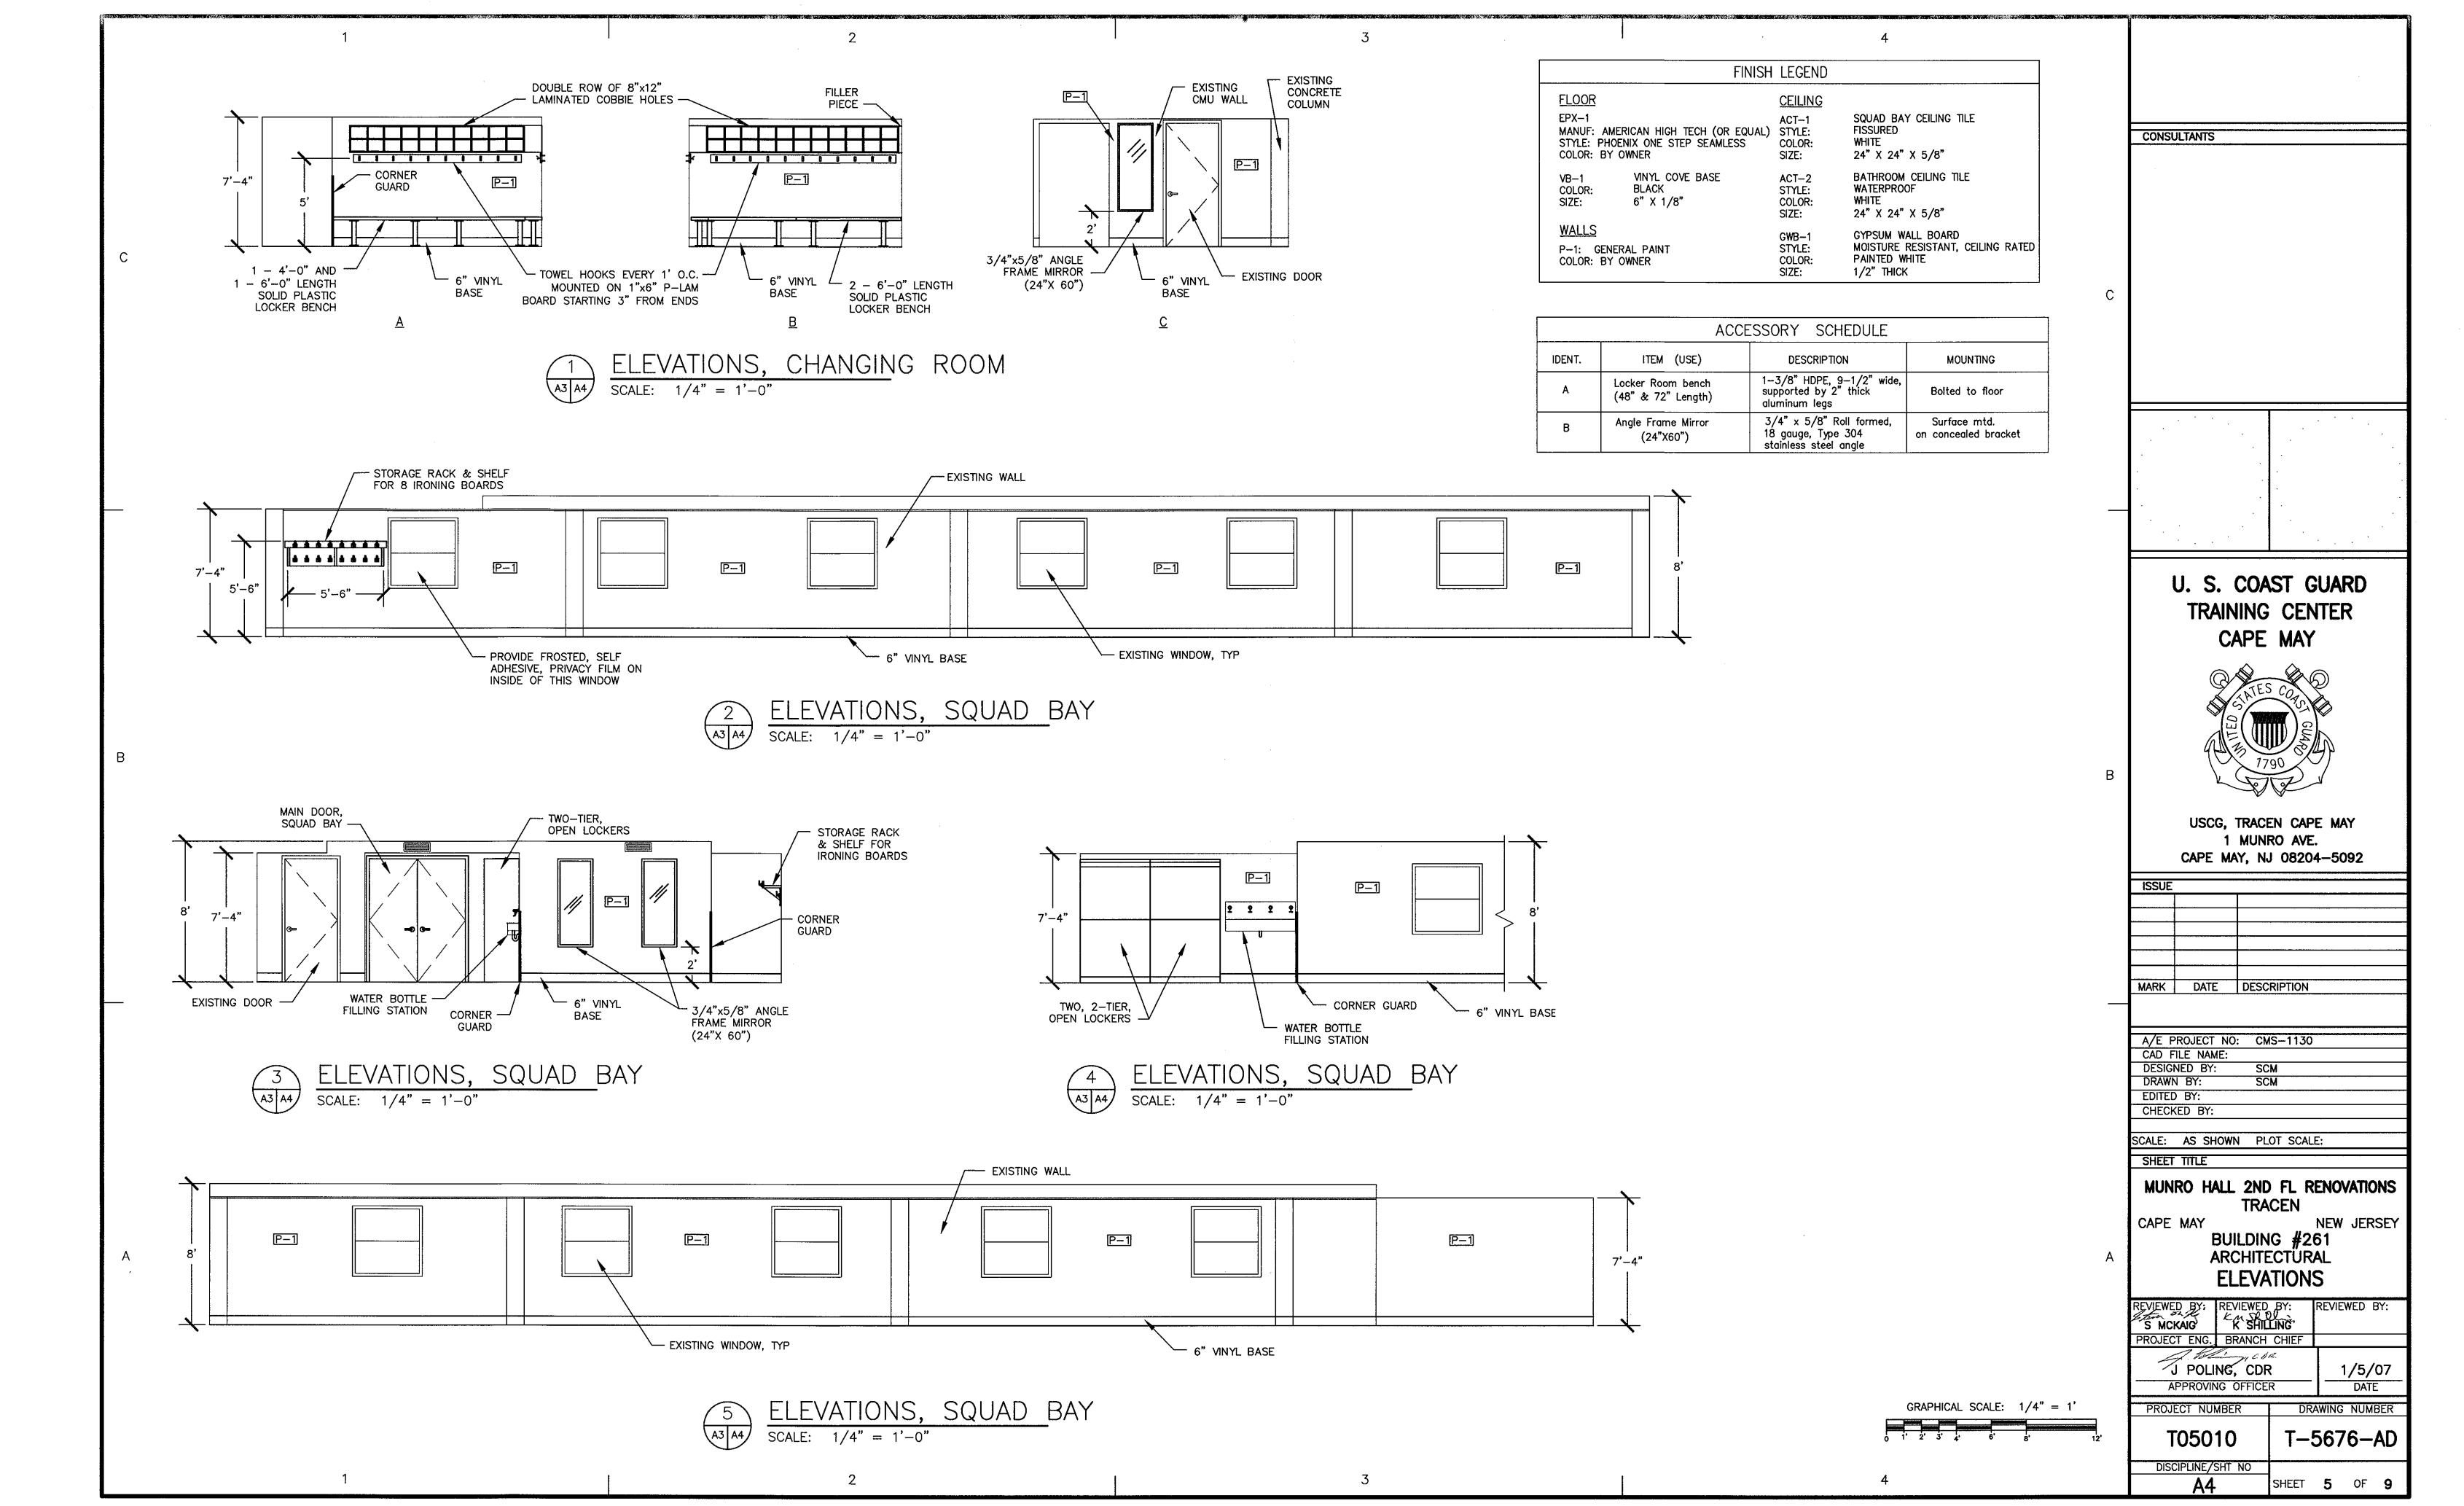

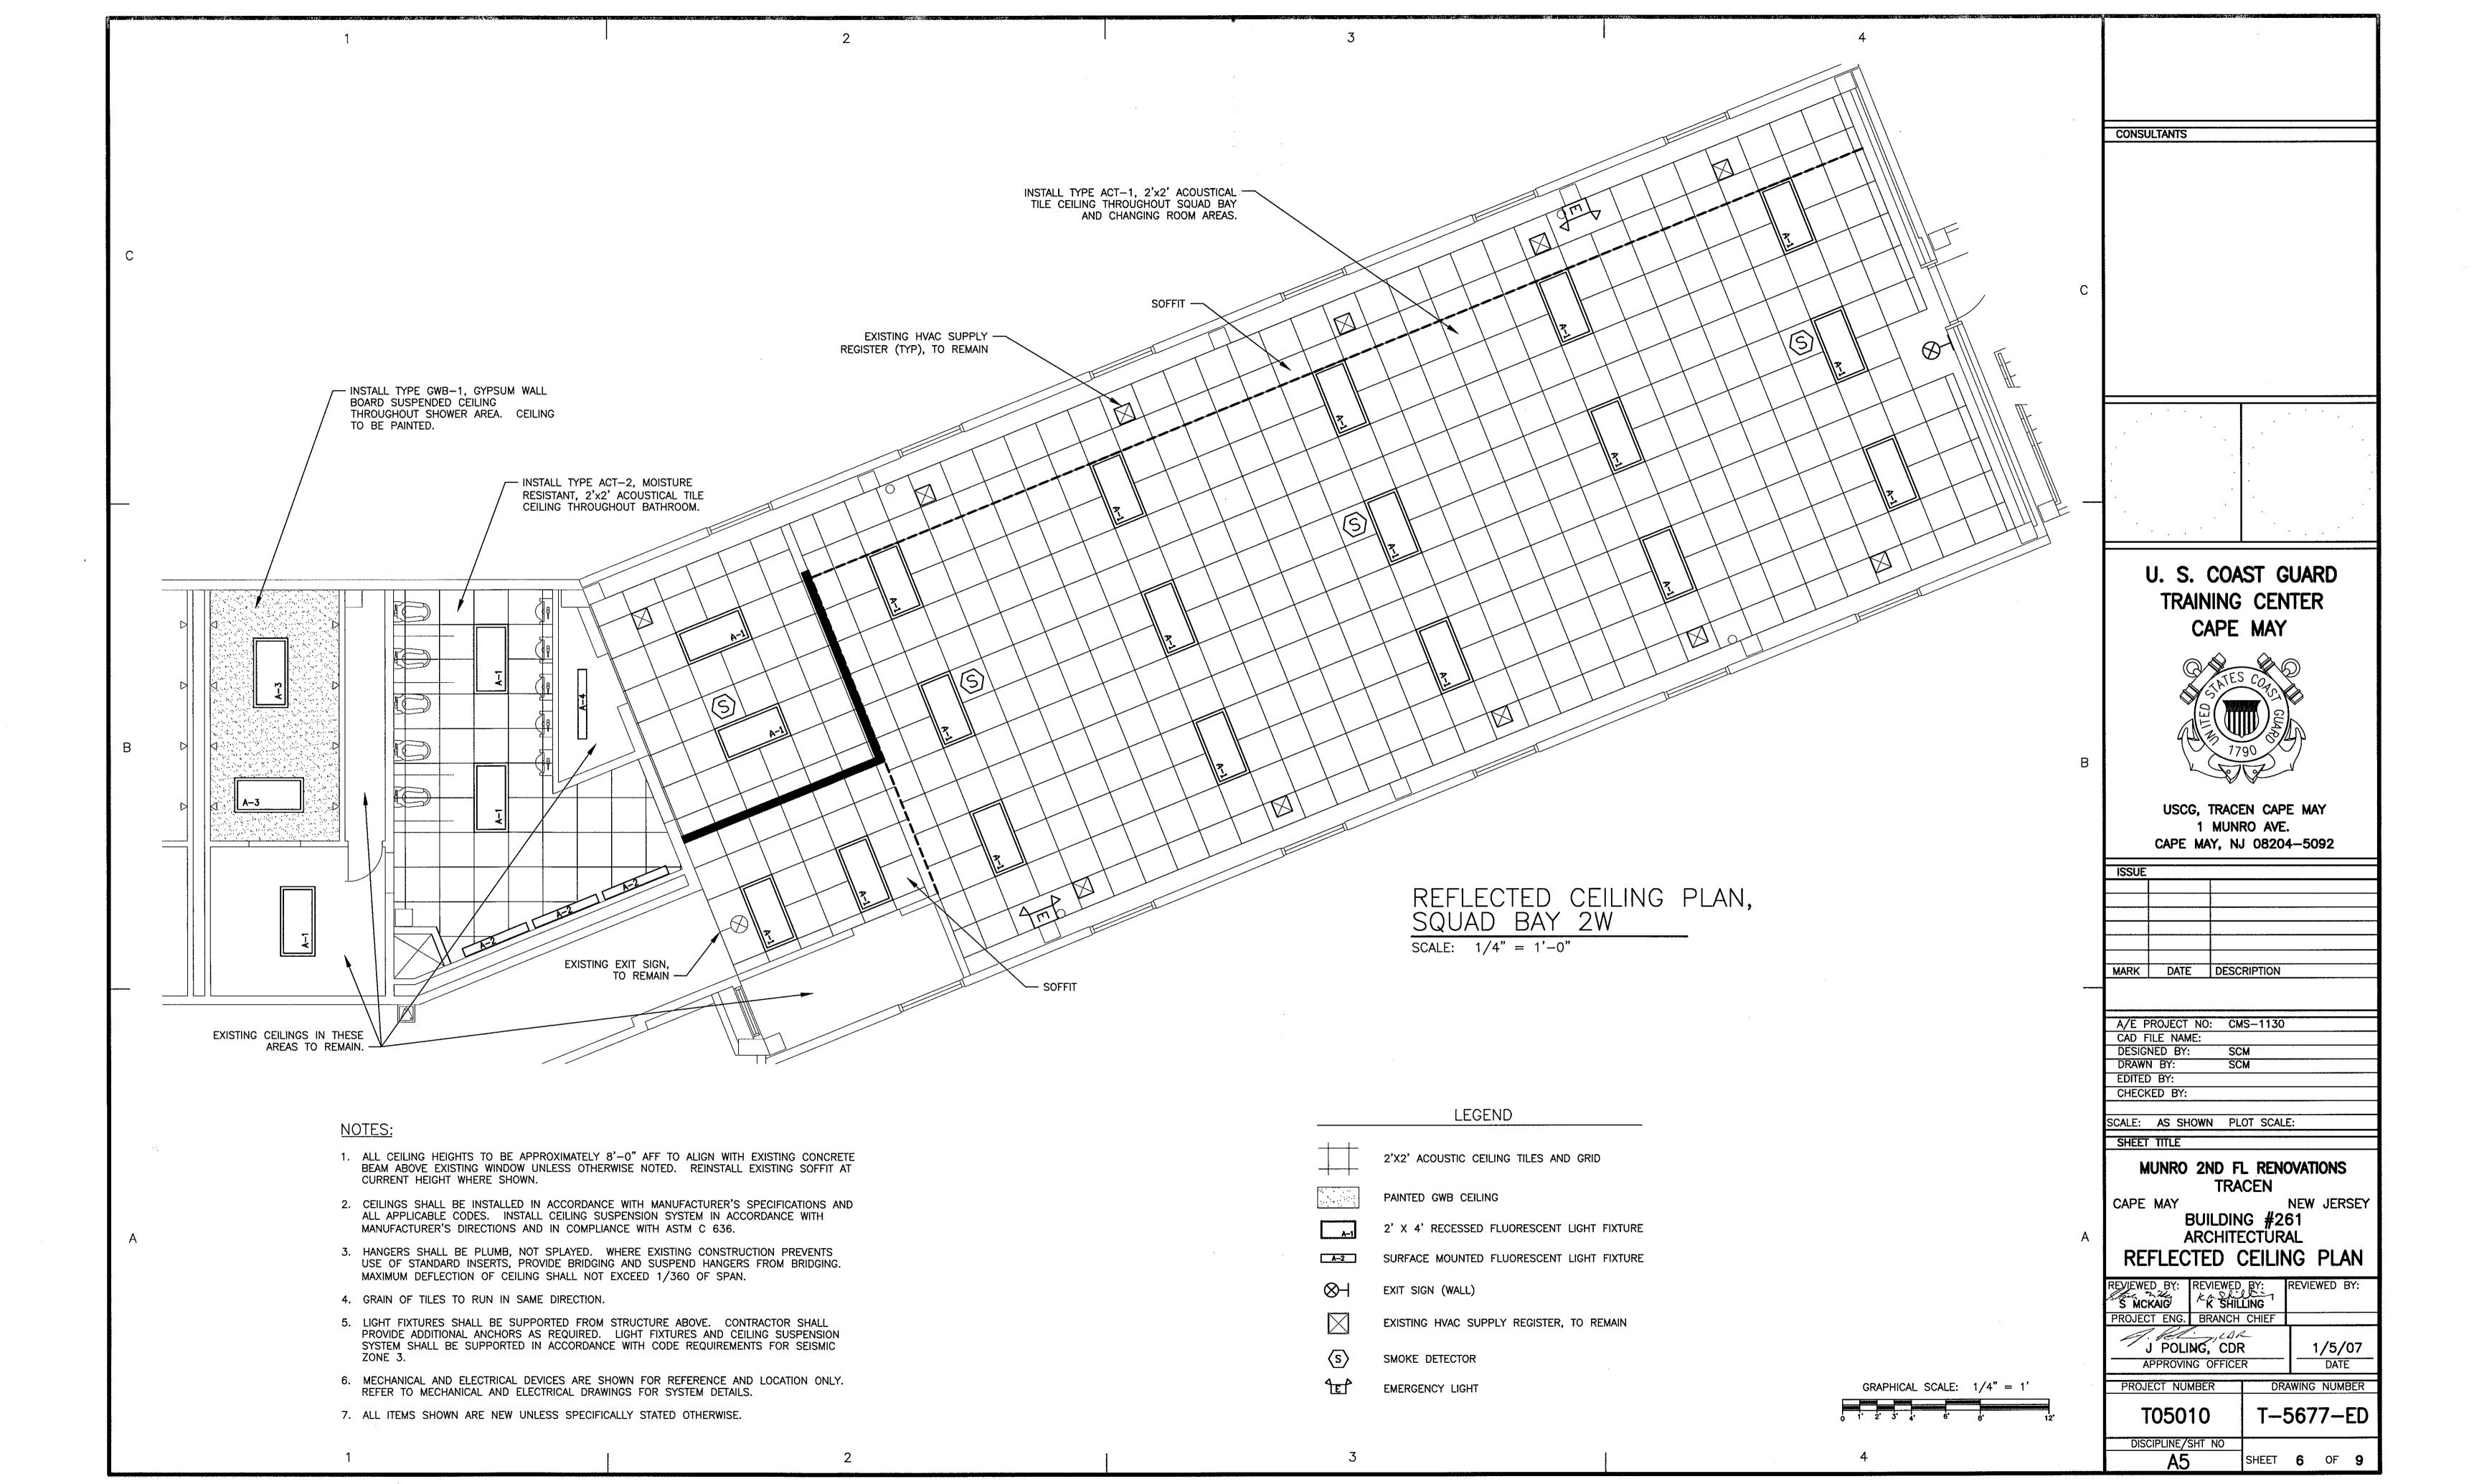

CHASE


PLUMBING PLAN, SQUAD BAY 2W SCALE: 1/4" = 1'-0"

CONSTRUCTION NOTES:

- 1. PROVIDE EIGHT NEW SHOWER HEADS, MIXING VALVES, AND TRIM. NEW MIXING VALVES TO MATCH EXISTING VALVES INSTALLED IN OTHER SQUAD BAYS. PROVIDE NEW COPPER PIPING FROM WATER SOURCE IN SHOWER WALLS TO NEW VALVES AND HEADS. PROVIDE NEW INSULATION ON ALL NEW PIPING. PATCH WALLS AS NECESSARY TO MATCH EXISTING.
- 2. PROVIDE FIVE NEW 0.5 GALLON FLUSH VALVES ON EXISTING URINALS. NEW FLUSH VALVES TO MATCH EXISTING VALVES INSTALLED IN OTHER SQUAD BAYS. REINSTALL EXISTING AUTOMATIC FLUSH CONTROLS.
- 3. PROVIDE SEVEN NEW STAINLESS STEEL LAVATORIES WITH BATTERY OPERATED, AUTOMATIC SENSING FAUCETS. NEW FAUCETS TO MATCH EXISTING FAUCETS INSTALLED IN OTHER SQUAD BAYS. PROVIDE NEW MIXING VALVES, SHUT OFF VALVES, CHROME TRAPS, TAIL PIECES, ESCUTHEN PLATES, COPPER WATER SUPPLY LINES, ETC. CONNECT NEW PIPING TO EXISTING PIPING AT EXISTING
- 4. PROVIDE NEW FOUR DISPENSER, RESTAURANT STYLE, WATER BOTTLE FILLING STATION. PROVIDE NEW 2" CHROME TAIL PIECE AND TRAP. PROVIDE NEW 2" PVC DRAIN PIPE AND CONNECT TO NEAREST STACK. IF DISTANCE TO STACK EXCEEDS CODE LIMITS, PROVIDE NEW VENT PIPING. PROVIDE NEW 1/2" COPPER COLD WATER SUPPLY LINE AND CONNECT TO NEAREST SOURCE. CORE DRILL CONCRETE FLOOR AS NECESSARY.
- 5. PROVIDE NEW INSULATION ON ALL EXPOSED COPPER PIPING SUPPLYING COLD WATER TO WATER CLOSETS IN SQUAD BAYS 2W, 2S, 3W, 3S, 3E, AND 3N.
- 6. PROVIDE NEW INSULATION ON ALL EXPOSED COPPER PIPING SUPPLYING COLD WATER TO URINALS IN SQUAD BAYS 2W, 3W, 3S, 3E, AND 3N.

U. S. COAST GUARD TRAINING CENTER CAPE MAY

CONSULTANTS

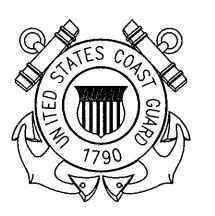

USCG, TRACEN CAPE MAY 1 MUNRO AVE. CAPE MAY, NJ 08204-5092

MARK	DATE	DESCRIPTION	
A /E E	ROJECT NO	: CMS-1130	*
_		: CM3-1130	
CAD F	TLE NAME:		
DESIG	NED BY:	SCM	
DRAW	N BY:	SCM	
EDITE	BY:		
CHEC	KED BY:		

SCALE: AS SHOWN PLOT SCALE:

SHEET TITLE

ISSUE

MUNRO HALL 2ND FL RENOVATIONS TRACEN

NEW JERSEY
BUILDING #261
PLUMBING
FLOOR PLAN CAPE MAY

•,	REVIEWED BY:	REVIEWED BY: K SHILLING	REVIEWED BY:
	PROJECT ENG.	BRANCH CHIEF	
	J POLI	NG, ÆDR	1/5/07
	APPROVI	NG OFFICER	DATE

PROJECT NUMBER DRAWING NUMBER T05010 T-5678-PD DISCIPLINE/SHT NO

SHEET 7 OF 9

GRAPHICAL SCALE: 1/4" = 1'

CONSTRUCTION NOTES:

- 1. PROVIDE 28 NEW LIGHT FIXTURES. PROVIDE NEW EMT CONDUIT AS NECESSARY TO REACH NEW LIGHT FIXTURE LOCATIONS. EXISTING CONDUIT MAY BE REUSED. PROVIDE ADDITIONAL CONDUIT SUPPORTS AS NECESSARY TO PROPERLY SUPPORT EXISTING CONDUIT. PROVIDE NEW WIRE BACK TO EXISTING PANEL AND CONNECT TO SPARE CIRCUIT BREAKER. REFER TO LIGHTING SCHEDULE FOR FIXTURE DETAILS.
- 2. PROVIDE SEVEN NEW TOGGLE SWITCHES AND STAINLESS STEEL FACEPLATES. CONTRACTOR MAY REUSE EXISTING BOX WHEN SWITCH IS INSTALLED IN AN EXISTING WALL.
- 3. PROVIDE SEVEN NEW SINGLE RECEPTACLES ON THEIR OWN DEDICATED CIRCUIT. PROVIDE STAINLESS STEEL FACEPLATES. PROVIDE NEW WIRE BACK TO EXISTING PANEL AND CONNECT TO SPARE CIRCUIT
- 4. PROVIDE FOUR NEW DUPLEX GFI RECEPTACLES OVER NEW LAVATORIES. CONTRACTOR MAY REUSE EXISTING BOXES. PROVIDE STAINLESS STEEL FACEPLATES. PROVIDE NEW WIRE BACK TO EXISTING PANEL AND CONNECT TO SPARE CIRCUIT BREAKER.
- 5. PROVIDE TWO NEW BATTERY BACKED, CORD & PLUG STYLE, EMERGENCY LIGHT FIXTURES. CONNECT NEW FIXTURES TO EXISTING RECEPTACLES.
- 6. PROVIDE ONE NEW RADIOACTIVE EXIT SIGN.
- 7. PROVIDE FOUR NEW CONVENTIONAL SMOKE DETECTORS. CONNECT SMOKE DETECTORS TO EXISTING CUIRCUIT USING NEW WIRE. PROVIDE NEW EMT CONDUIT AS NECESSARY TO REACH NEW LOCATIONS. EXISTING CONDUIT MAY BE REUSED. REFER TO SPECIFICATIONS FOR FIRE ALARM SYSTEM TESTING
- 8. MOVE THREE EXISTING HVAC THERMOSTATS TO NEW LOCATION AND INSTALL NEW WIRE. EXTEND CONDUIT AS NECESSARY TO NEW LOCATION. PROVIDE NEW WIRE BACK TO SOURCE HVAC EQUIPMENT.

EXISTING PANEL 2W

ELECTRIC PLAN, SQUAD BAY 2W SCALE: 1/4" = 1'-0"

LEGEND

- 20A, 125V 'U' GROUNDED SIMPLEX RECEPTACLE COLORED RED.
- 'GFCI' GROUND FAULT CIRCUIT INTERRUPTER RECEPTACLE
- 20A SINGLE POLE SWITCH a INDICATES LIGHTS SWITCHED FLUORESCENT LIGHTING FIXTURE — TYPE INDICATED ON DRAWINGS
- EXIT SIGN
- SMOKE DETECTOR
- EMERGENCY LIGHT

CONSULTANTS

U. S. COAST GUARD TRAINING CENTER CAPE MAY



USCG, TRACEN CAPE MAY 1 MUNRO AVE. CAPE MAY, NJ 08204-5092

MARK DATE DESCRIPTION

A/E PROJECT NO: CMS-1130 CAD FILE NAME: DESIGNED BY: DRAWN BY: EDITED BY: CHECKED BY:

SCALE: AS SHOWN PLOT SCALE: SHEET TITLE

GRAPHICAL SCALE: 1/4" = 1'

MUNRO HALL 2ND FL RENOVATIONS TRACEN

NEW JERSEY CAPE MAY BUILDING #261 ELECTRICAL FLOOR PLAN

REVIEWED BY: REVIEWED BY: REVIEWED BY: PROJECT ENG. BRANCH CHIEF J POLING, CDR 1/5/07 DATE APPROVING OFFICER PROJECT NUMBER DRAWING NUMBER

> T05010 T-5679-ED DISCIPLINE/SHT NO

> > SHEET 8 OF 9

		LIGH	ITING	FIXTURE SCHEDULE	
TYPE	LAMP/WATTS	MANUFACTURER	CAT.NO.	DESCRIPTION	MOUNTING
A-1	2-32W T-8	METALUX	2GR8-232-A- 120V-ER8	2' X 4' FLOURESCENT, COMMERCIAL GRADE STATIC TROFFER LIGHTING FIXTURE, #12 PATTERN ACRYLIC LENS, WITH ELECTRONIC BALLAST.	RECESSED
A-2	2-32W T-8	METALUX	BA-UB-232-HTS -120V-ER8	4' LENGTH WALL BRACKET, BRUSHED ALUMINIUM, UP/DOWN CONFIGURATION, 2-32W T8 LAMPS, WITH ELECTRONIC BALLAST.	SURFACE
A-3	3-32W T-8	METALUX	CFDXF-332- 120V-EB81	2'X4' RECESSED STATIC TROFFER, UL LISTED FOR WET LOCATION, 3-32W T8 LAMPS, 120V, WITH ELECTRONIC BALLAST. DFF-24W-U DRY WALL FRAME AND KIT TO BE USED WITH THE FIXTURE.	RECESSED
A-4	1-32W T-8	METALUX	SN-132-120V- ER8	4' MULTI-PURPOSE NARROW STRIP LIGHT, 1-32W T-8 LAMP, WITH ELECTRONIC BALLAST.	SURFACE
X-1	_	SRB TECHNOLOGIE	B100-20-BK-RD	SELF LUMINOUS RADIOACTIVE EXIT LIGHT, MODEL 'B' TYPE	WALL

^{*} ALL FLUORESCENT LIGHTING TUBES SHALL BE 4100K (COOL WHITE).

208/120 100A MO	DV, 3PH., 4W CB	SIEMENS	EXIS	STING	PAN	EL 2	1/1/ E 💉 1	D. FLOOR CESSED
WATTS	LOCATION	BKR.	SIZE		BKR.	SIZE	LOCATION	WATTS
	(1) REC - IRON	20A,1P	1	2		20A,1P	LIGHTS - SQUAD BAY	
-	(1) REC - IRON	20A,1P		3 4		20A,1P	LIGHTS - CHANGING/BATH	,
	(1) REC - IRON	20A,1P		5,	6	20A,1P	LIGHTS IN C.O.'S OFFICE	
	(1) REC - IRON	20A,1P		8			FCU-10 & FCU-11	100W
	(1) REC - IRON	20A,1P		9 10			RECEPTACLES - BATHROOM	
	(1) REC - IRON	20A,1P		11	12	20A,1P	(2) UH'S BATH WEST	696W
	(1) REC - IRON	20A,1P		14		20A,1P	SPARE	
•	LIGHTS MECH. ROOM	20A,1P		15 16		20A,1P	SPARE	
	SPARE	20A,1P		17	18	20A,1P	SPARE	
,	SPACE			20		· ·	SPACE	
	SPACE			21 22			SPACE	
	SPACE			23	24		SPACE	
	SPACE			26			SPACE	
	SPACE			27 28			SPACE	
	SPACE			29	30		SPACE	

U. S. COAST GUARD TRAINING CENTER CAPE MAY USCG, TRACEN CAPE MAY 1 MUNRO AVE. CAPE MAY, NJ 08204-5092 MARK DATE DESCRIPTION A/E PROJECT NO: CMS-1130
CAD FILE NAME:
DESIGNED BY: SCM EDITED BY: CHECKED BY: SCALE: AS SHOWN PLOT SCALE: SHEET TITLE MUNRO HALL 2ND FL RENOVATIONS TRACEN NEW JERSEY
BUILDING #261
ELECTRICAL CAPE MAY SCHEDULES REVIEWED BY: REVIEWED BY: R
S MCKAIG K SHILLING
PROJECT ENG. BRANCH CHIEF J POLING, CDR 1/5/07 APPROVING OFFICER DATE PROJECT NUMBER DRAWING NUMBER T05010 T-5680-ED DISCIPLINE/SHT NO SHEET 9 OF 9

CONSULTANTS